

**Proposed Clonberne Wind Farm 220kV Grid Connection,  
Co. Galway  
Planning Permission Application Drawings**






Grid Connection


Drawing No.	Drawing Title	Scale	Page Size
180740 - 100	Location Context Map	1: 50,000	A3
180740 - 101	Site Location Map (Including Site Notice Key Plan	1: 20,000	A3
180740 - 101A	Site Notice Location Map Sheet A	1:2,500	A3
180740 - 101B	Site Notice Location Map Sheet B	1:2,500	A3
180740 - 101C	Site Notice Location Map Sheet C	1:2,500	A3
180740 - 102	Signage Detail	1:20	A3
180740 - 103	Field Gate Detail	1:20	A3
180740 - 104	Access Junction E	As shown	A3
180740 - 105	Access Junction H	As shown	A3
TLI			
05990-DR-101	Site Layout Key Plan Sheet 1 of 2	1: 2,500	A1
05990-DR-102	Site Layout Key Plan Sheet 2 of 2	1: 2,500	A1
05990-DR-103	Site Layout Plan Sheet 1 of 9	1: 500	A1
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05990-DR-105	Site Layout Plan Sheet 3 of 9	1: 500	A1
05990-DR-106	Site Layout Plan Sheet 4 of 9	1: 500	A1
05990-DR-107	Site Layout Plan Sheet 5 of 9	1: 500	A1
05990-DR-108	Site Layout Plan Sheet 6 of 9	1: 500	A1
05990-DR-109	Site Layout Plan Sheet 7 of 9	1: 500	A1
05990-DR-110	Site Layout Plan Sheet 8 of 9	1: 500	A1
05990-DR-111	Site Layout Plan Sheet 9 of 9	1: 500	A1
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05990-DR-114	Site Compound Details	As shown	A2
05990-DR-115	Drainage Details	As shown	A1
05990-DR-116	Gate & Fencing Details	1: 20	A1
05990-DR-117	MV Customer Switchgear Room Plan And Elevations & Section	1: 75	A1
05990-DR-118	220KV GIS Building General Arrangement Ground & First Floor Plans	1: 100	A1
05990-DR-119	220KV GIS Building General Arrangement Section A-A	1: 100	A1
05990-DR-120	220KV GIS Building Elevations Sheet 1 of 2	1: 100	A1
05990-DR-121	220KV GIS Building Roof Plan & Elevations Sheet 2 of 2	1: 100	A1
05990-DR-122	Lightning Monopole Details - 18m Mast	As shown	A2
05990-DR-123	Ducting Through Public Road With and Without Peat	1: 50	A1
05990-DR-124	Ducting Through Access Road With and Without Peat	1: 50	A1
05990-DR-125	Ducting In Bog Road	1: 50	A3
05990-DR-126	Telecoms Tower	1: 100	A1
05990-DR-127	Bridge 1 - Proposed Crossing Details	As shown	A1
05990-DR-128	Trench Sections for Crossing Existing Culverts/Services	As shown	A1
05990-DR-129	Trench Sections for Crossing Watermain/Wastewater	As shown	A1
05990-DR-130	220kV Joint Bay Section Detail	As shown	A1
05990-DR-131	Cable Compound Layout Details	1: 200	A1
05990-DR-132	Cable Compound Sections	As shown	A1
05990-DR-133	Compound Gantry - Tower Elevations	1: 100	A1
05990-DR-134	Battery Container - Plan, Elevations & Section	1: 100	A3
Gavin & Doherty Geosolutions			
20021-GDG-ZZ-XX-DR-C-0100	Access Road Standard Details	N.T.S.	A1
20021-GDG-ZZ-XX-DR-C-0101	Cable Trench Standard Details	N.T.S.	A1
Hydro Environmental Services Ltd.			
P1508-0_D101_GC	Proposed Drainage Layout	1:2,000	A1
P1508-0_D501	Proposed Drainage Details	As shown	A1
P1508-0_D502	Proposed Drainage Details	As shown	A1



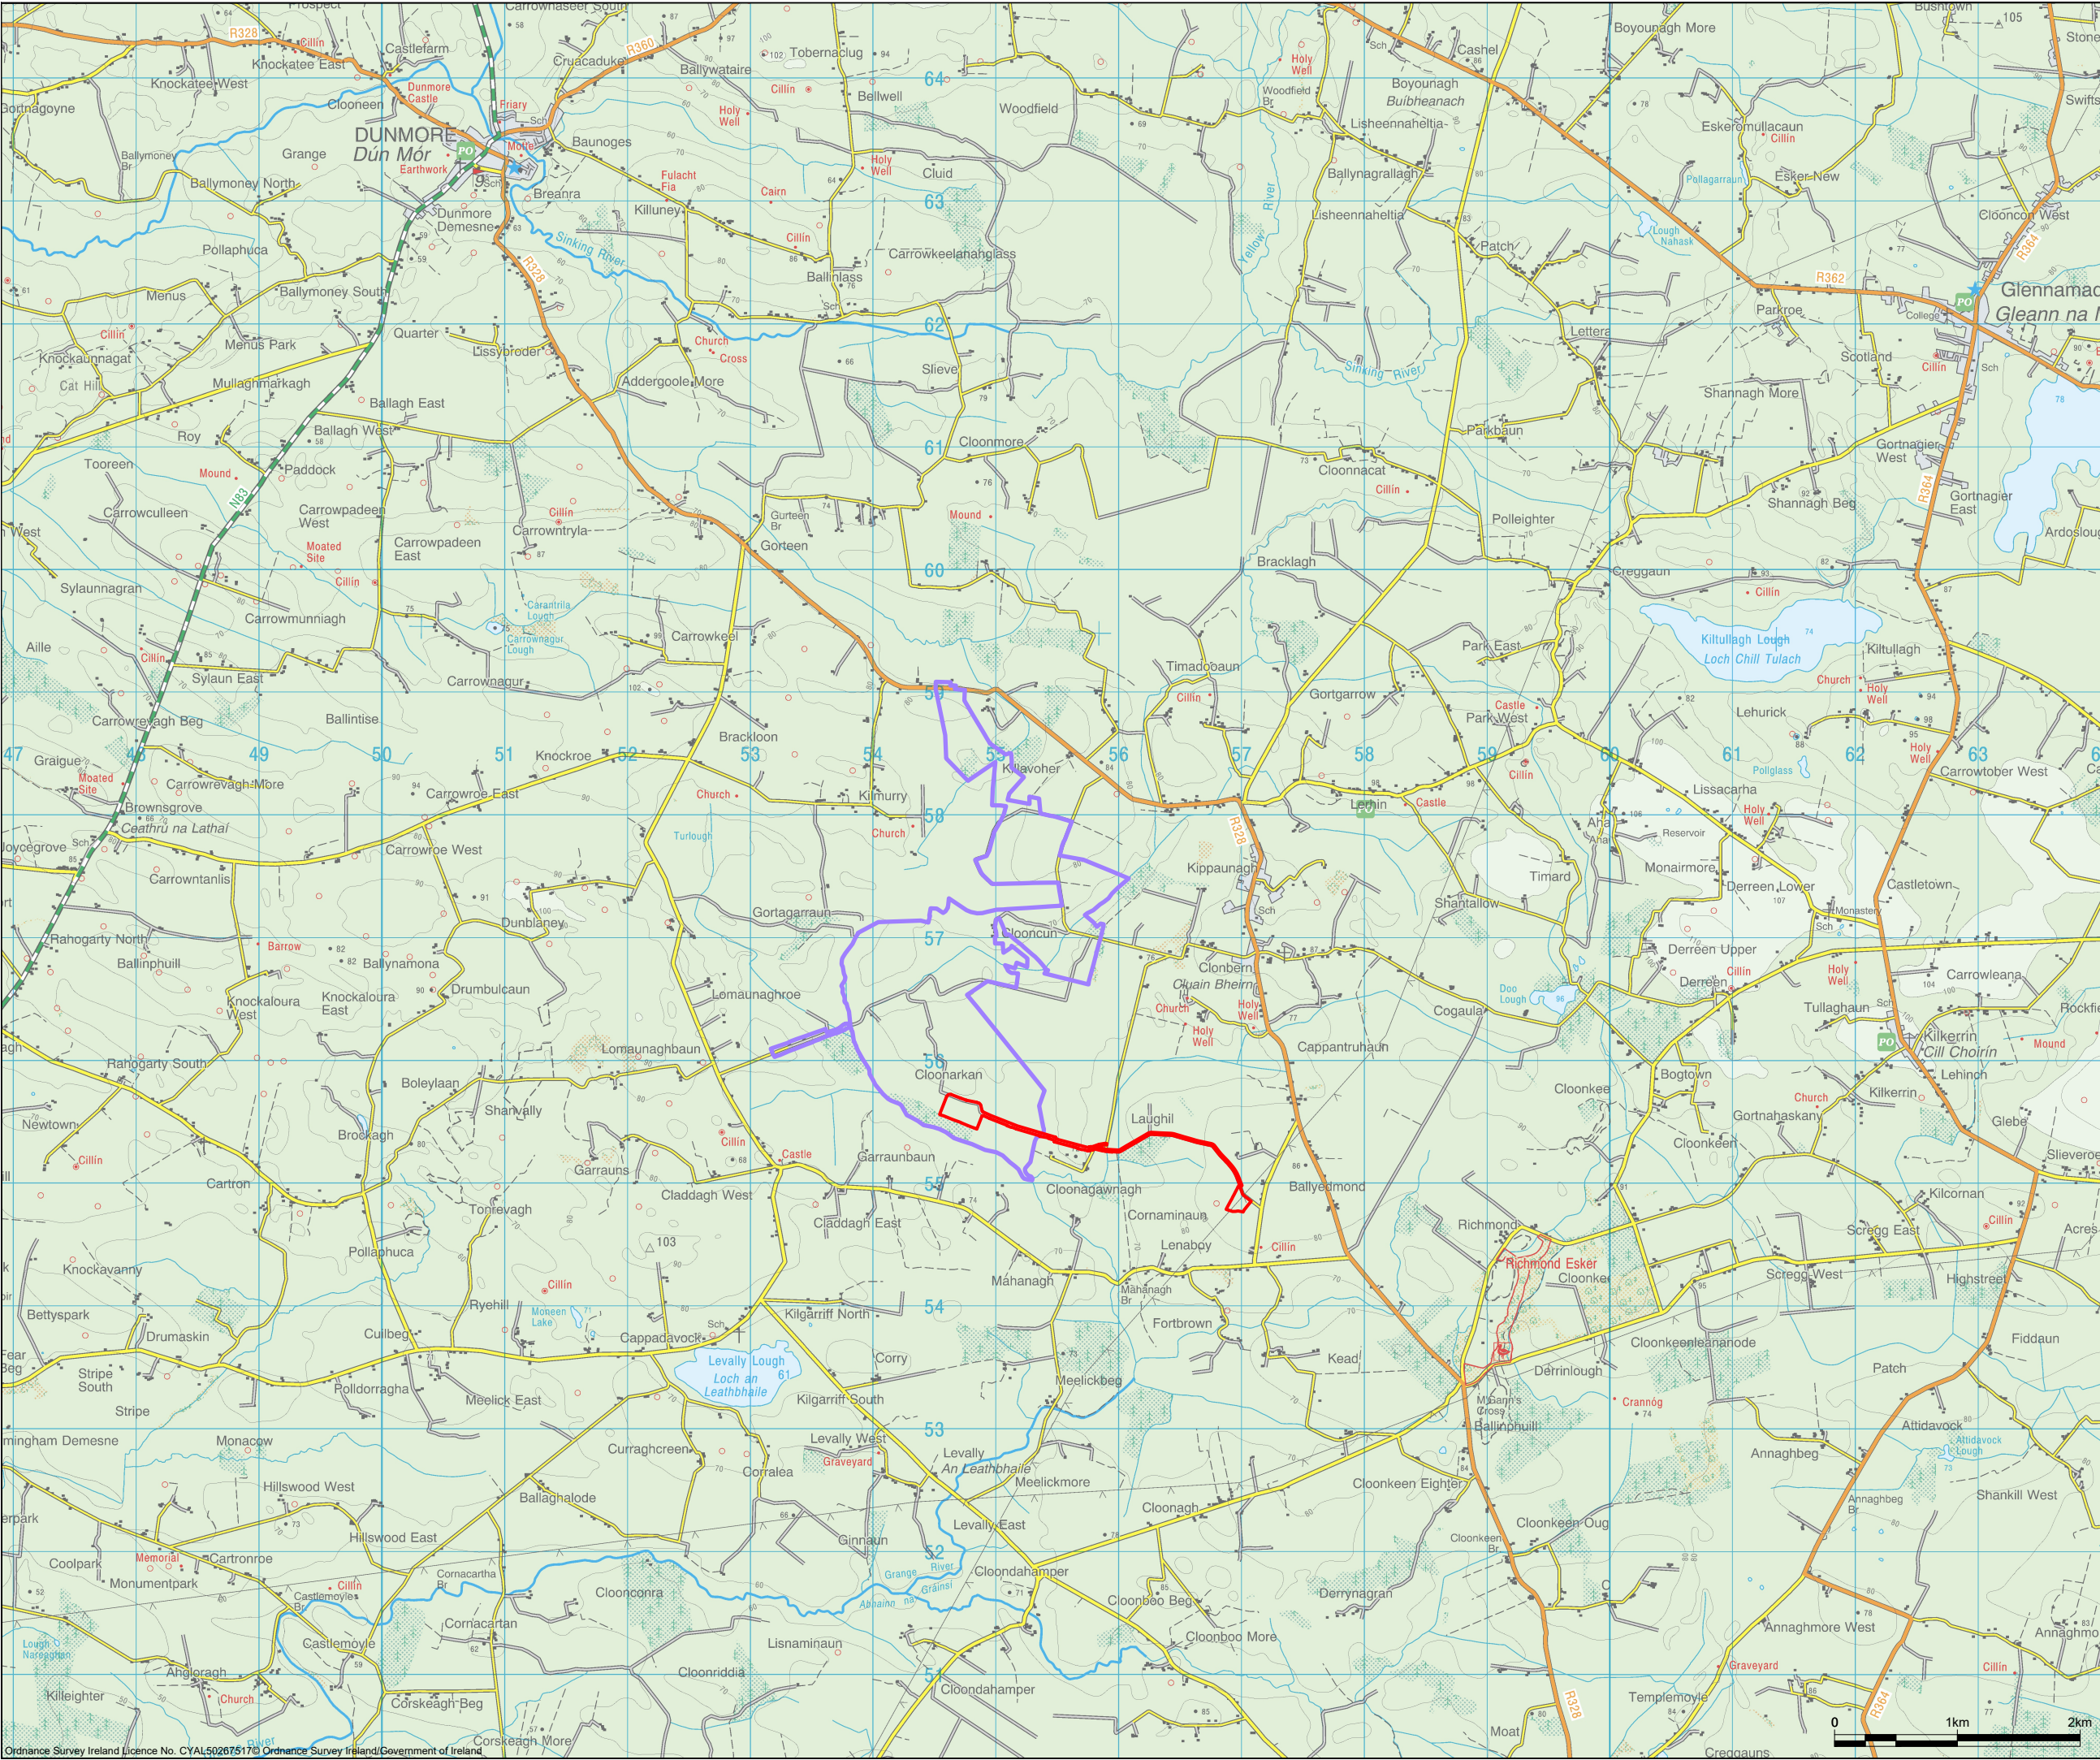

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  7. Exact location of cable/joint bay in the road cut/ridge to be subject to ESB specifications and agreement with Galway County Council.

- Drawing Legend**
- Planning Application Boundary
  - Clonberne Windfarm Boundary Line Subject to a Separate Application

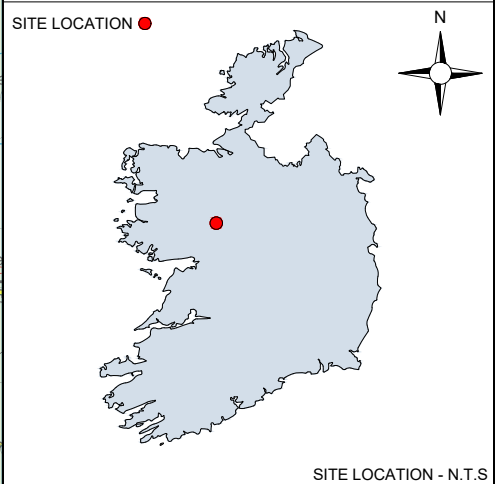


PROJECT TITLE: <b>Clonberne Wind Farm 220kV Grid Connection, Co. Galway.</b>		
DRAWING TITLE: <b>Location Context Map</b>		
PROJECT No.: <b>180740</b>	DRAWING No.: <b>180740 - 100</b>	SCALE: <b>1:50,000 @ A3</b>
DRAWN BY: <b>GO</b>	CHECKED BY: <b>N/A</b>	DATE: <b>27.06.2024</b>
OS SHEET No.: <b>OS1424, OS1426, OS1624, OS1626</b>		



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**Drawing Legend**


- Planning Application Boundary
- Landowners Boundary
- X Site Notice
- Wayleaves

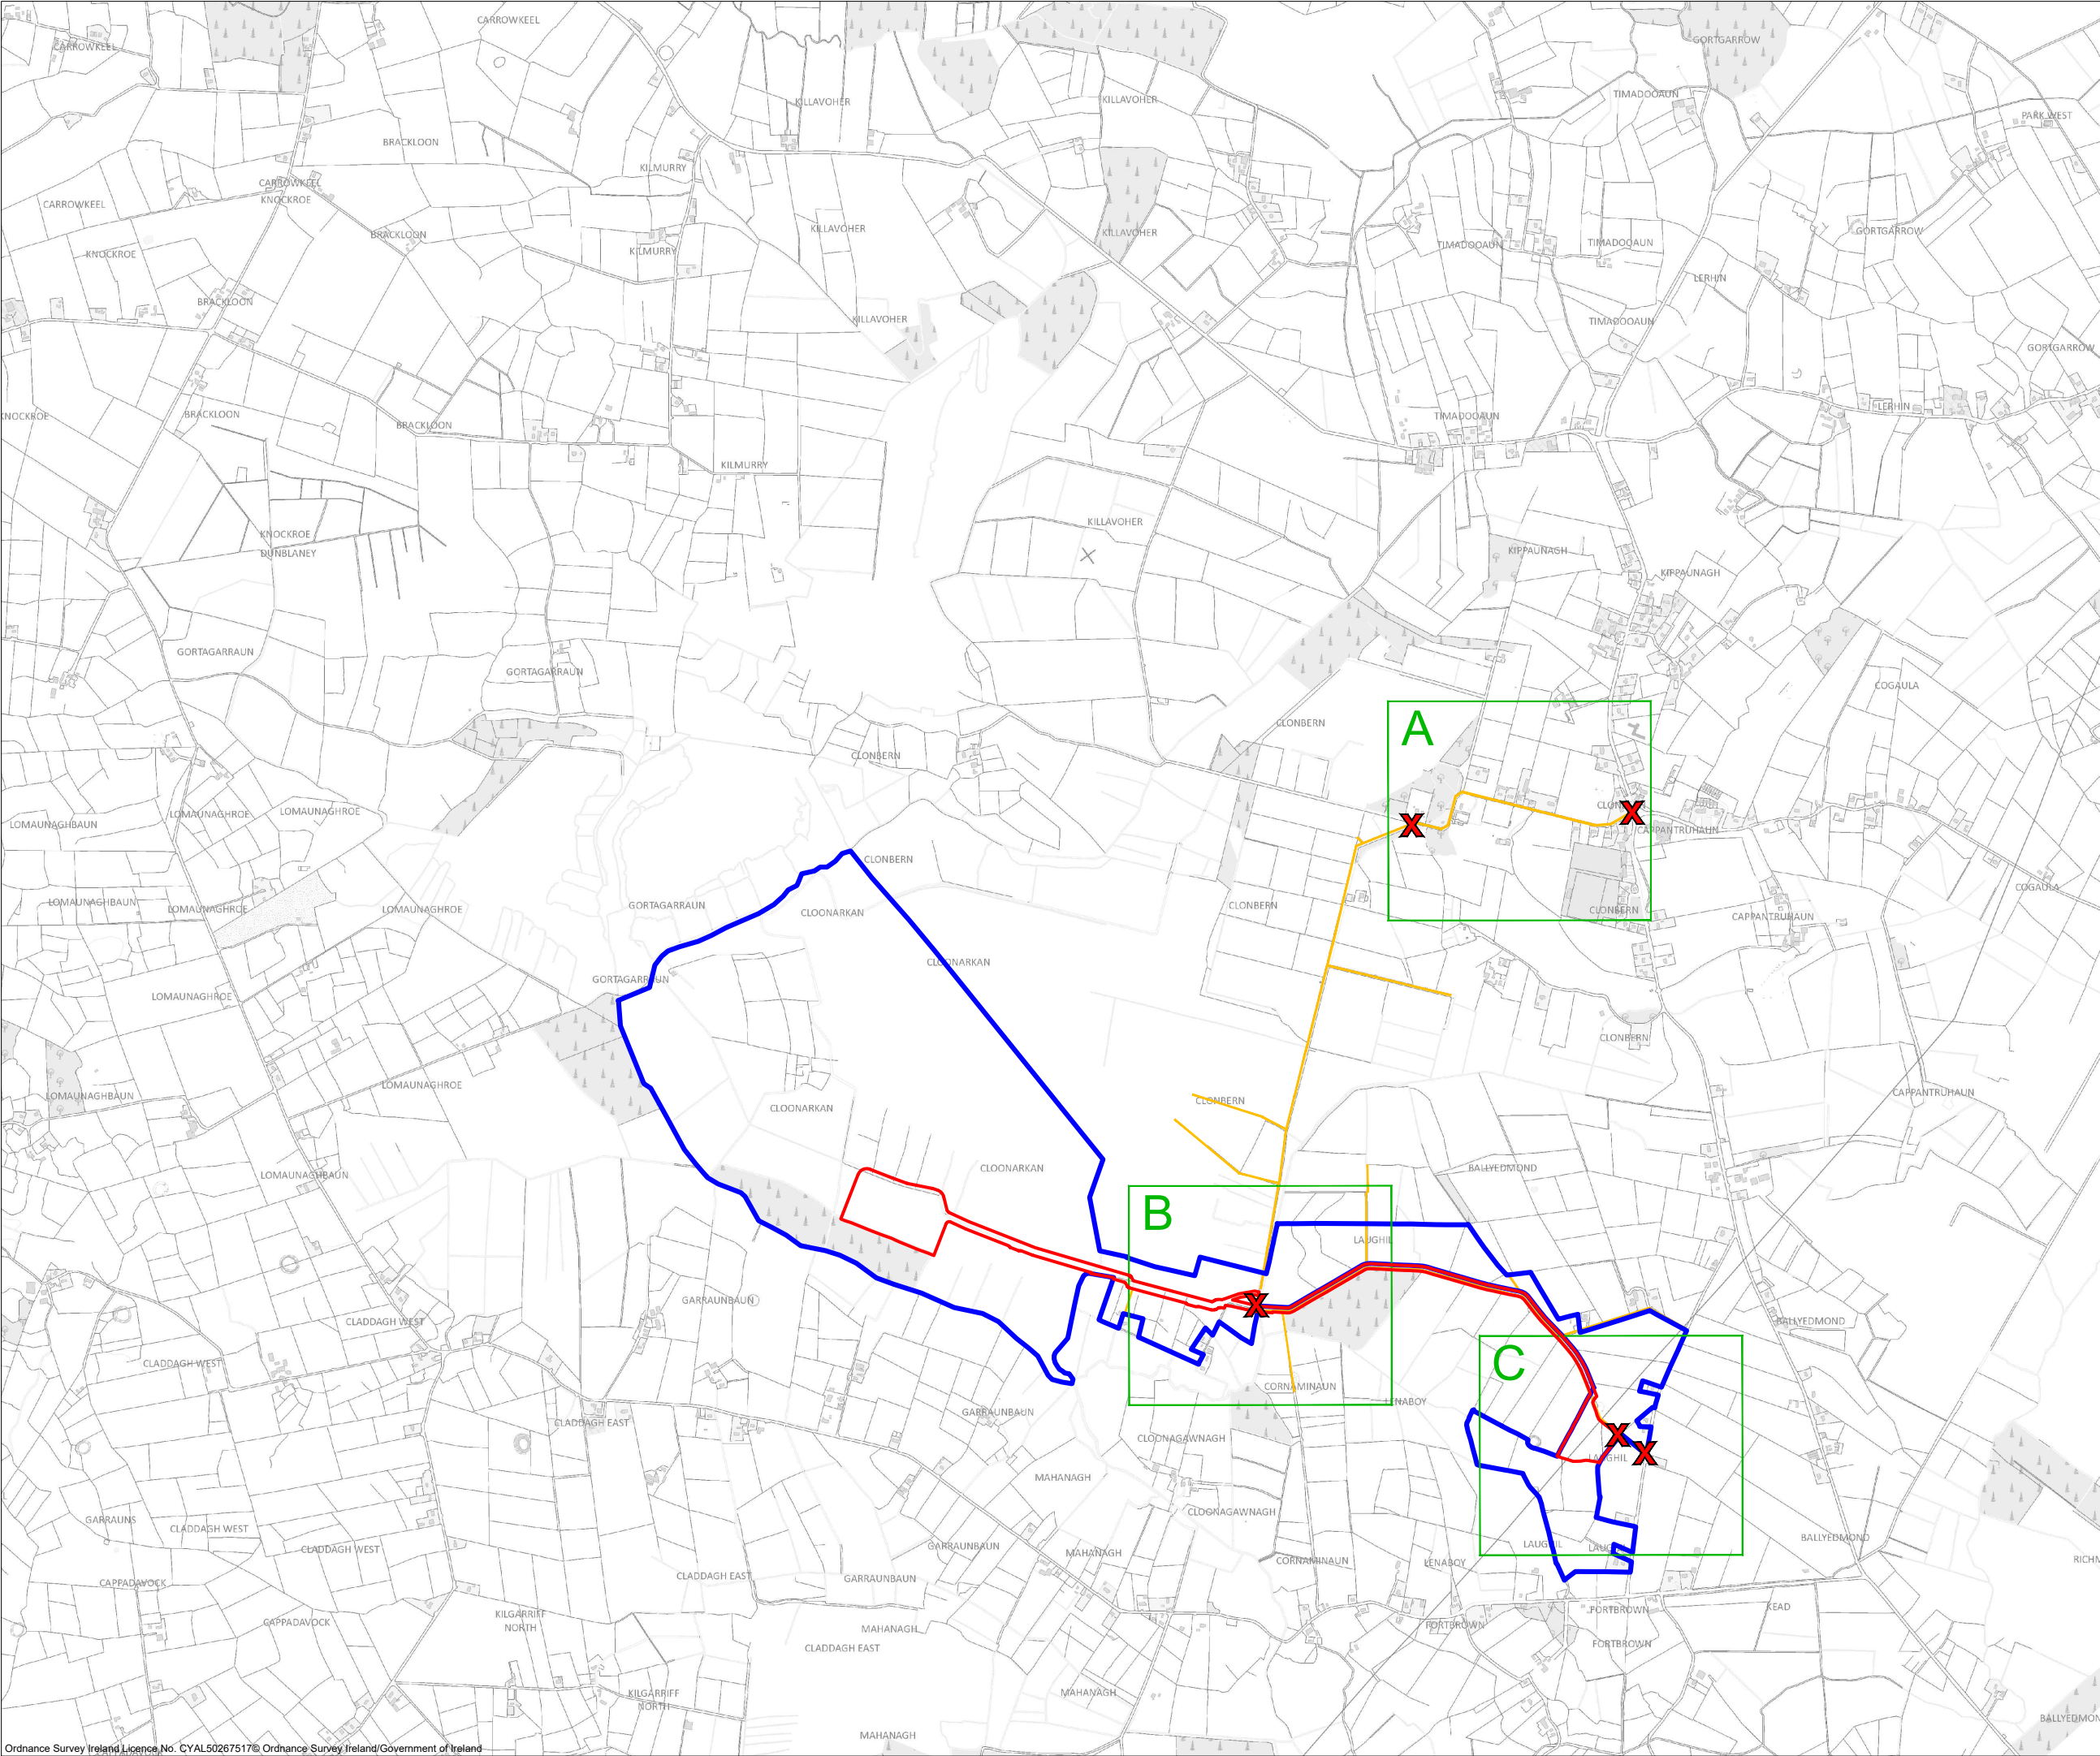PROJECT TITLE: <b>Clonberne Wind Farm 220kV Grid Connection, Co. Galway.</b>			
DRAWING TITLE: <b>Site Location Map (Including Site Notice Key Plan)</b>			
PROJECT No.: <b>180740</b>	DRAWING No.: <b>180740 - 101</b>	SCALE: <b>1:20,000 @ A3</b>	
DRAWN BY: <b>GO</b>	CHECKED BY: <b>N/A</b>	DATE: <b>10.06.2024</b>	REVISION:. <b>D01</b>
OS SHEET No.:		2679, 2680, 2748, 2749	



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**Drawing Legend**

X

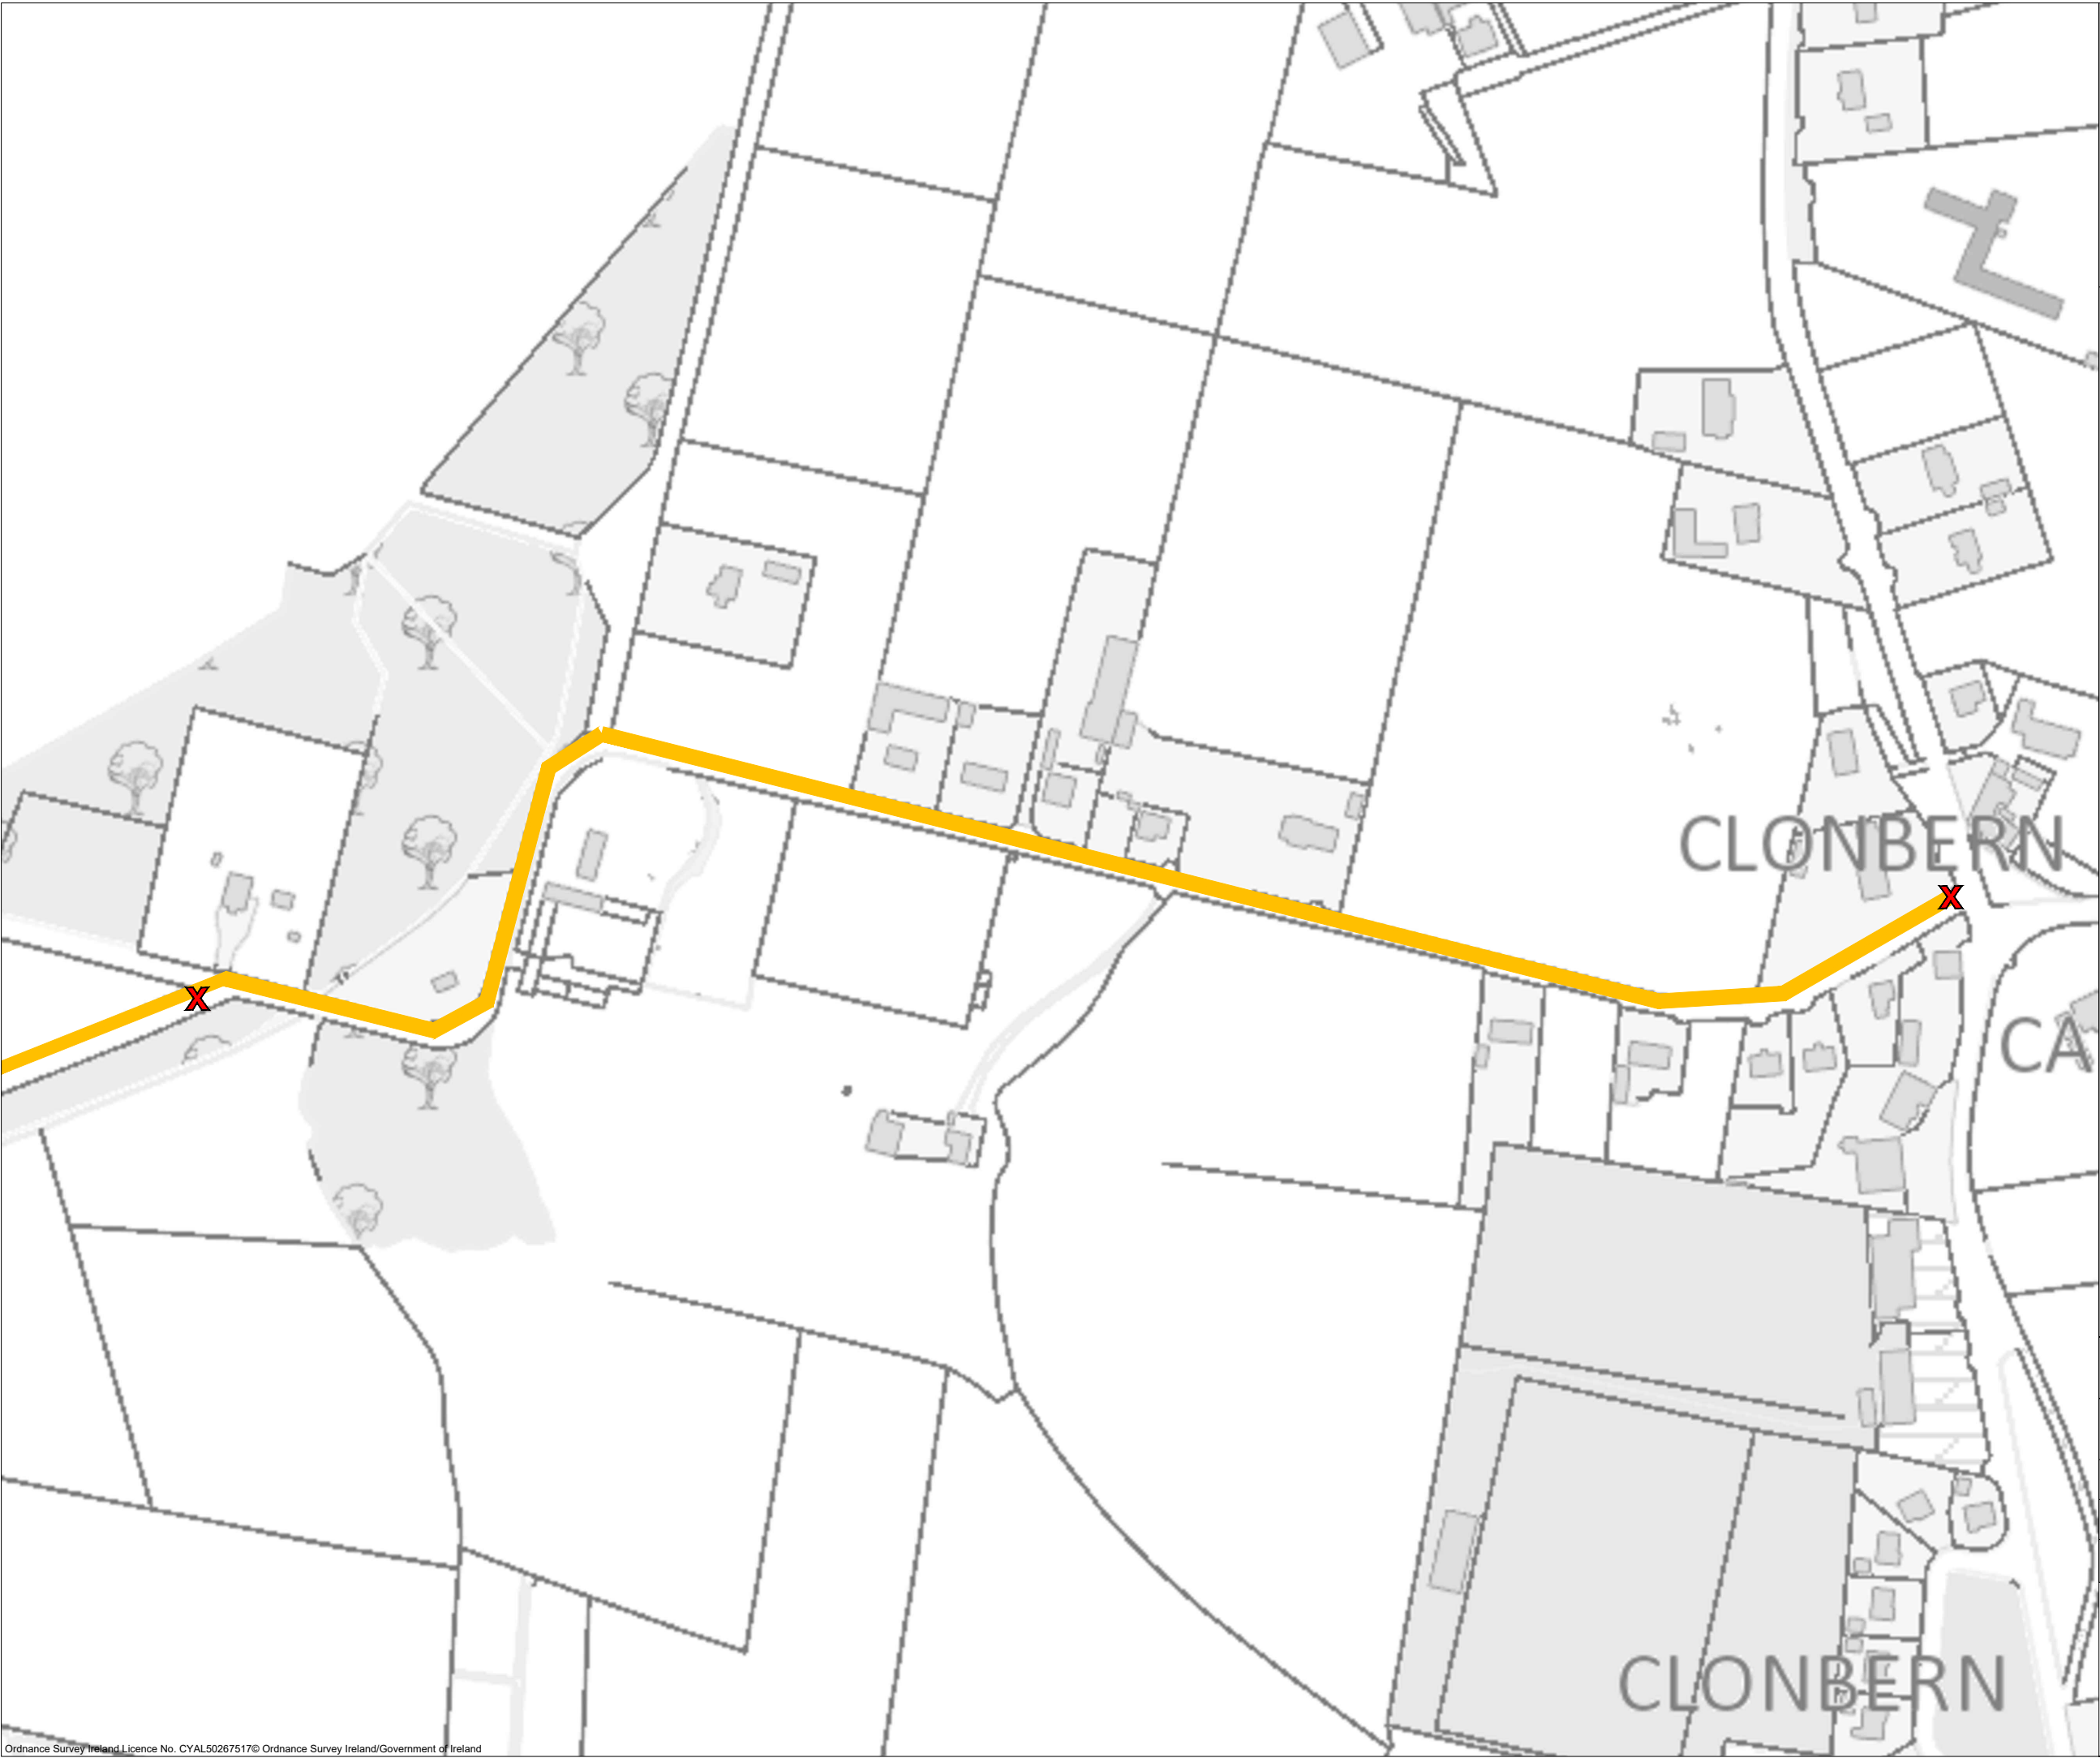Site Notice


Wayleaves



PROJECT TITLE: <b>Clonberne Wind Farm 220kV Grid Connection, Co. Galway.</b>			
DRAWING TITLE: <b>Site Notice Location Map Sheet A</b>			
PROJECT No.: <b>180740</b>	DRAWING No.: <b>180740 - 101A</b>	SCALE: <b>1:2,500 @ A3</b>	
DRAWN BY: <b>GO</b>	CHECKED BY: <b>N/A</b>	DATE: <b>10.06.2024</b>	REVISION.: <b>D01</b>
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**Drawing Legend**


- Planning Application Boundary
- Landowners Boundary
- Site Notice
- Wayleaves

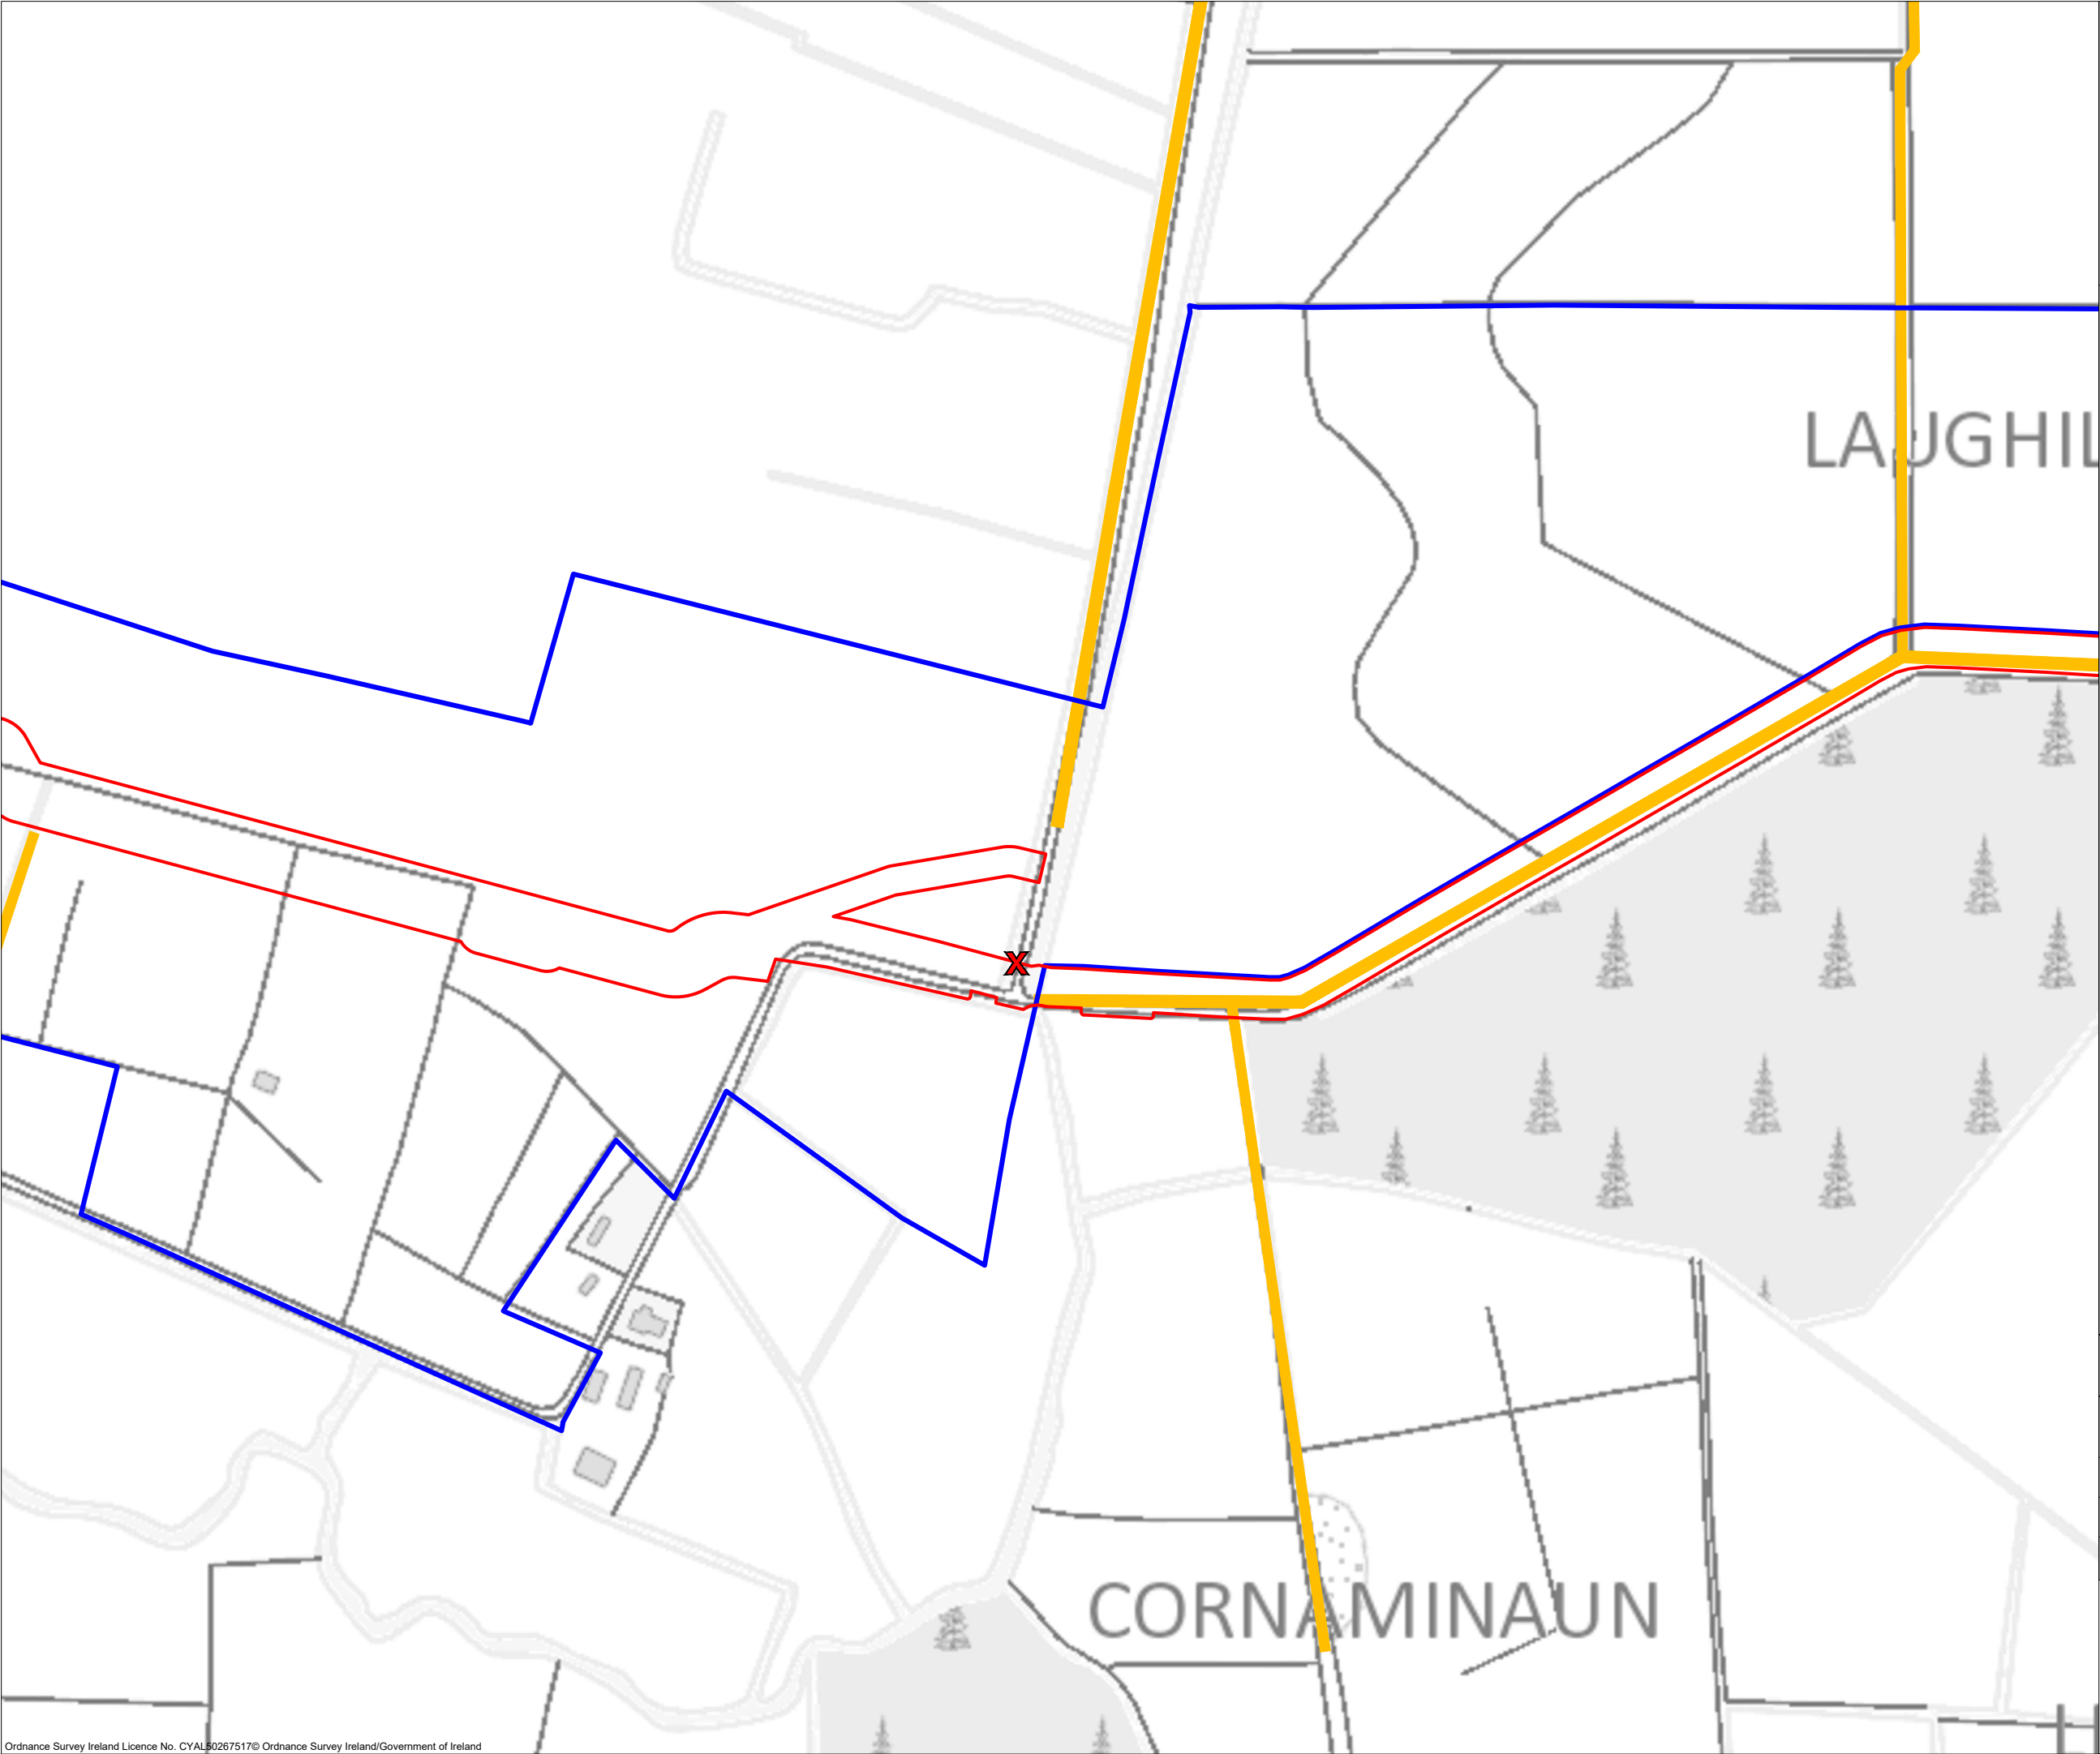

PROJECT TITLE: <b>Clonberne Wind Farm 220kV Grid Connection, Co. Galway.</b>			
DRAWING TITLE: <b>Site Notice Location Map Sheet B</b>			
PROJECT No.: <b>180740</b>	DRAWING No.: <b>180740 - 101B</b>	SCALE: <b>1:2,500 @ A3</b>	
DRAWN BY: <b>GO</b>	CHECKED BY: <b>N/A</b>	DATE: <b>10.06.2024</b>	REVISION.: <b>D01</b>
OS SHEET No.: 2679, 2680, 2748, 2749			



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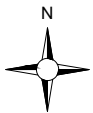

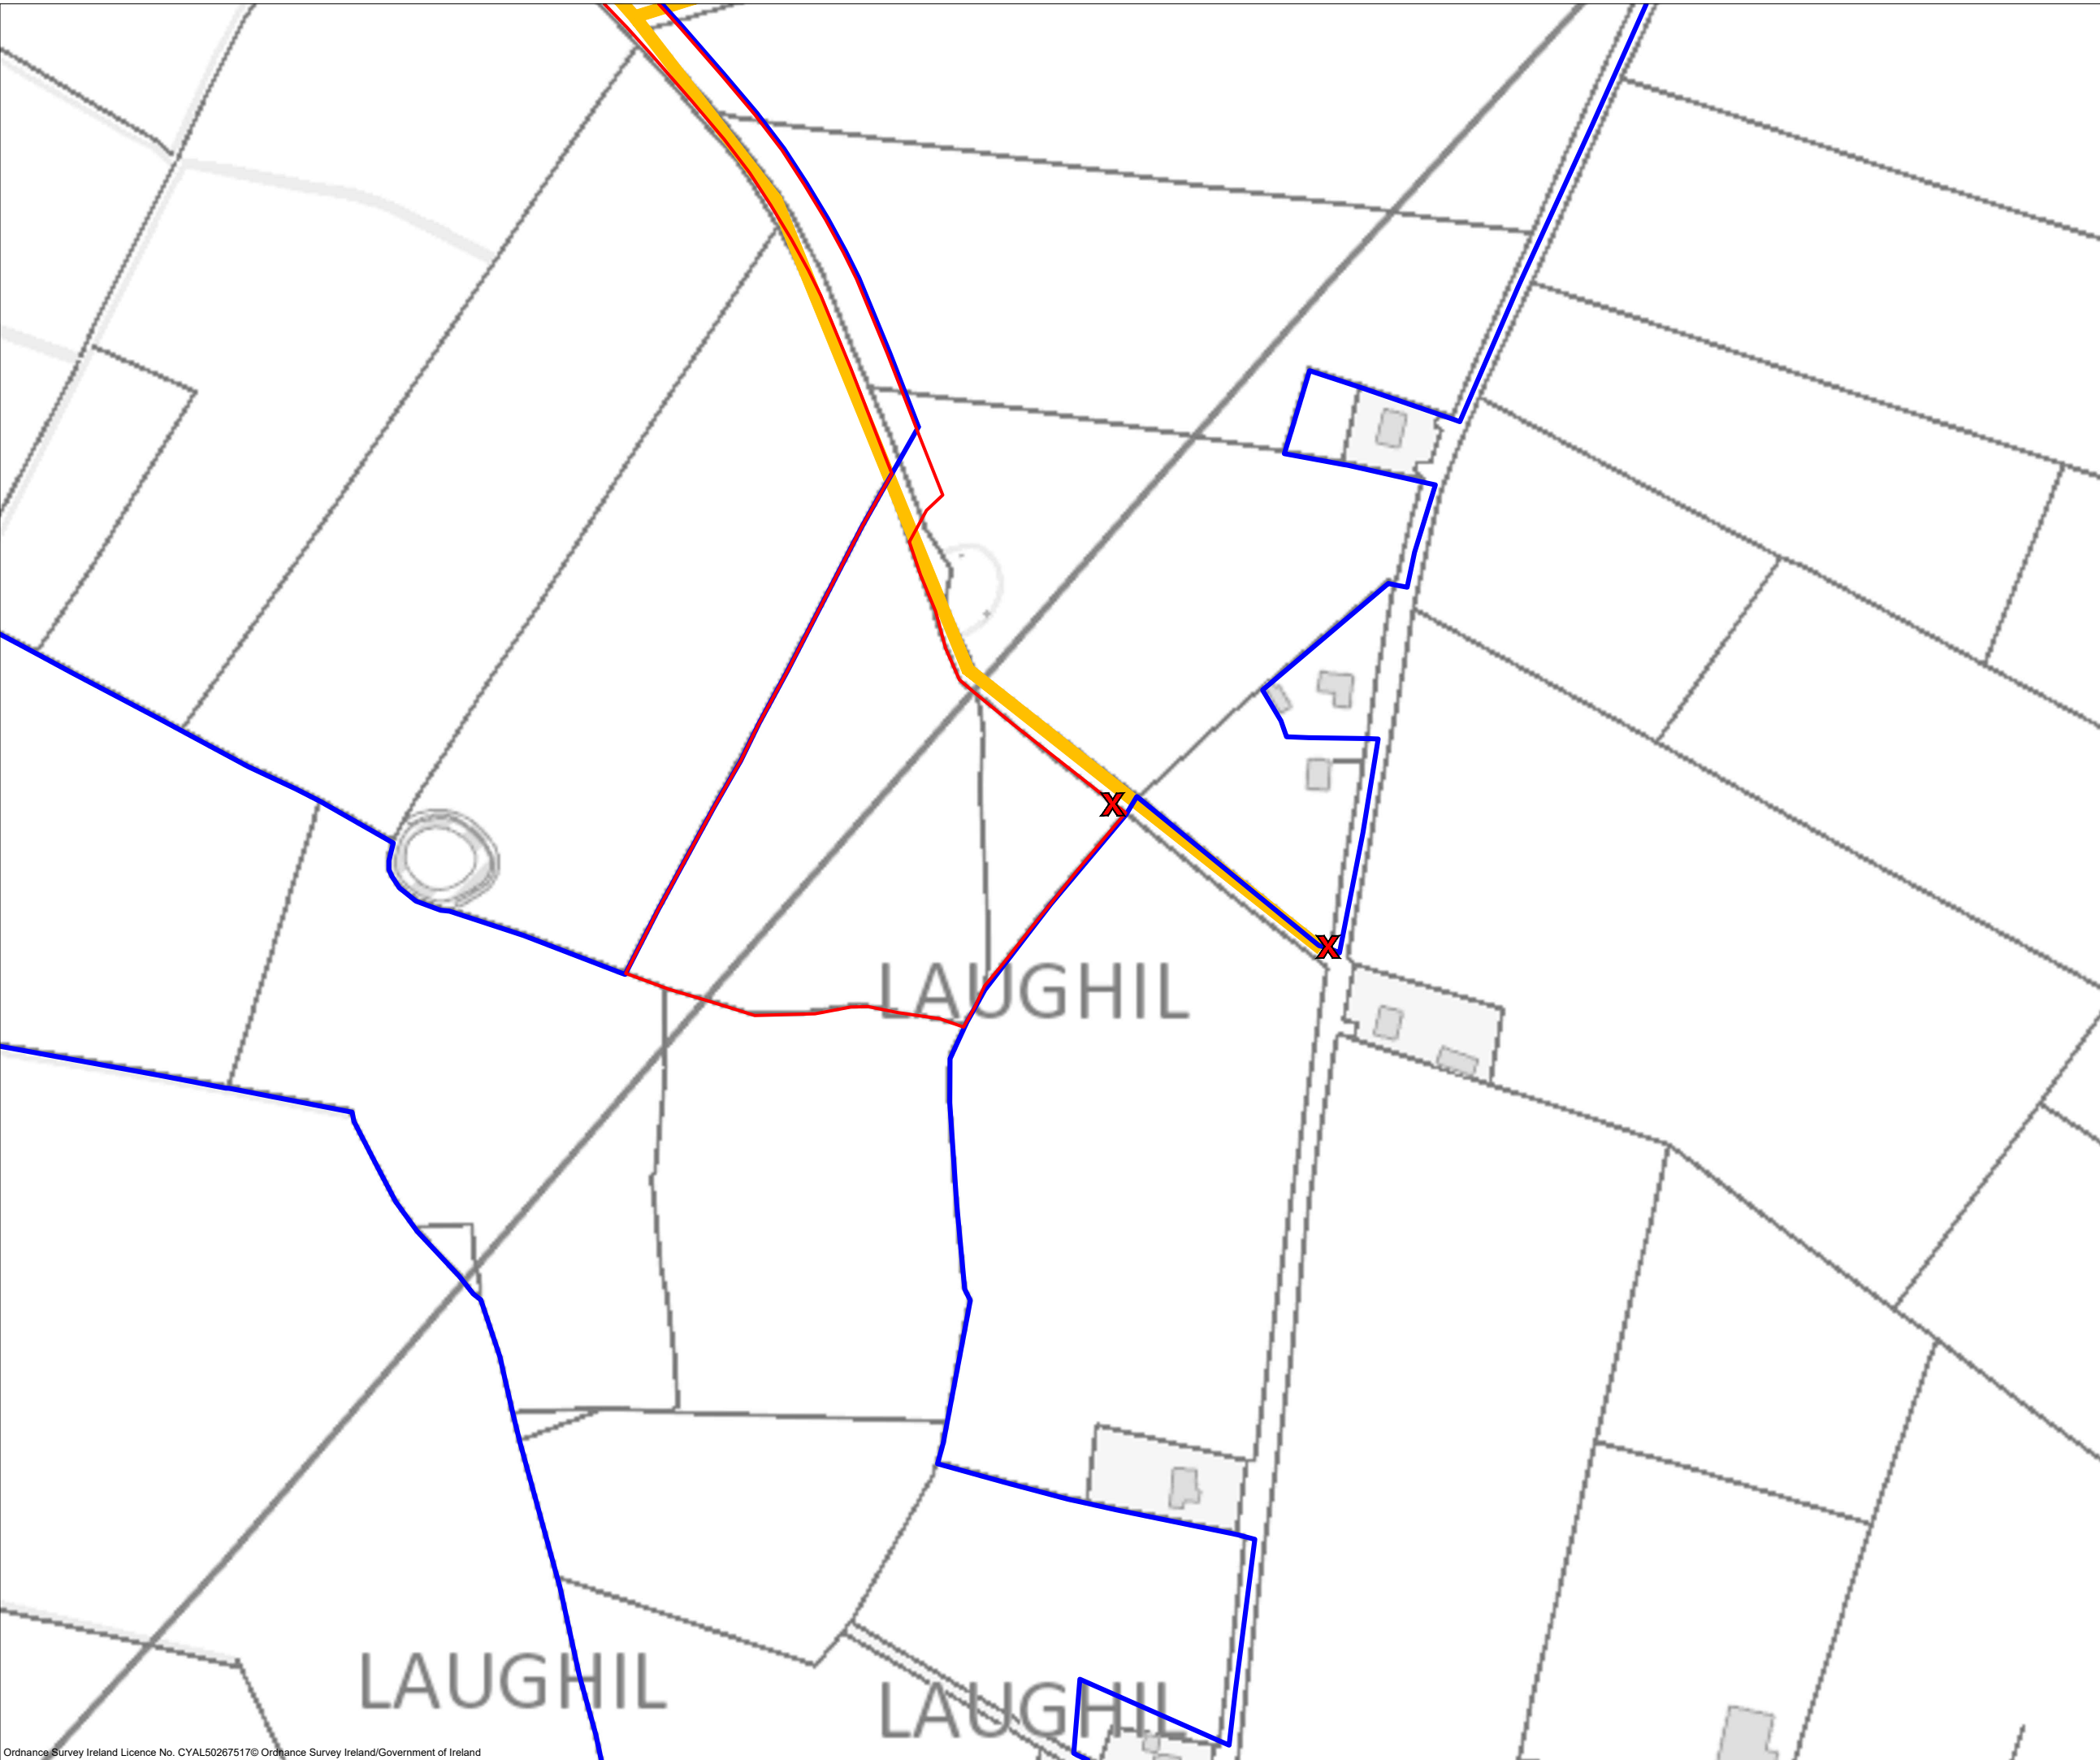
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**Drawing Legend**

- Planning Application Boundary
- Landowners Boundary
- X Site Notice
- Wayleaves



PROJECT TITLE:  
**Clonberne Wind Farm 220kV Grid Connection, Co. Galway.**

DRAWING TITLE:  
**Site Notice Location Map Sheet C**


PROJECT No.: <b>180740</b>		DRAWING No.: <b>180740 - 101C</b>	SCALE: <b>1:2,500 @ A3</b>
DRAWN BY: <b>GO</b>	CHECKED BY: <b>N/A</b>	DATE: <b>10.06.2024</b>	REVISION.: <b>D01</b>

OS SHEET No.: 2679, 2680, 2748, 2749




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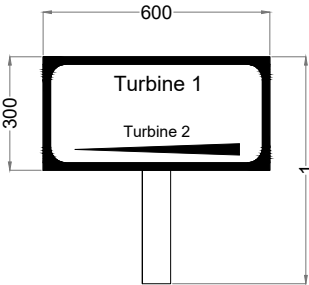
**Note**  
For illustrative purposes only  
exact details to be confirmed

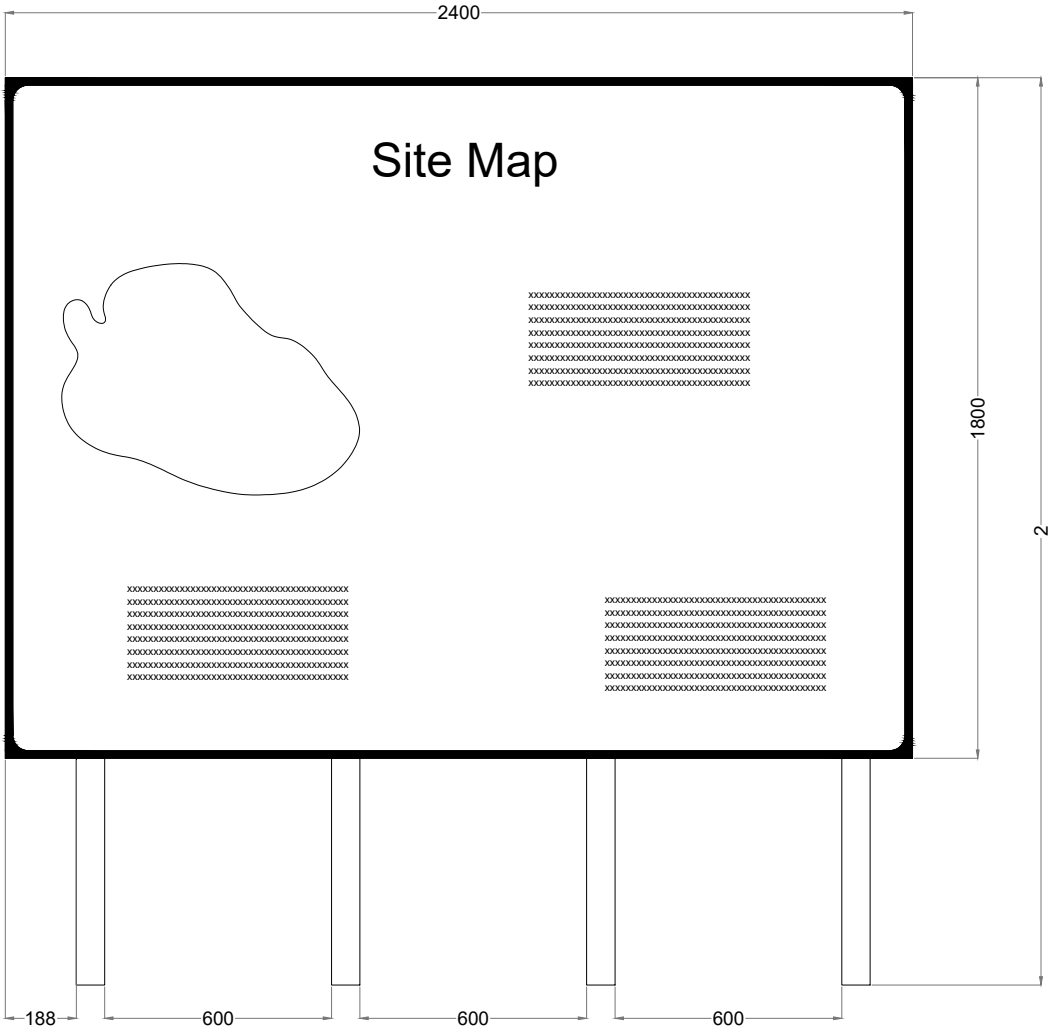

Signage Type A - Waypoint Map Signage

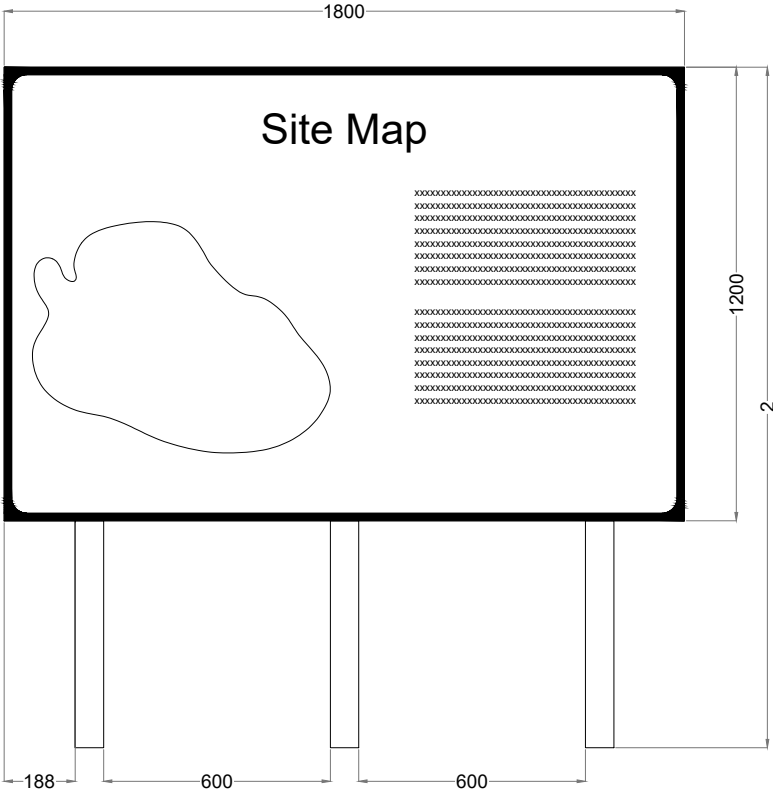

Signage Type B -Entry Point Signage




Signage Type C - Way Point Direction Signage

PROJECT TITLE: <b>Clonberne Wind Farm 220kV Grid Connection, Co. Galway.</b>			
DRAWING TITLE: <b>Signage Detail</b>			
PROJECT No.: <b>180740</b>	DRAWING No.: <b>180740 - 102</b>	SCALE: <b>1:20 @ A3</b>	
DRAWN BY: <b>GO</b>	CHECKED BY: <b>N/A</b>	DATE: <b>10.06.2024</b>	REVISION.: <b>D01</b>







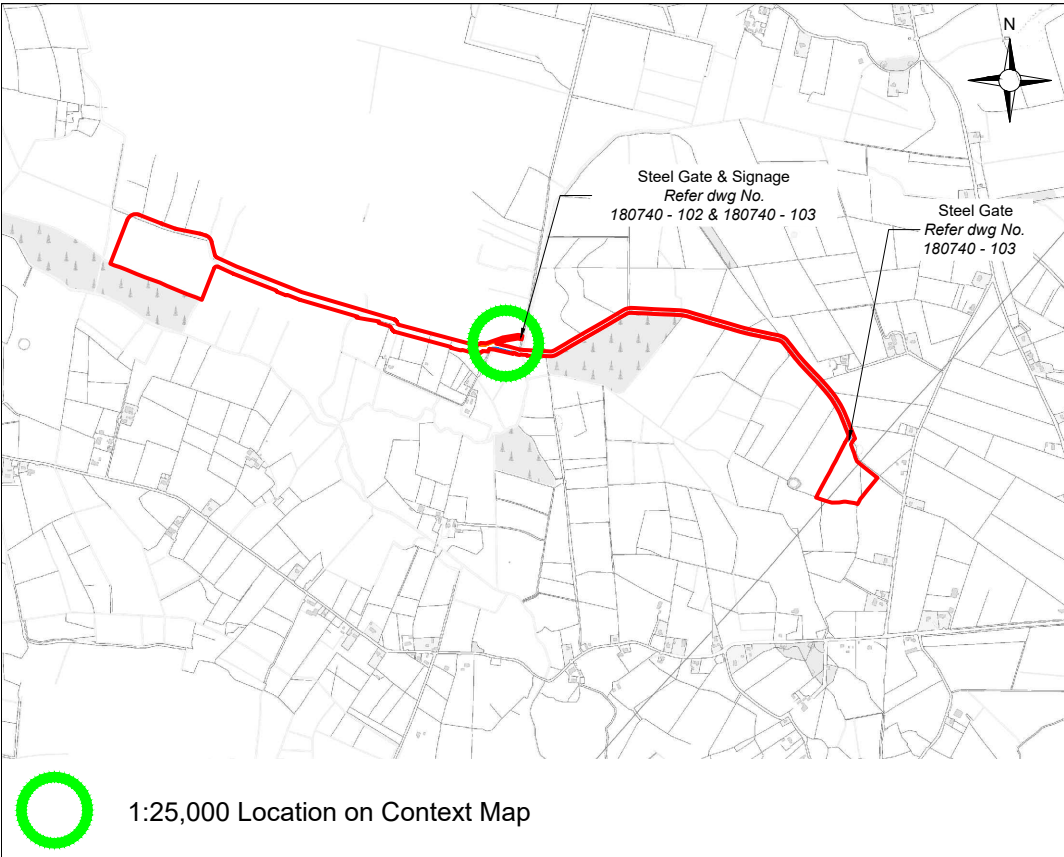

1:25,000 Location on Context Map

# Access Junction E

Junction markings to be as per Figure 7.35 of the Traffic Signs Manual

- Centreline RM 001
- STOP line RRM 017
- STOP lettering M114.

Junction stop signs to be as per RUS 027 of the Traffic Signs Manual.



## Drawing Legend

- Existing Road Edge
- Proposed Road
- Sight Line


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DRAWING TITLE: <b>Access Junction E</b>			
PROJECT No.: <b>180740</b>	DRAWING No.: <b>180740 - 104</b>	SCALE: <b>As shown @ A3</b>	
DRAWN BY: <b>GO</b>	CHECKED BY: <b>N/A</b>	DATE: <b>10.06.2024</b>	REVISION.: <b>D01</b>




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Scale: 1:500



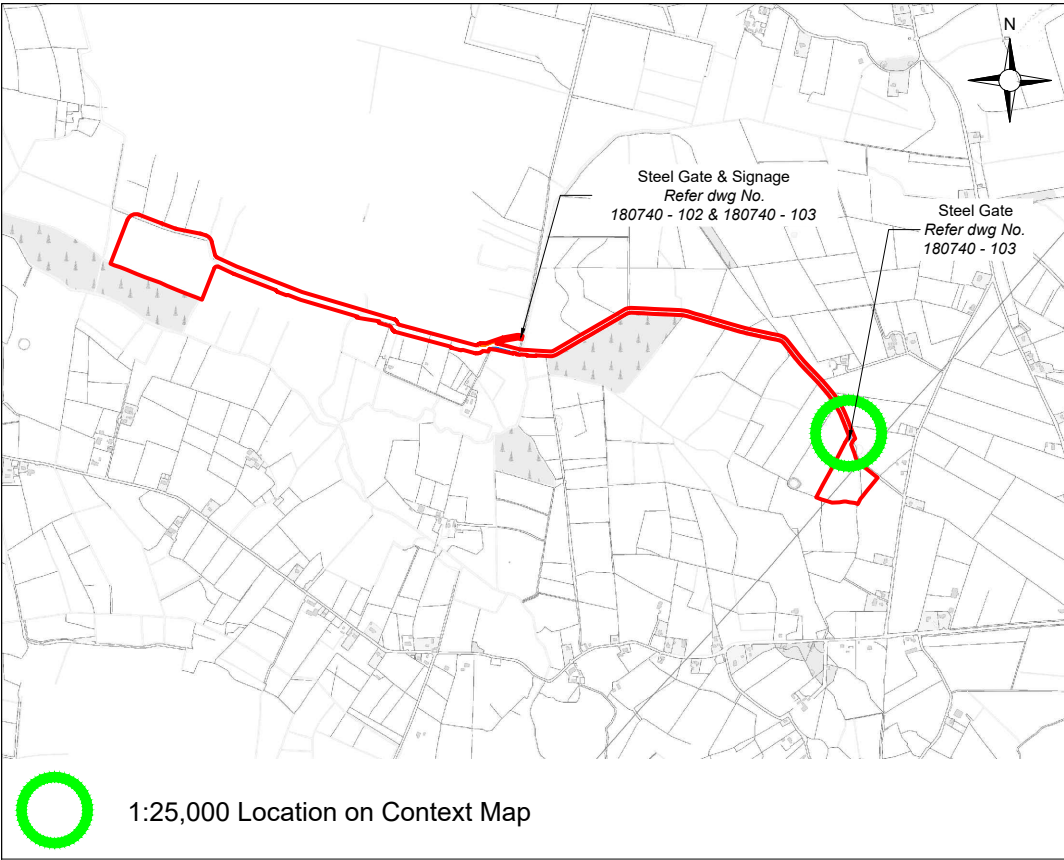

1:25,000 Location on Context Map

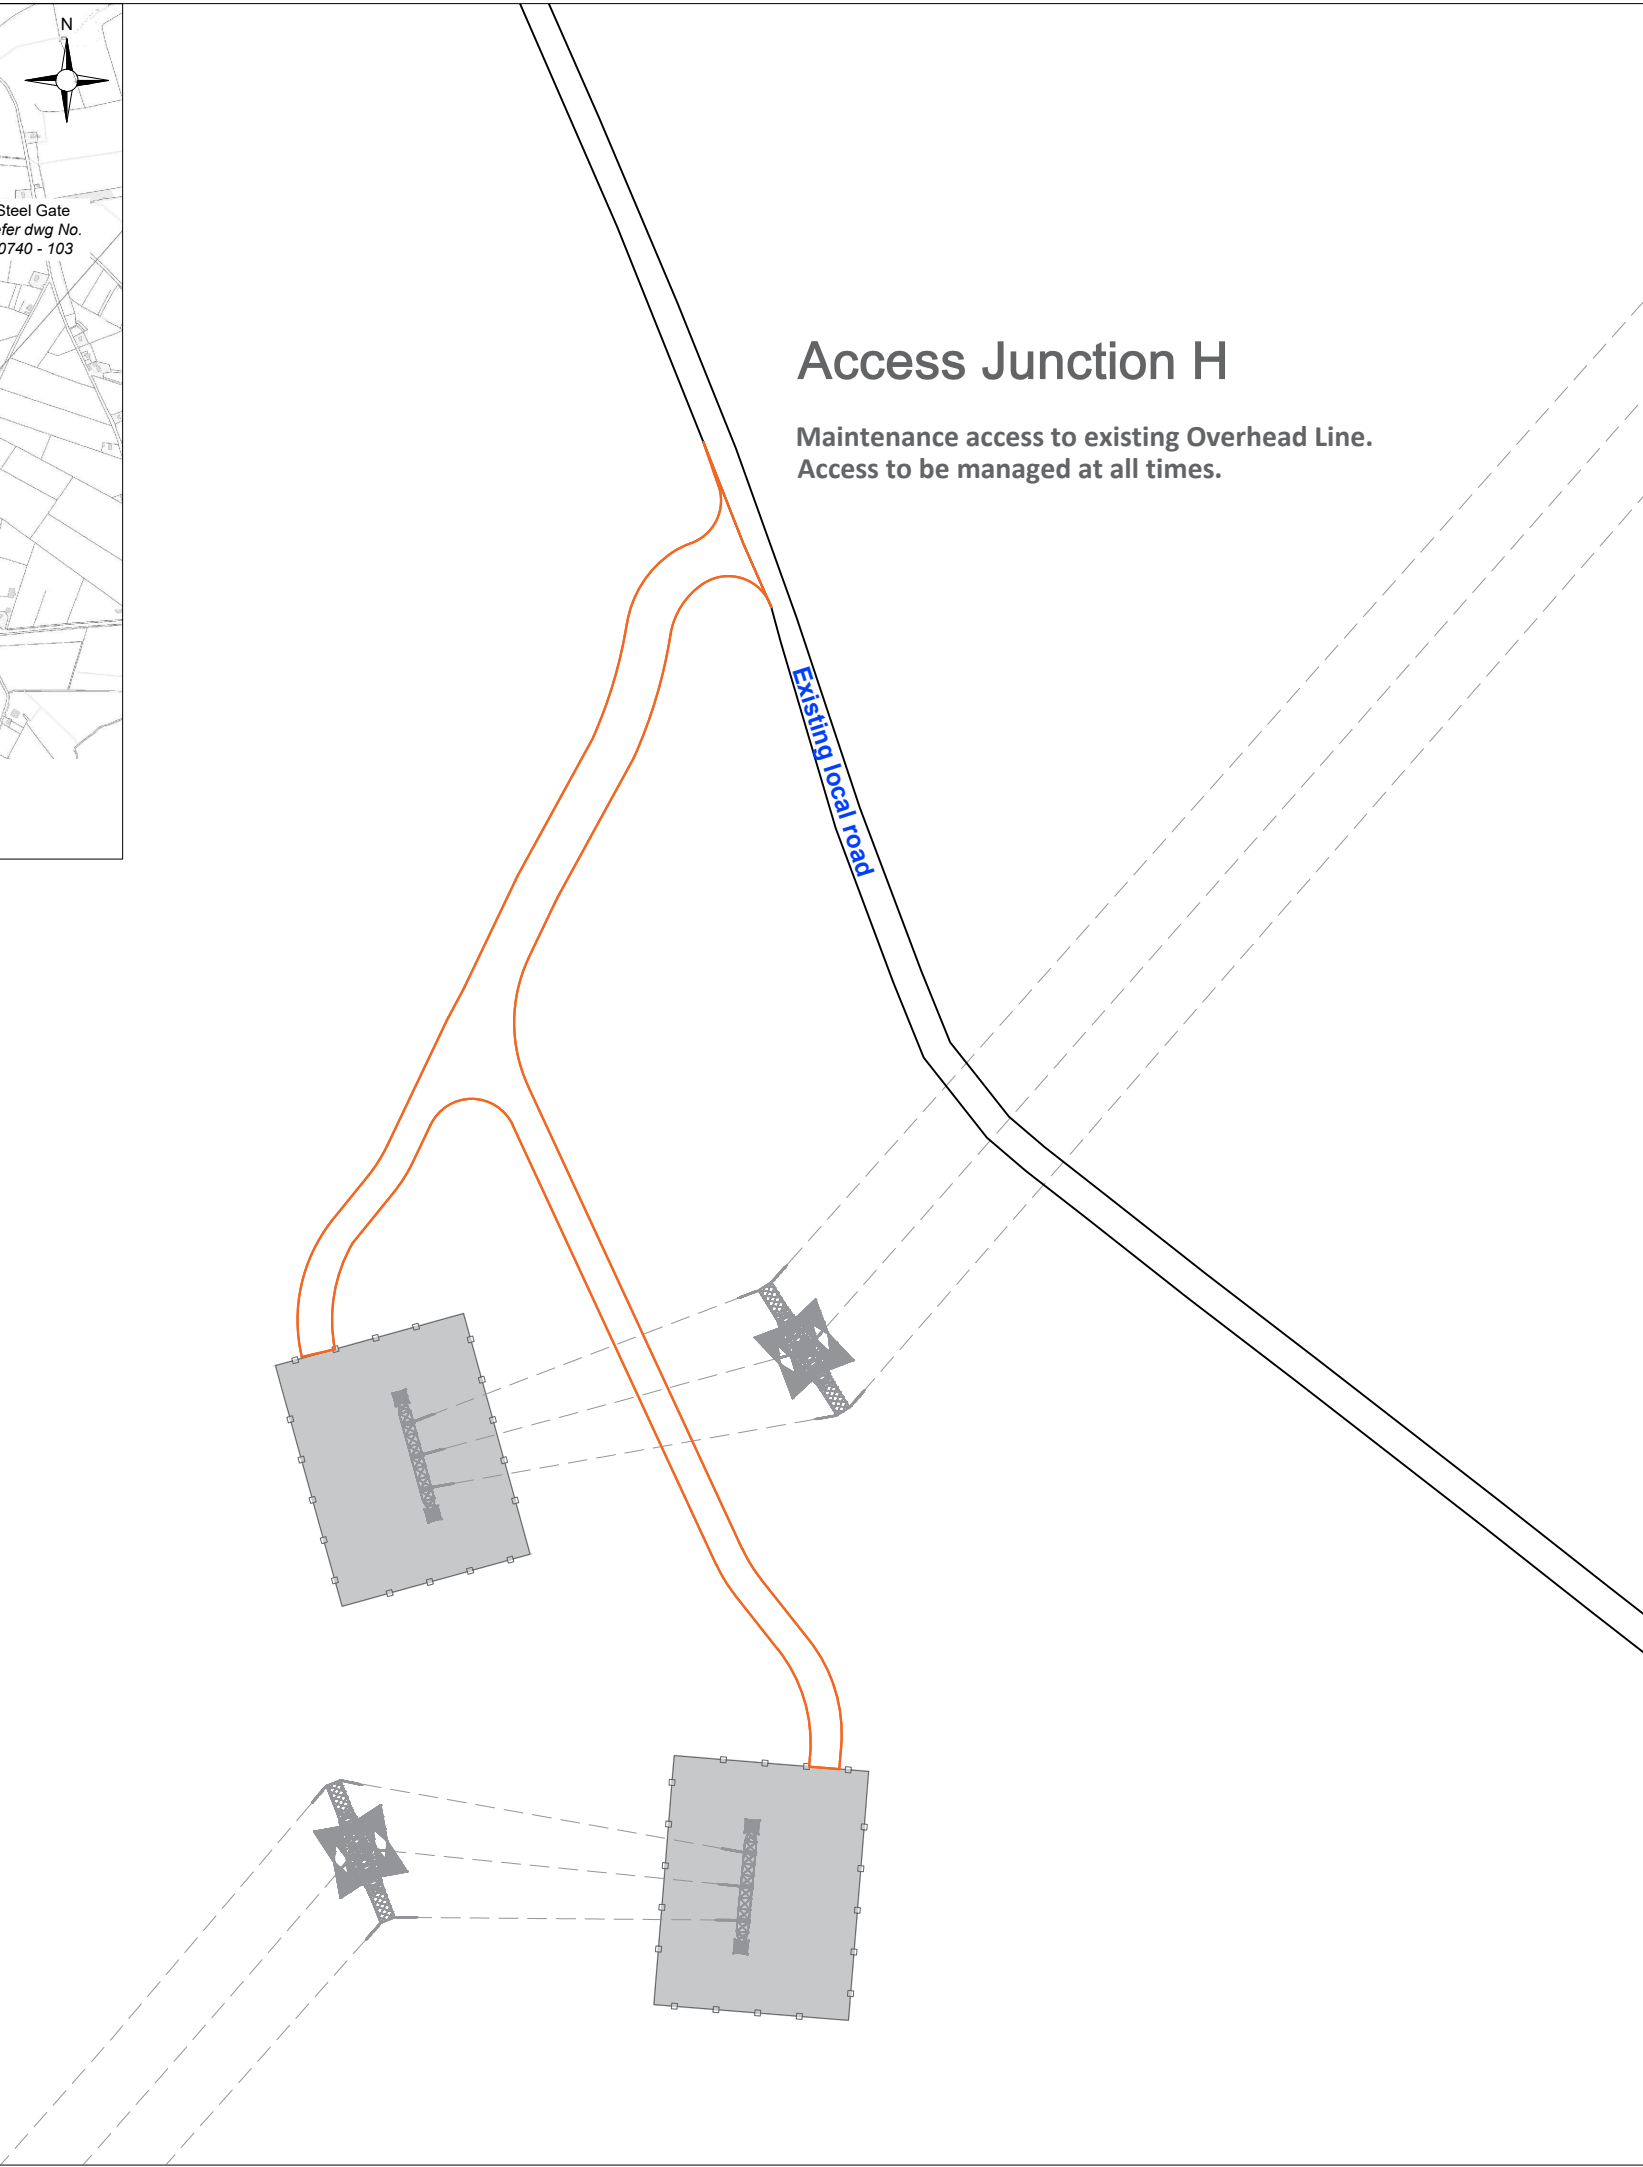

# Access Junction H

Maintenance access to existing Overhead Line.  
Access to be managed at all times.

## Drawing Legend

- Existing Road Edge
- Proposed Road


PROJECT TITLE: Clonberne Wind Farm 220kV Grid Connection, Co. Galway.			
DRAWING TITLE: Access Junction H			
PROJECT No.: 180740	DRAWING No.: 180740 - 105	SCALE: As shown @ A3	
DRAWN BY: GO	CHECKED BY: N/A	DATE: 10.06.2024	REVISION.: D01




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ISO A1 594mm x 841mm

Project Management Initials: Designer: JF Checked: AC Approved: RG

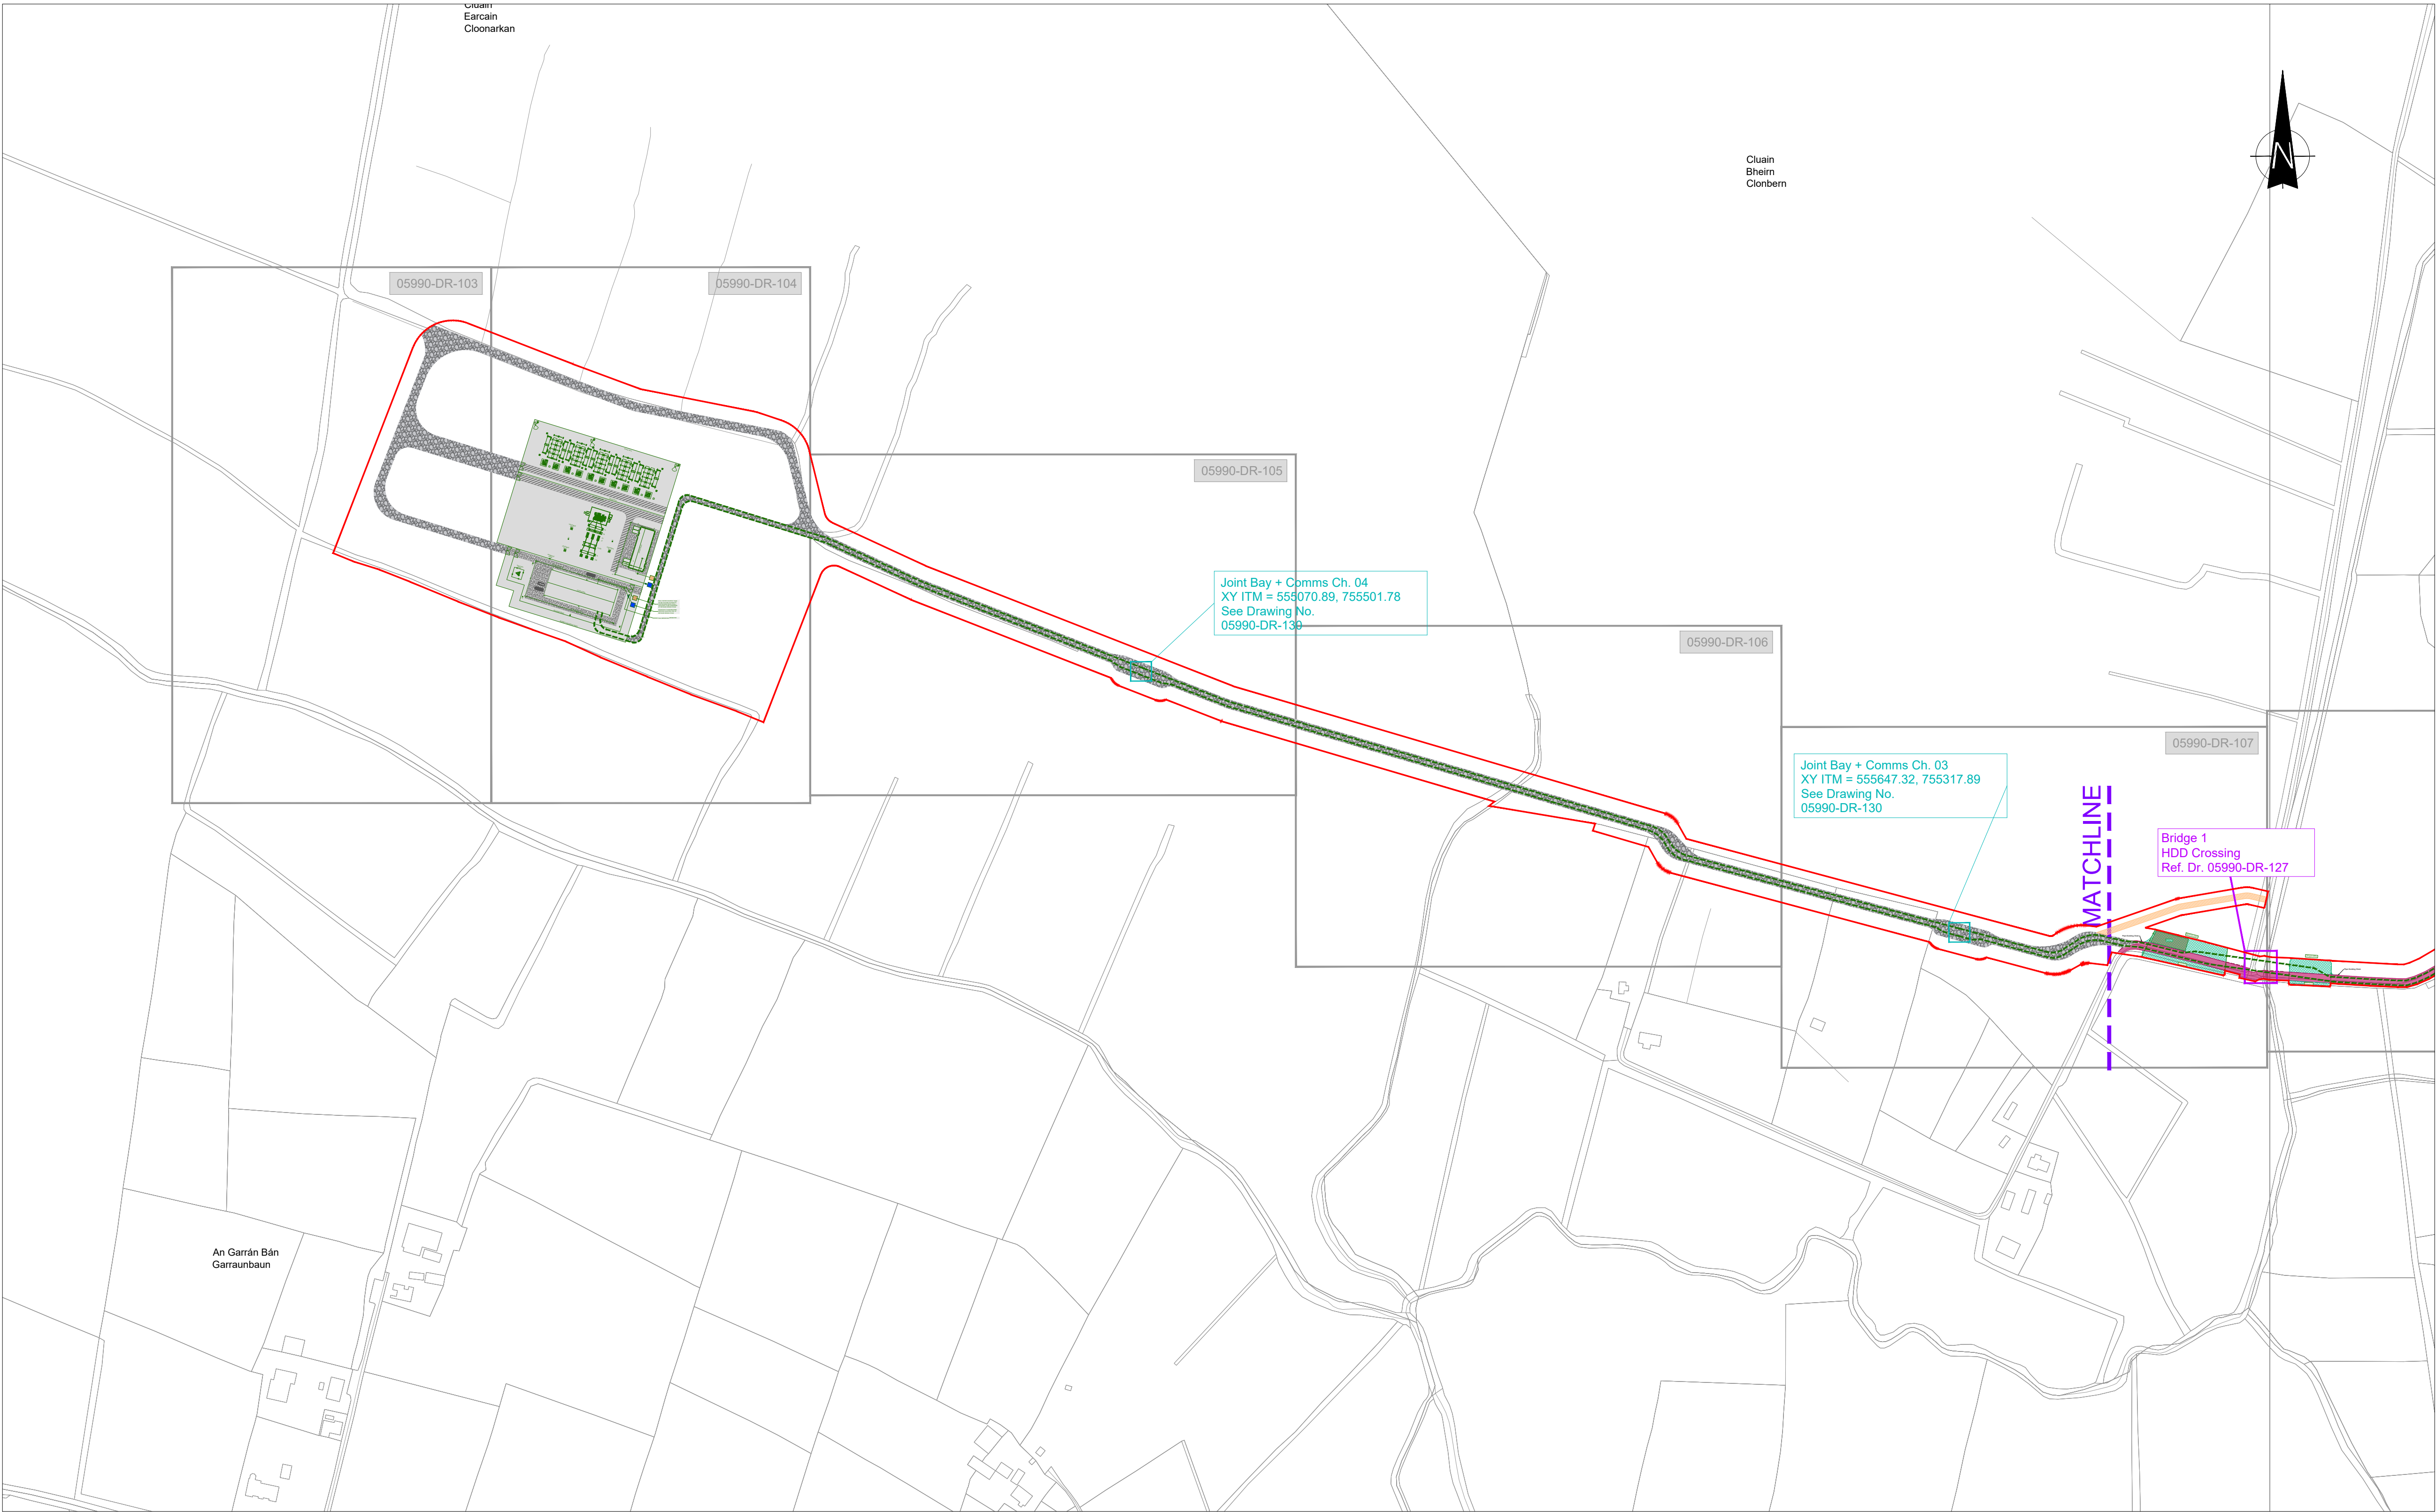

**Site Layout Key Plan**  
**Scale: 1:2500**

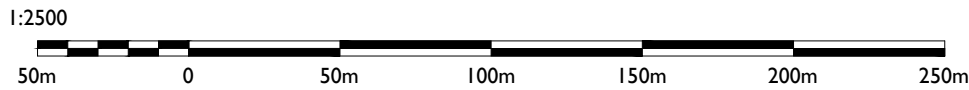

Map Series:  
Prime2 Vector Data - 1:2500  
- 1:5000

Reference No.'s:  
2679, 2748, 2749, 2680-C, 2748

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PROJECT

## Clonberne Wind Farm 220kV Grid Connection

CLIENT

Clonberne Windfarm Limited

CONSULTANTS



- NOTES: -
1. Path of cable route and location may vary depending on site conditions.
  2. Other services may be encountered along the route.
  3. Layout and Arrangements of Substation Building and Electrical Equipment is shown indicatively and for illustration purposes only.
  4. Dimensions shown are as per current Eirgrid Specifications at the time of submission. Dimensions may vary at time of construction to reflect any revisions to Eirgrid Specifications
  5. This drawing is to be used only for the purpose of the planning application and is subject to detailed design.

LEGEND: -

220kV Substation	
Cable Access Track	
Public Road Corridor	
Substation Asphalt Road	
Substation Concrete Road	
Operational Access	
Temporary Accommodation Area	
Underground Cable	
Planning Application Boundary	
Finished Compound Level	

ISSUE/REVISION

Issue/Revision	Date	Description
P1	04.06.24	Issued for Planning
I/R	DATE	DESCRIPTION

PROJECT NUMBER

05-990

SHEET TITLE

Site Layout Key Plan  
Sheet 1 of 2


SHEET NUMBER

05990-DR-101



ISO A1 594mm x 841mm

Project Management Initials: Designer: JF Checked: AC Approved: RG

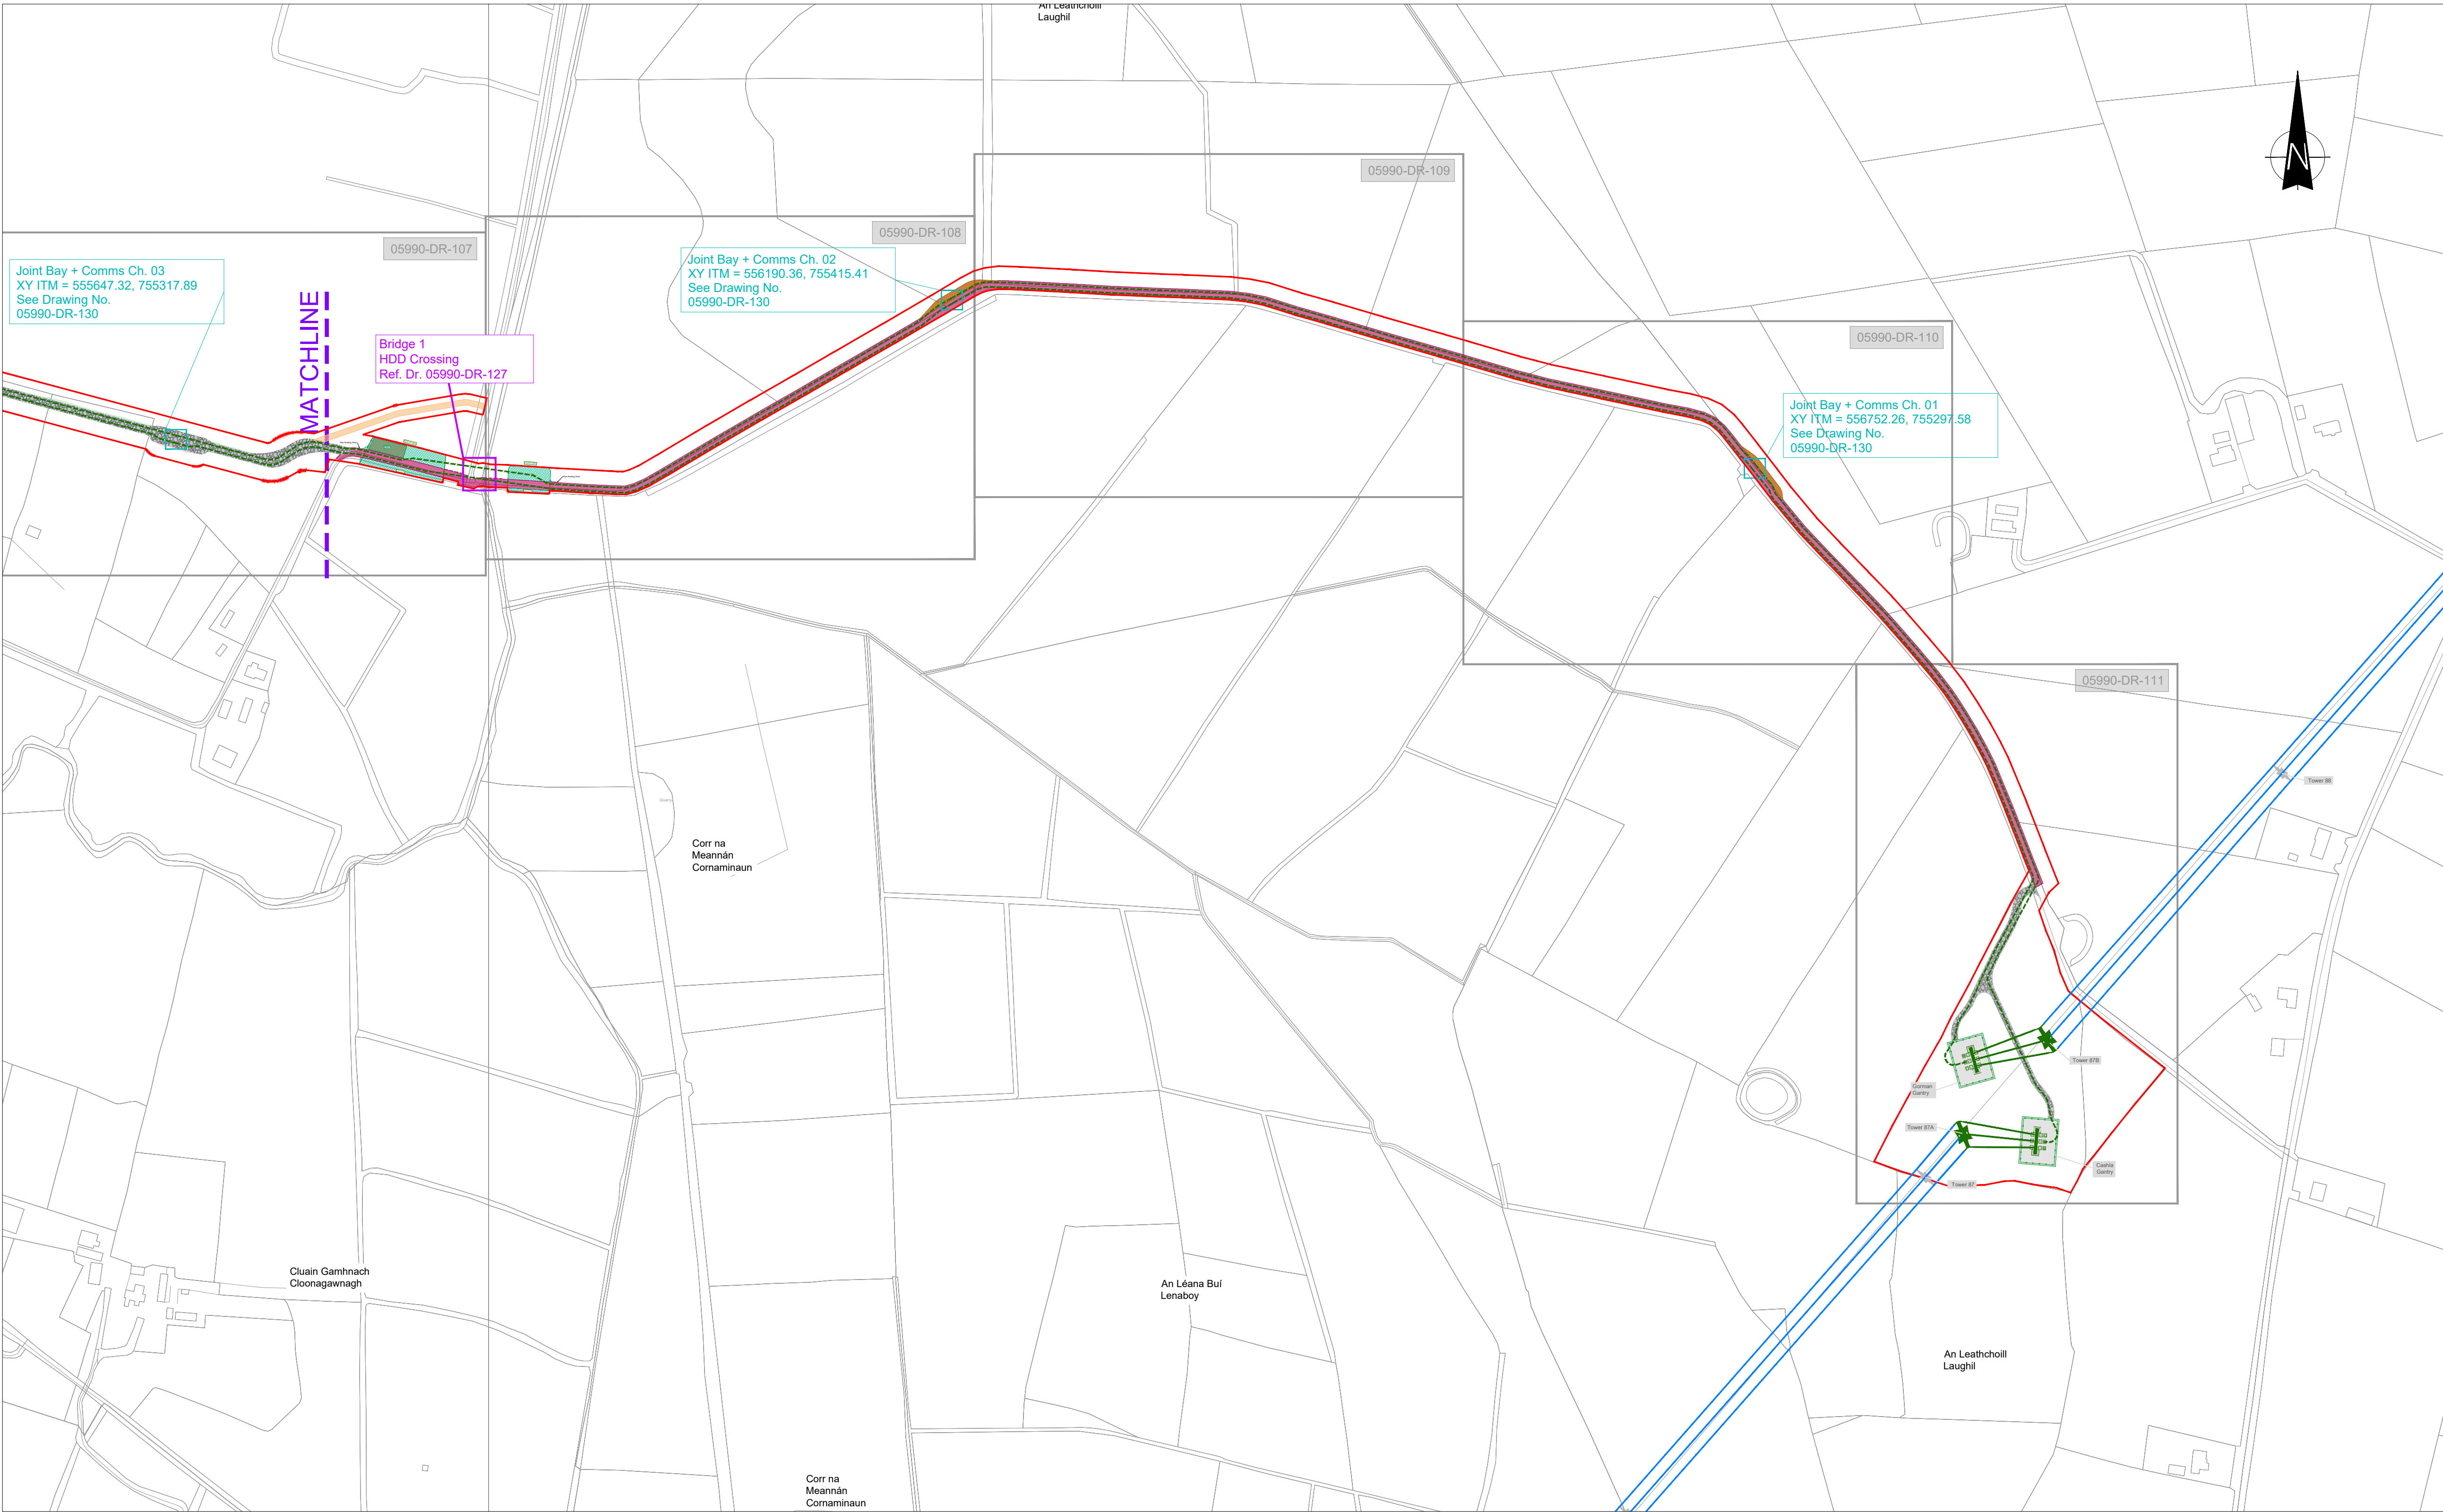

## Site Layout Key Plan

Scale: 1:2500



Map Series:  
Prime2 Vector Data - 1:2500  
- 1:5000

Reference No.'s:  
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## PROJECT

### Clonberne Wind Farm 220kV Grid Connection

CLIENT

Clonberne Windfarm Limited

## CONSULTANTS



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LEGEND: -

Cable Access Track	
Public Road Corridor	
Accommodation Area	
Temporary Accommodation Area	
Operational Access	
Underground Cable	
Existing 220kV Overhead Line	
Proposed Overhead Line	
Cable Compound	
Existing 220kV Tower	
Proposed Angle Mast	
Planning Application Boundary	
Finished Compound Level	

ISSUE/REVISION		
P1	04.06.24	Issued for Planning
I/R	DATE	DESCRIPTION

PROJECT NUMBER

05-990

SHEET TITLE

Site Layout Key Plan  
Sheet 2 of 2

SHEET NUMBER

05990-DR-102





LEGEND: -

220kV Substation	
Cable Access Track	
Substation Asphalt Road	
Substation Concrete Road	
Underground Cable	
Substation Internal Wind Farm Cables	
Existing Contours	
Proposed Levels	
Planning Application Boundary	
Finished Compound Level	
Excavation Required	
Fill Required	

NOTES: -

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PROJECT

## Clonberne Wind Farm 220kV Grid Connection

CLIENT

Clonberne Windfarm Limited

CONSULTANTS

Planning and  
Environmental  
Consultants

ISSUE/REVISION

P1	04.06.24	Issued for Planning
I/R	DATE	DESCRIPTION

PROJECT NUMBER

05-990

SHEET TITLE


Site Layout Plan  
Sheet 1 of 9

SHEET NUMBER

05990-DR-103

## Site Layout Plan

Scale: 1:500

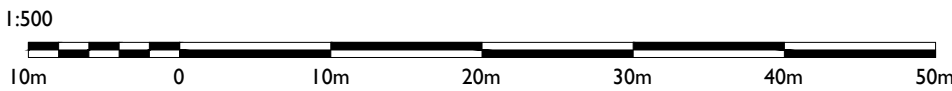

Map Series:  
Prime2 Vector Data - 1:2500  
- 1:5000

Reference No.'s:  
2679, 2748, 2749, 2680-C, 2748

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LEGEND: -

220kV Substation	
Cable Access Track	
Substation Asphalt Road	
Substation Concrete Road	
Underground Cable	
Substation Internal Wind Farm Cables	
Existing Contours	
Proposed Levels	
Planning Application Boundary	
Finished Compound Level	
Excavation Required	
Fill Required	

- NOTES: -
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**tli GROUP**

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PROJECT

## Clonberne Wind Farm 220kV Grid Connection

CLIENT

Clonberne Windfarm Limited

CONSULTANTS

**MKO** Planning and Environmental Consultants

ISSUE/REVISION

Issue/Revision	Date	Description
P1	04.06.24	Issued for Planning
I/R	DATE	DESCRIPTION

PROJECT NUMBER

05-990

SHEET TITLE


Site Layout Plan  
Sheet 2 of 9

SHEET NUMBER

05990-DR-104

## Site Layout Plan

Scale: 1:500

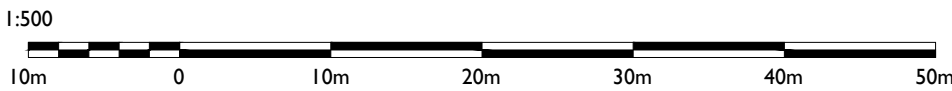

Map Series:  
Prime2 Vector Data - 1:2500  
- 1:5000

Reference No.'s:  
2679, 2748, 2749, 2680-C, 2748


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ISO A1 594mm x 841mm

Project Management Initials: Designer: JF Checked: AC Approved: RG



# Site Layout Plan

Scale: 1:500

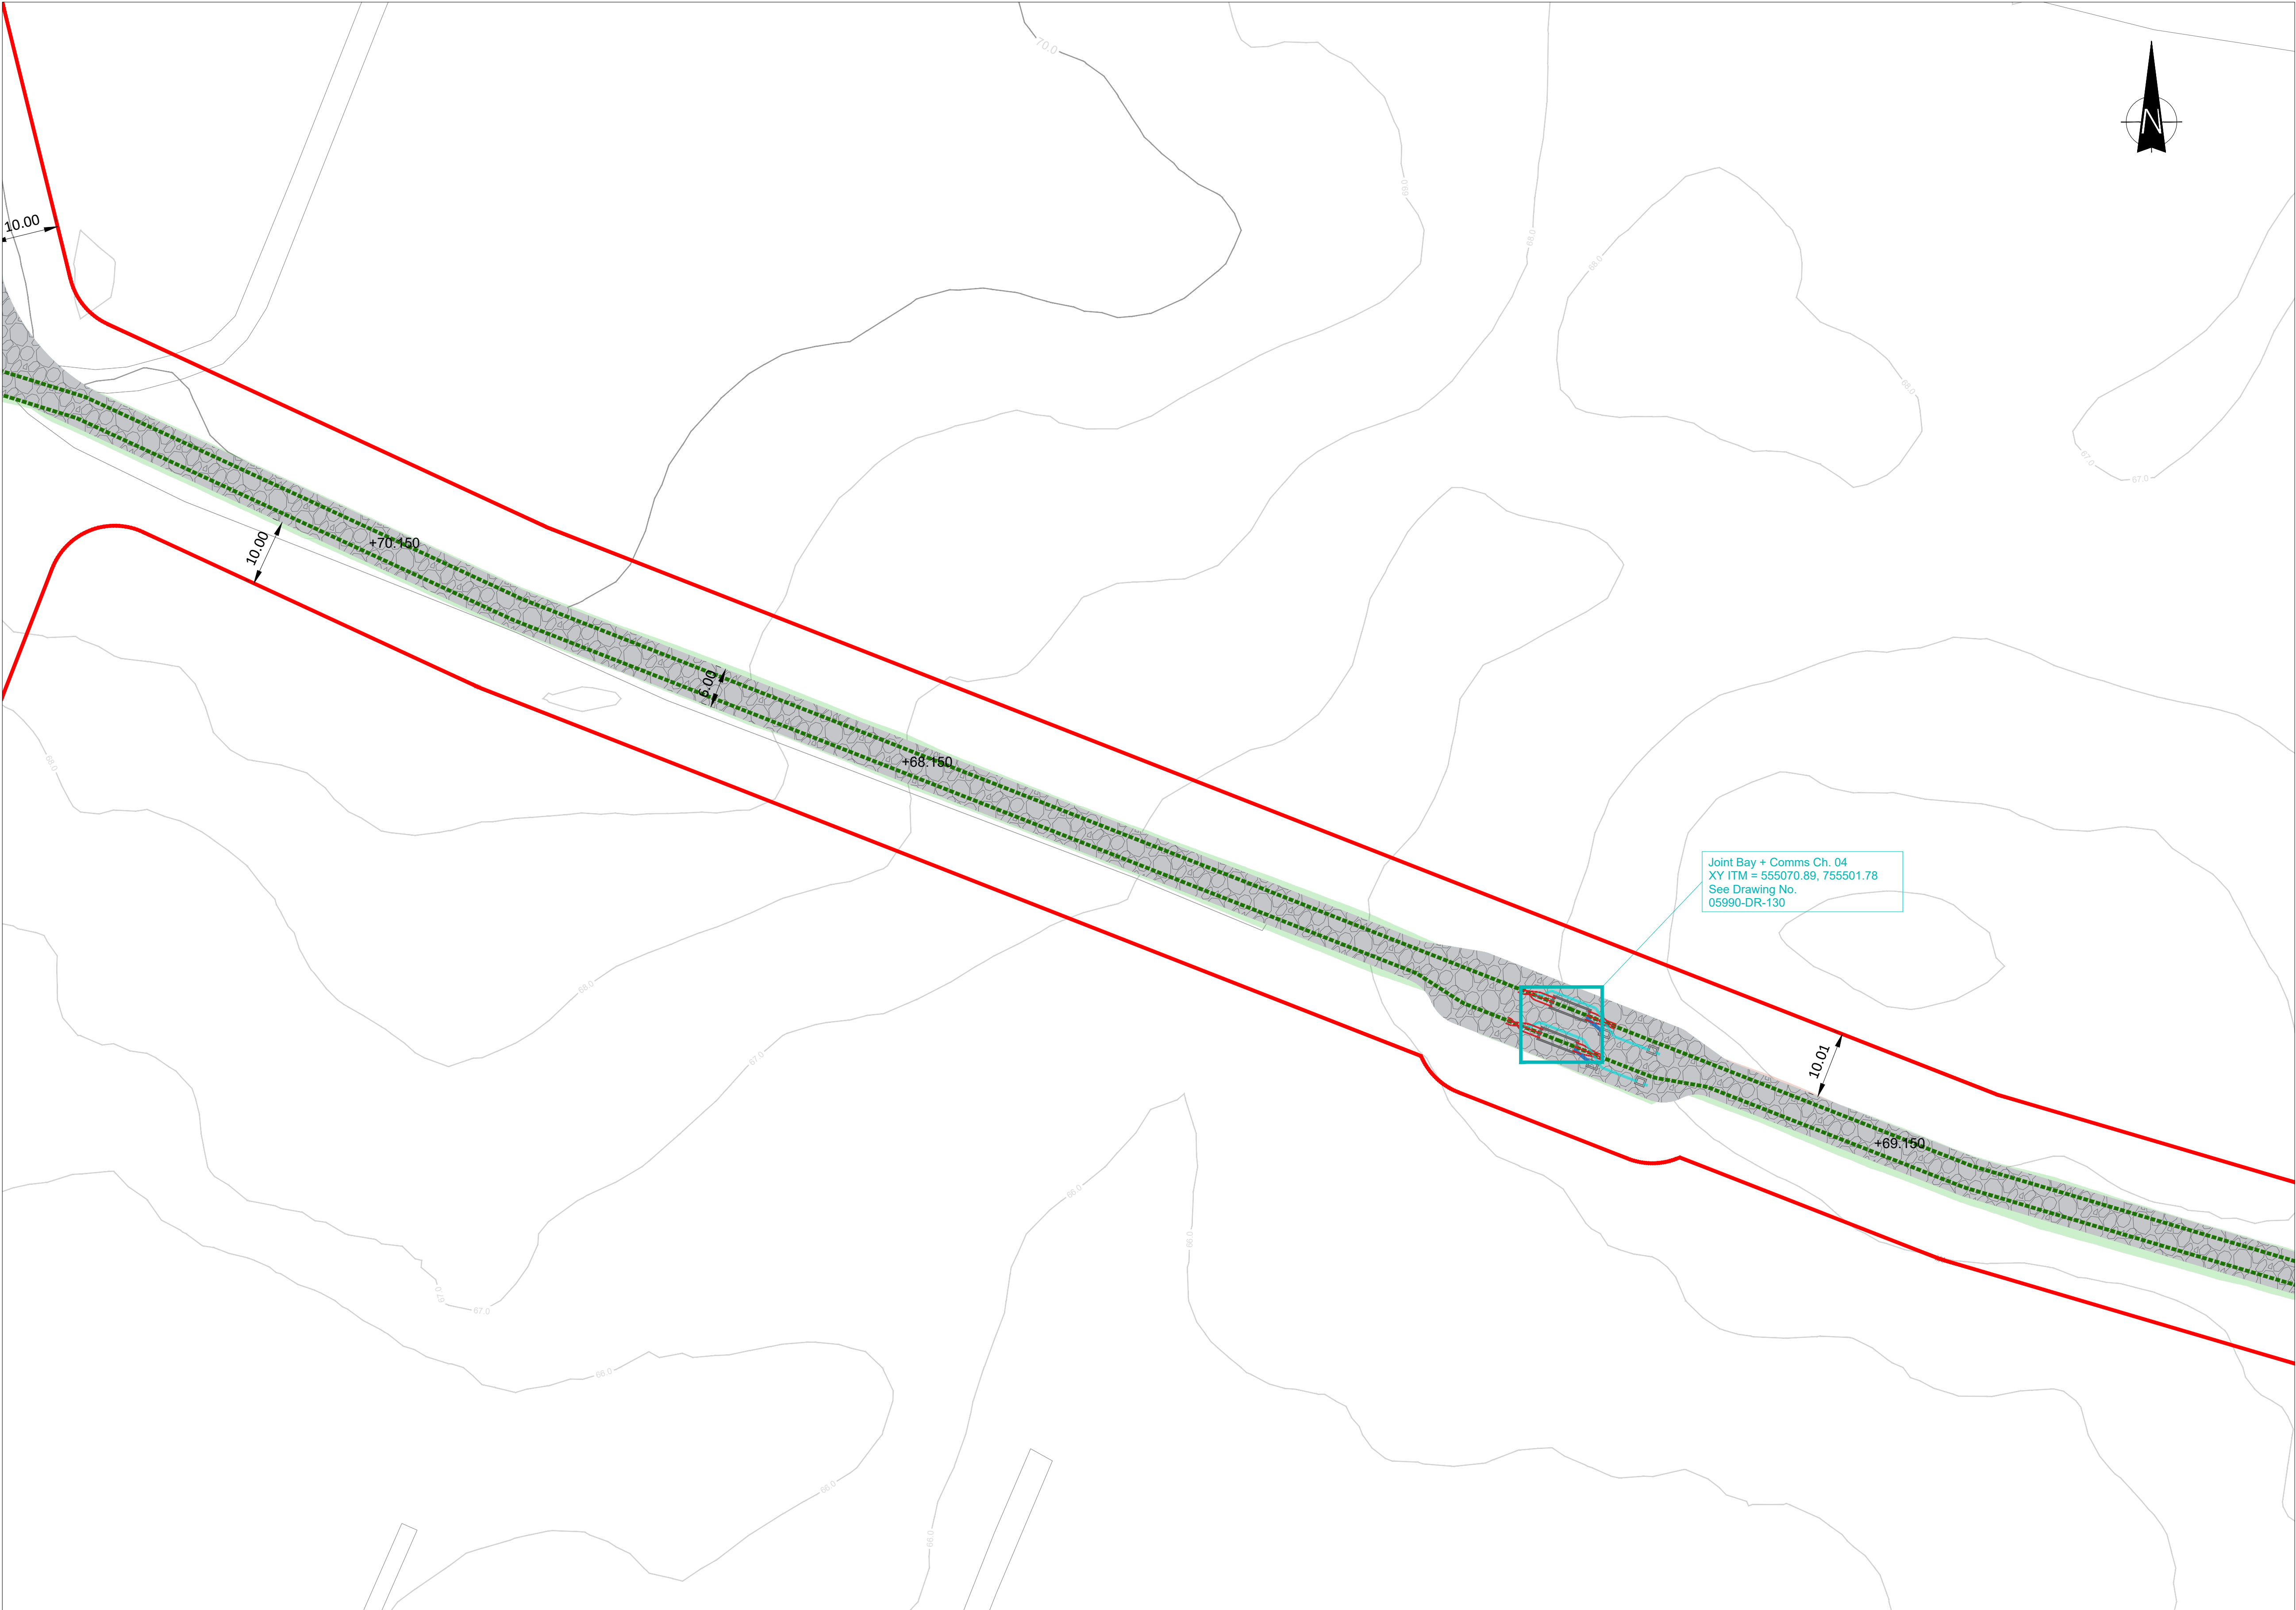Map Series:  
Prime2 Vector Data - 1:2500  
- 1:5000

Reference No.'s:  
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Tel: 00 44 1256406664

PROJECT

Clonberne Wind Farm  
220kV Grid Connection

CLIENT

Clonberne Windfarm Limited

CONSULTANTS

Planning and  
Environmental  
Consultants

NOTES: -

1. Path of cable route and location may vary depending on site conditions.
2. Other services may be encountered along the route.
3. Layout and Arrangements of Substation Building and Electrical Equipment is shown indicatively and for illustration purposes only.
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LEGEND: -

Cable Access Track	
Underground Cable	
220kV Joint Bay	
Existing Contours	
Proposed Levels	
Planning Application Boundary	
Excavation Required	
Fill Required	

ISSUE/REVISION		
P1	04.06.24	Issued for Planning
I/R	DATE	DESCRIPTION

PROJECT NUMBER

05-990

SHEET TITLE

Site Layout Plan  
Sheet 3 of 9


SHEET NUMBER

05990-DR-105



ISO A1 594mm x 841mm

Project Management Initials: Designer: JF Checked: AC Approved: RG

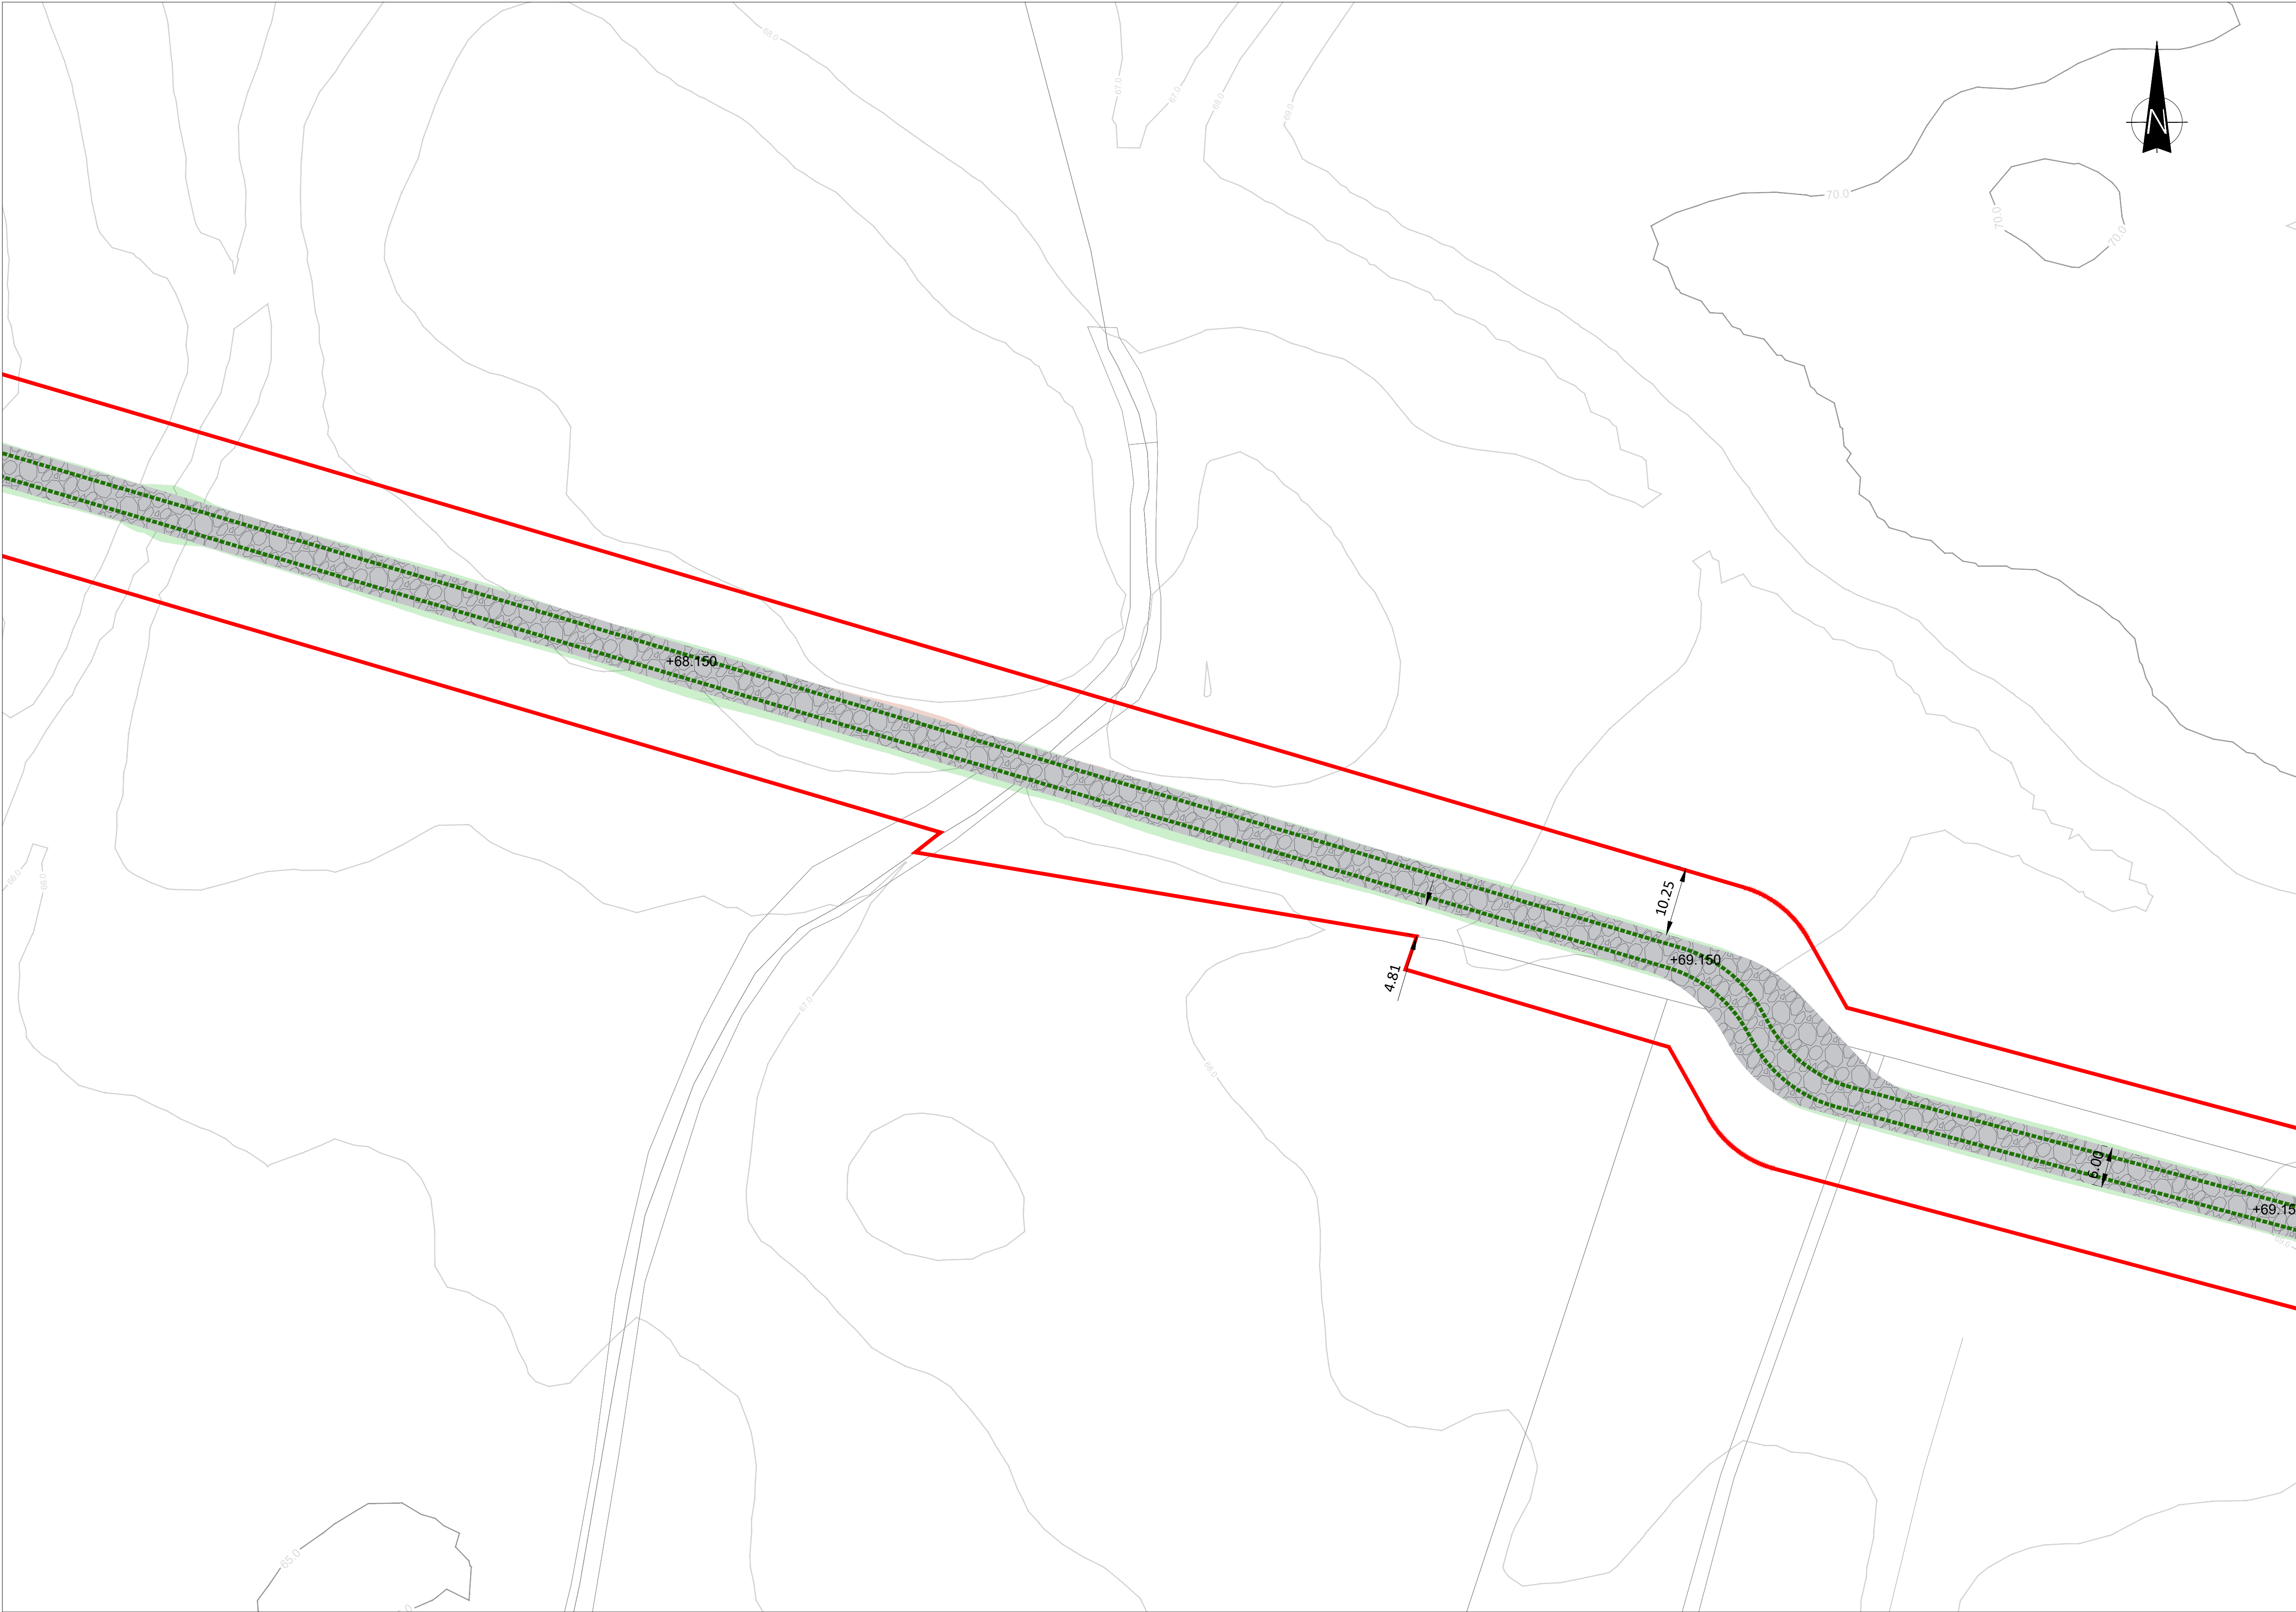

# Site Layout Plan

Scale: 1:500



Map Series:  
Prime2 Vector Data - 1:2500  
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Reference No.'s:  
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## PROJECT

Clonberne Wind Farm  
220kV Grid Connection

## CLIENT

Clonberne Windfarm Limited

## CONSULTANTS



## NOTES: -

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2. Other services may be encountered along the route.
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## LEGEND: -

Cable Access Track	
Underground Cable	
220kV Joint Bay	
Existing Contours	
Proposed Levels	
Planning Application Boundary	
Excavation Required	
Fill Required	

## ISSUE/REVISION

P1	04.06.24	Issued for Planning
I/R	DATE	DESCRIPTION

## PROJECT NUMBER

05-990

## SHEET TITLE

Site Layout Plan  
Sheet 4 of 9


## SHEET NUMBER

05990-DR-106



ISO A1 594mm x 841mm

Project Management Initials: Designer: JF Checked: AC Approved: RG

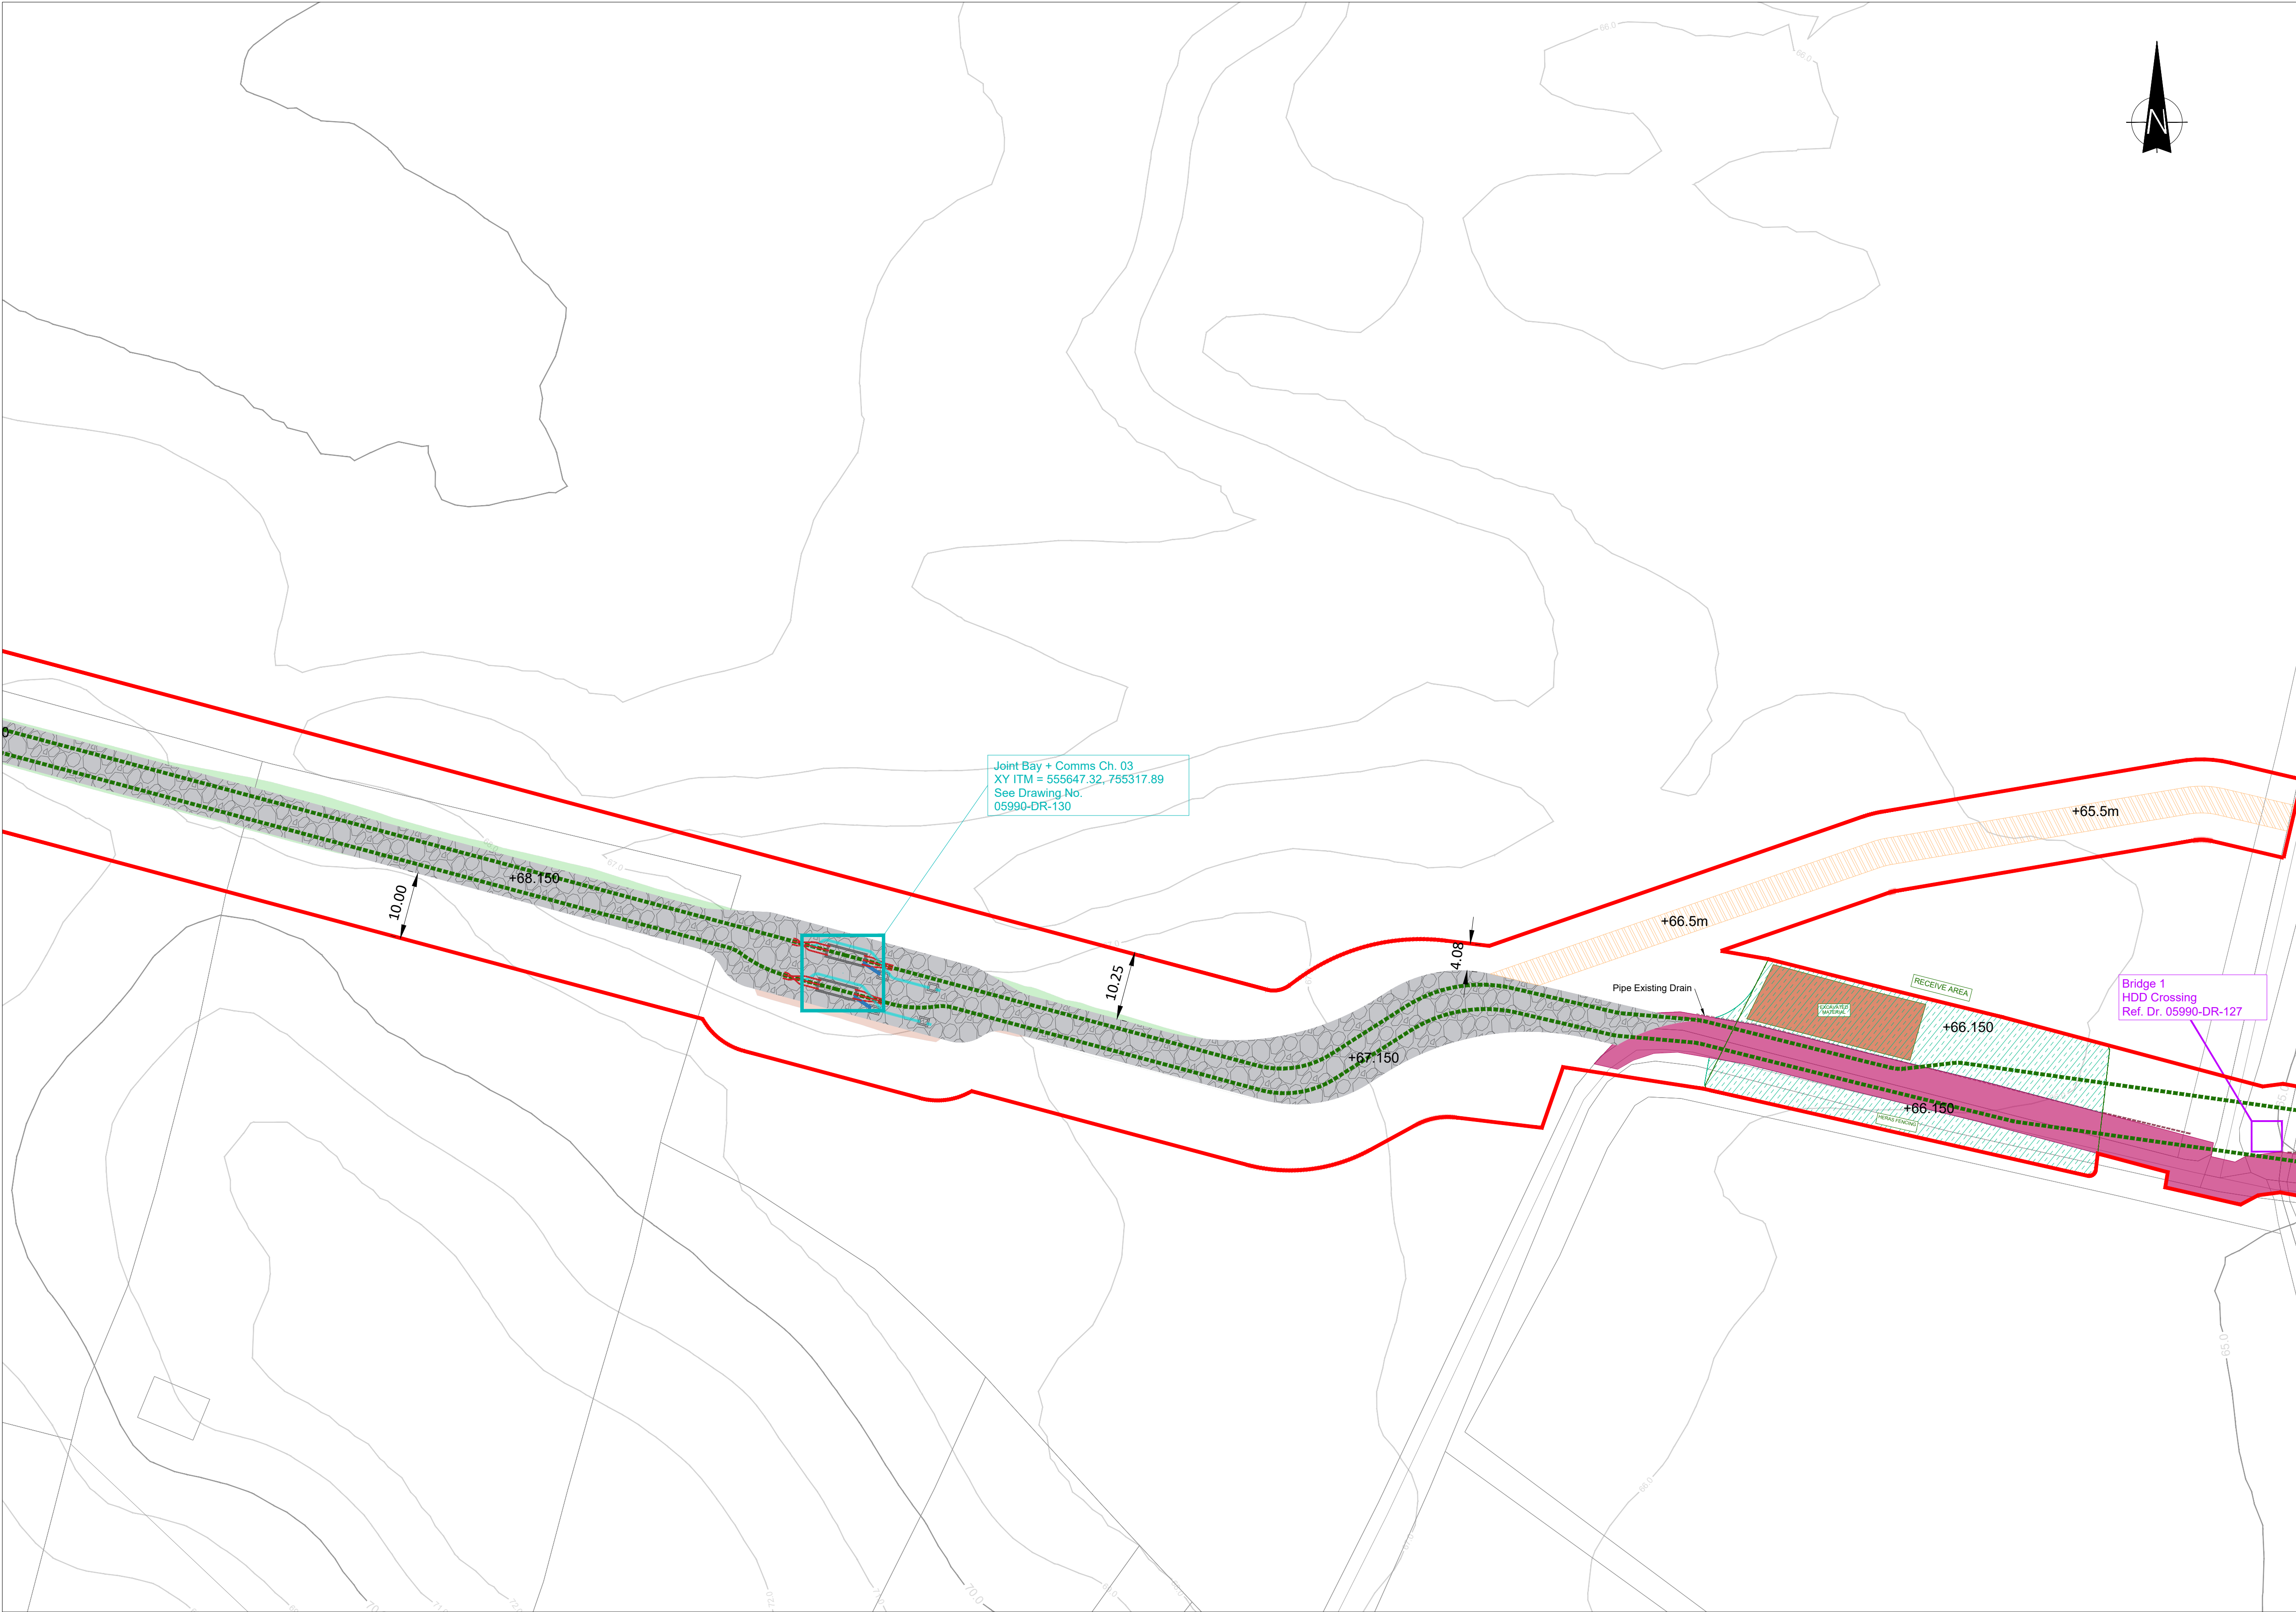

# Site Layout Plan

Scale: 1:500



Map Series:  
Prime2 Vector Data - 1:2500  
- 1:5000

Reference No.'s:  
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Tel: 00 44 1256406664

## PROJECT

### Clonberne Wind Farm 220kV Grid Connection

CLIENT

Clonberne Windfarm Limited

CONSULTANTS

MKO Planning and Environmental Consultants

- NOTES: -
1. Path of cable route and location may vary depending on site conditions.
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LEGEND: -

Cable Access Track	
Public Road Corridor	
Operational Access	
Temporary Accommodation Area	
Underground Cable	
220kV Joint Bay	
Piped Drain	
HDD Launch / Receive Area	
Existing Contours	
Proposed Levels	
Planning Application Boundary	
Excavation Required	
Fill Required	

ISSUE/REVISION

P1	04.06.24	Issued for Information
I/R	DATE	DESCRIPTION

PROJECT NUMBER

05-990

SHEET TITLE

Site Layout Plan  
Sheet 5 of 9

SHEET NUMBER

05990-DR-107



ISO A1 594mm x 841mm

Project Management Initials: Designer: JF Checked: AC Approved: RG



# Site Layout Plan

Scale: 1:500

Map Series:  
Prime2 Vector Data - 1:2500  
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## PROJECT

### Clonberne Wind Farm 220kV Grid Connection

CLIENT

Clonberne Windfarm Limited

CONSULTANTS

Planning and Environmental Consultants

- NOTES: -
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  5. This drawing is to be used only for the purpose of the planning application and is subject to detailed design.
- LEGEND: -
- |                               |  |
|-------------------------------|--|
| Public Road Corridor          |  |
| Accommodation Area            |  |
| Temporary Accommodation Area  |  |
| Underground Cable             |  |
| 220kV Joint Bay               |  |
| Piped Drain                   |  |
| HDD Launch / Receive Area     |  |
| Existing Contours             |  |
| Proposed Levels               |  |
| Planning Application Boundary |  |

ISSUE/REVISION		
P1	04.06.24	Issued for Planning
I/R	DATE	DESCRIPTION

PROJECT NUMBER

05-990

SHEET TITLE

Site Layout Plan  
Sheet 6 of 9

SHEET NUMBER

05990-DR-108

ISO A1 594mm x 841mm  
Project Management Initials: Designer: JF  
Checked: AC  
Approved: RG



# Site Layout Plan

Scale: 1:500

Map Series:  
Prime2 Vector Data - 1:2500  
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## PROJECT

### Clonberne Wind Farm 220kV Grid Connection

CLIENT

Clonberne Windfarm Limited



- NOTES: -
- 1. Path of cable route and location may vary depending on site conditions.
  - 2. Other services may be encountered along the route.
  - 3. Layout and Arrangements of Substation Building and Electrical Equipment is shown indicatively and for illustration purposes only.
  - 4. Dimensions shown are as per current Eirgrid Specifications at the time of submission. Dimensions may vary at time of construction to reflect any revisions to Eirgrid Specifications
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- LEGEND: -
- Public Road Corridor
  - Accommodation Area
  - Underground Cable
  - 220kV Joint Bay
  - Existing Contours
  - Proposed Levels
  - Planning Application Boundary

ISSUE/REVISION		
P1	04.06.24	Issued for Planning
I/R	DATE	DESCRIPTION

PROJECT NUMBER

05-990

SHEET TITLE


Site Layout Plan  
Sheet 7 of 9

SHEET NUMBER

05990-DR-109



ISO A1 594mm x 841mm  
Project Management Initials: Designer: JF  
Checked: AC  
Approved: RG

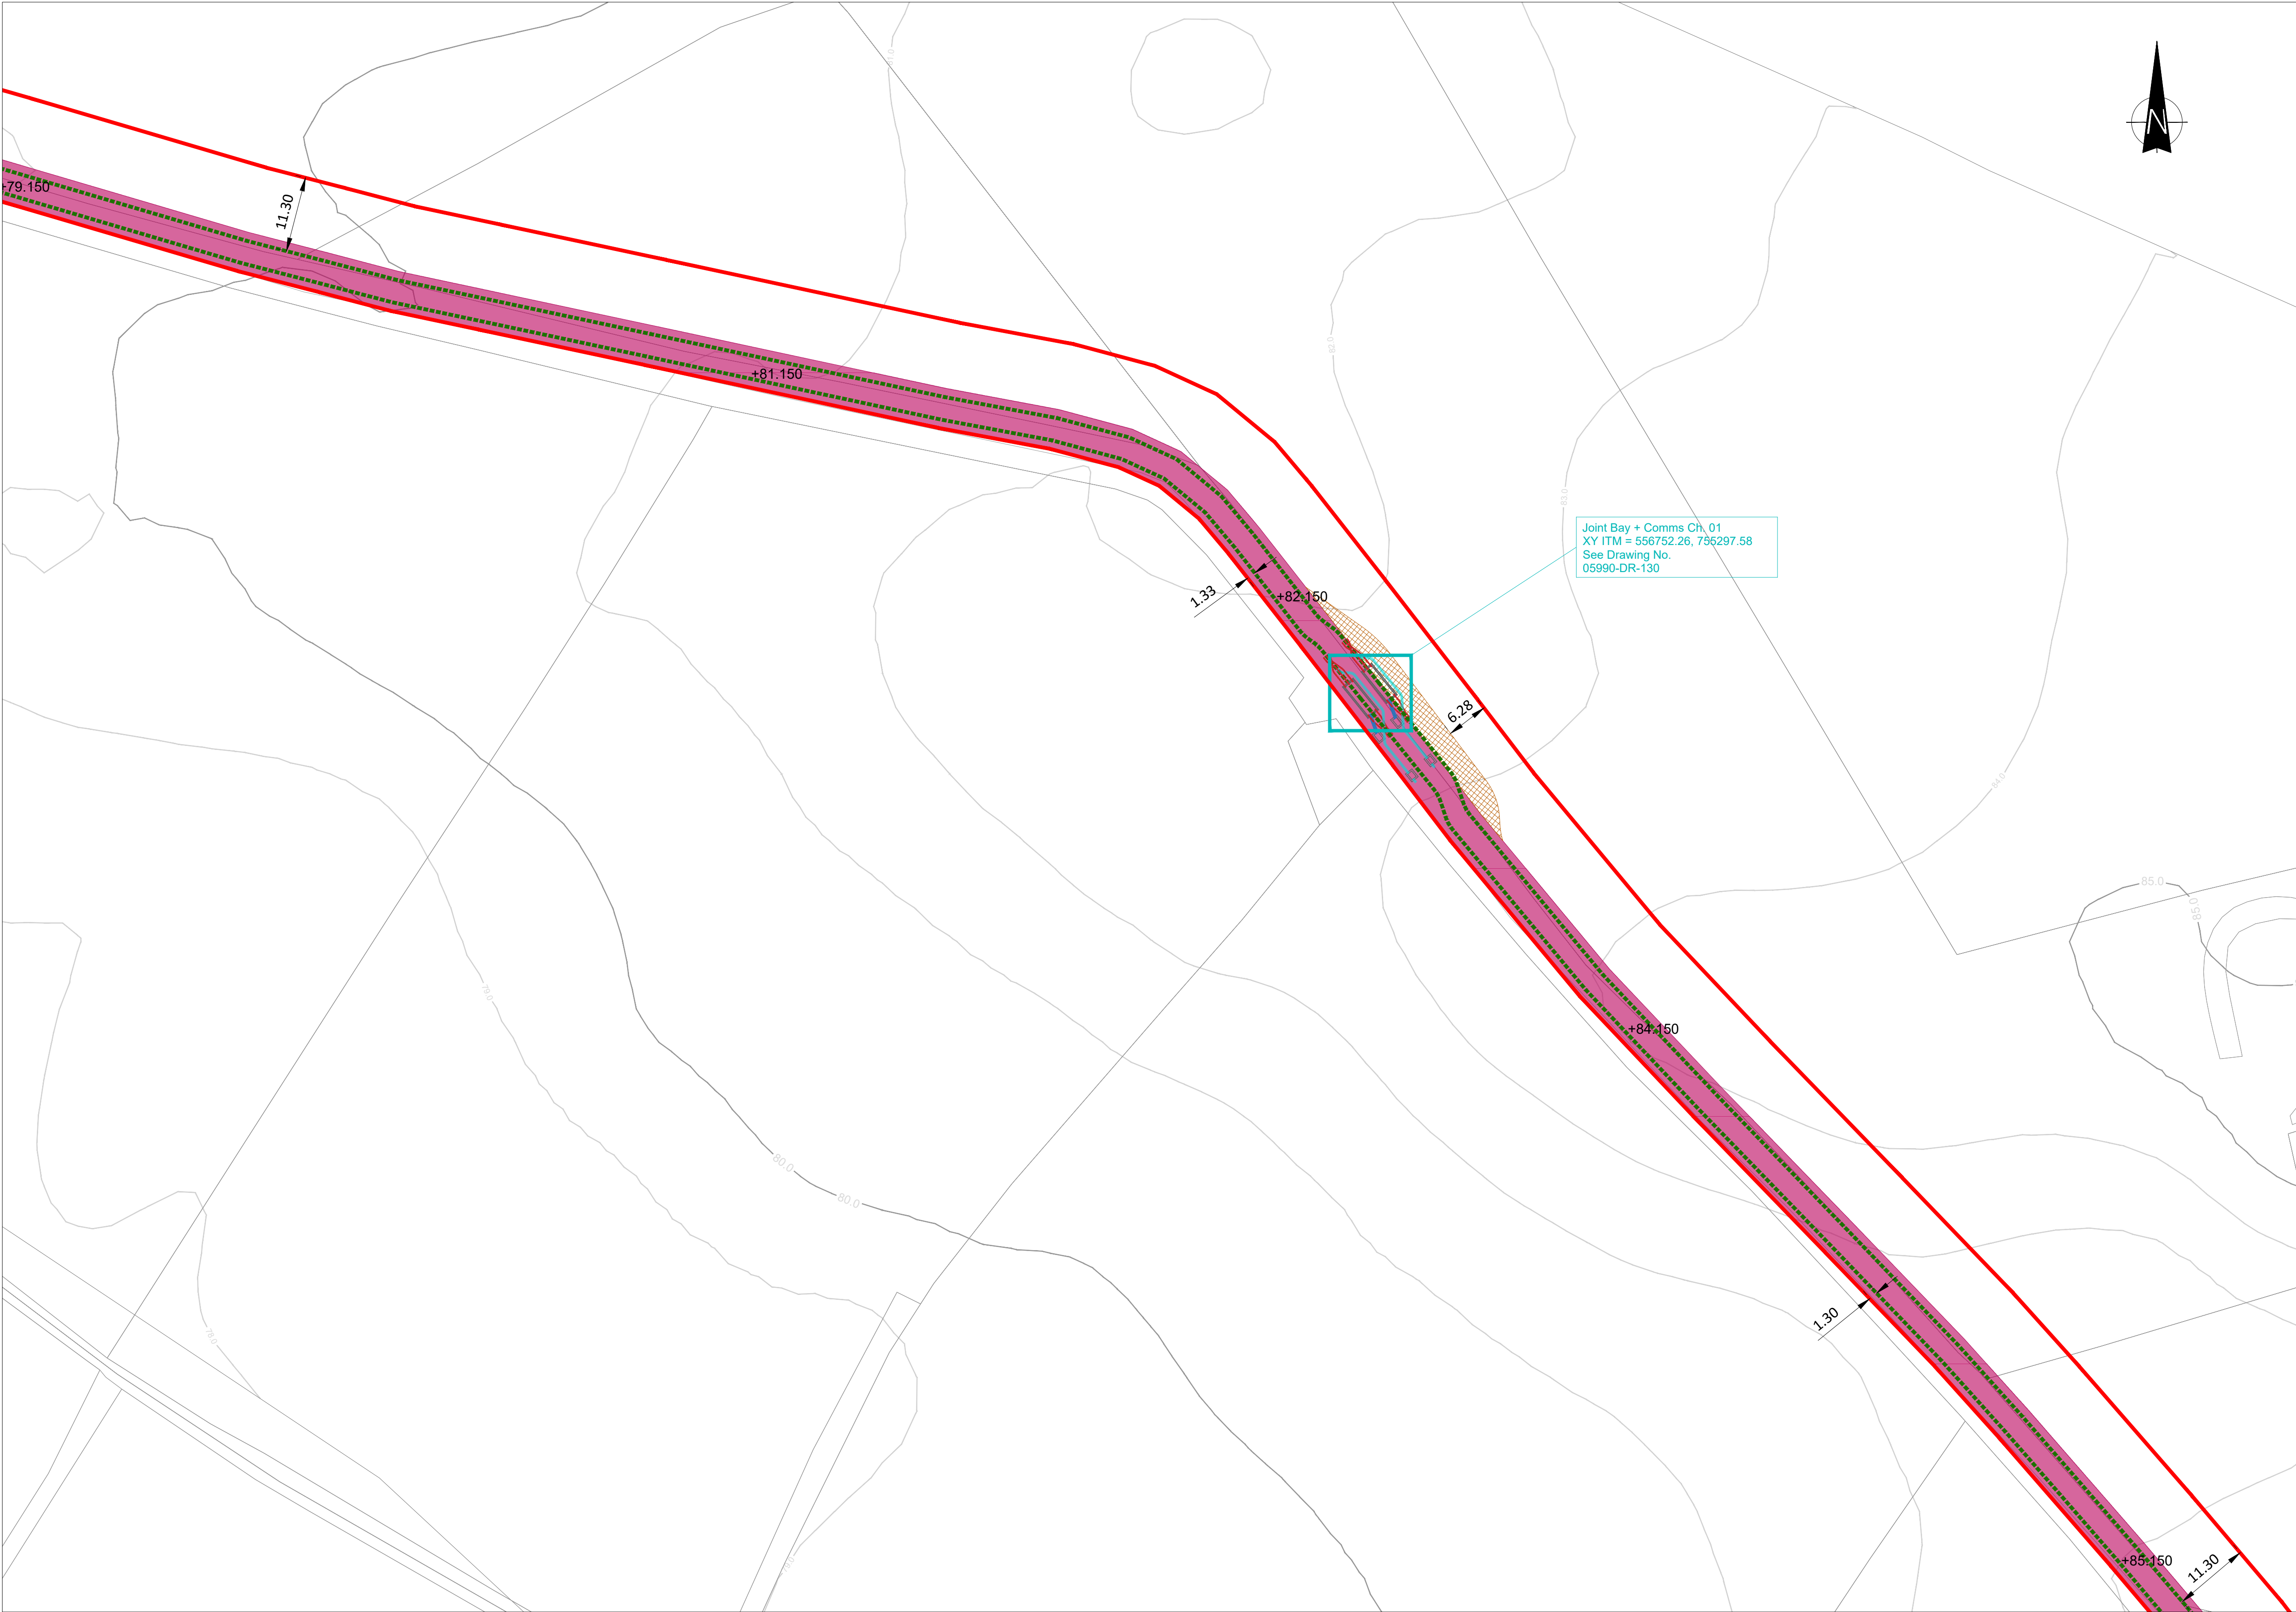

# Site Layout Plan

Scale: 1:500



Map Series:  
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## PROJECT

## Clonberne Wind Farm 220kV Grid Connection

## CLIENT

Clonberne Windfarm Limited

## CONSULTANTS



## NOTES: -

1. Path of cable route and location may vary depending on site conditions.
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## LEGEND: -

Public Road Corridor	
Accommodation Area	
Underground Cable	
220kV Joint Bay	
Existing Contours	
Proposed Levels	
Planning Application Boundary	

## ISSUE/REVISION

P1	04.06.24	Issued for Planning
I/R	DATE	DESCRIPTION

## PROJECT NUMBER

05-990


## SHEET TITLE

Site Layout Plan  
Sheet 8 of 9

## SHEET NUMBER

05990-DR-110



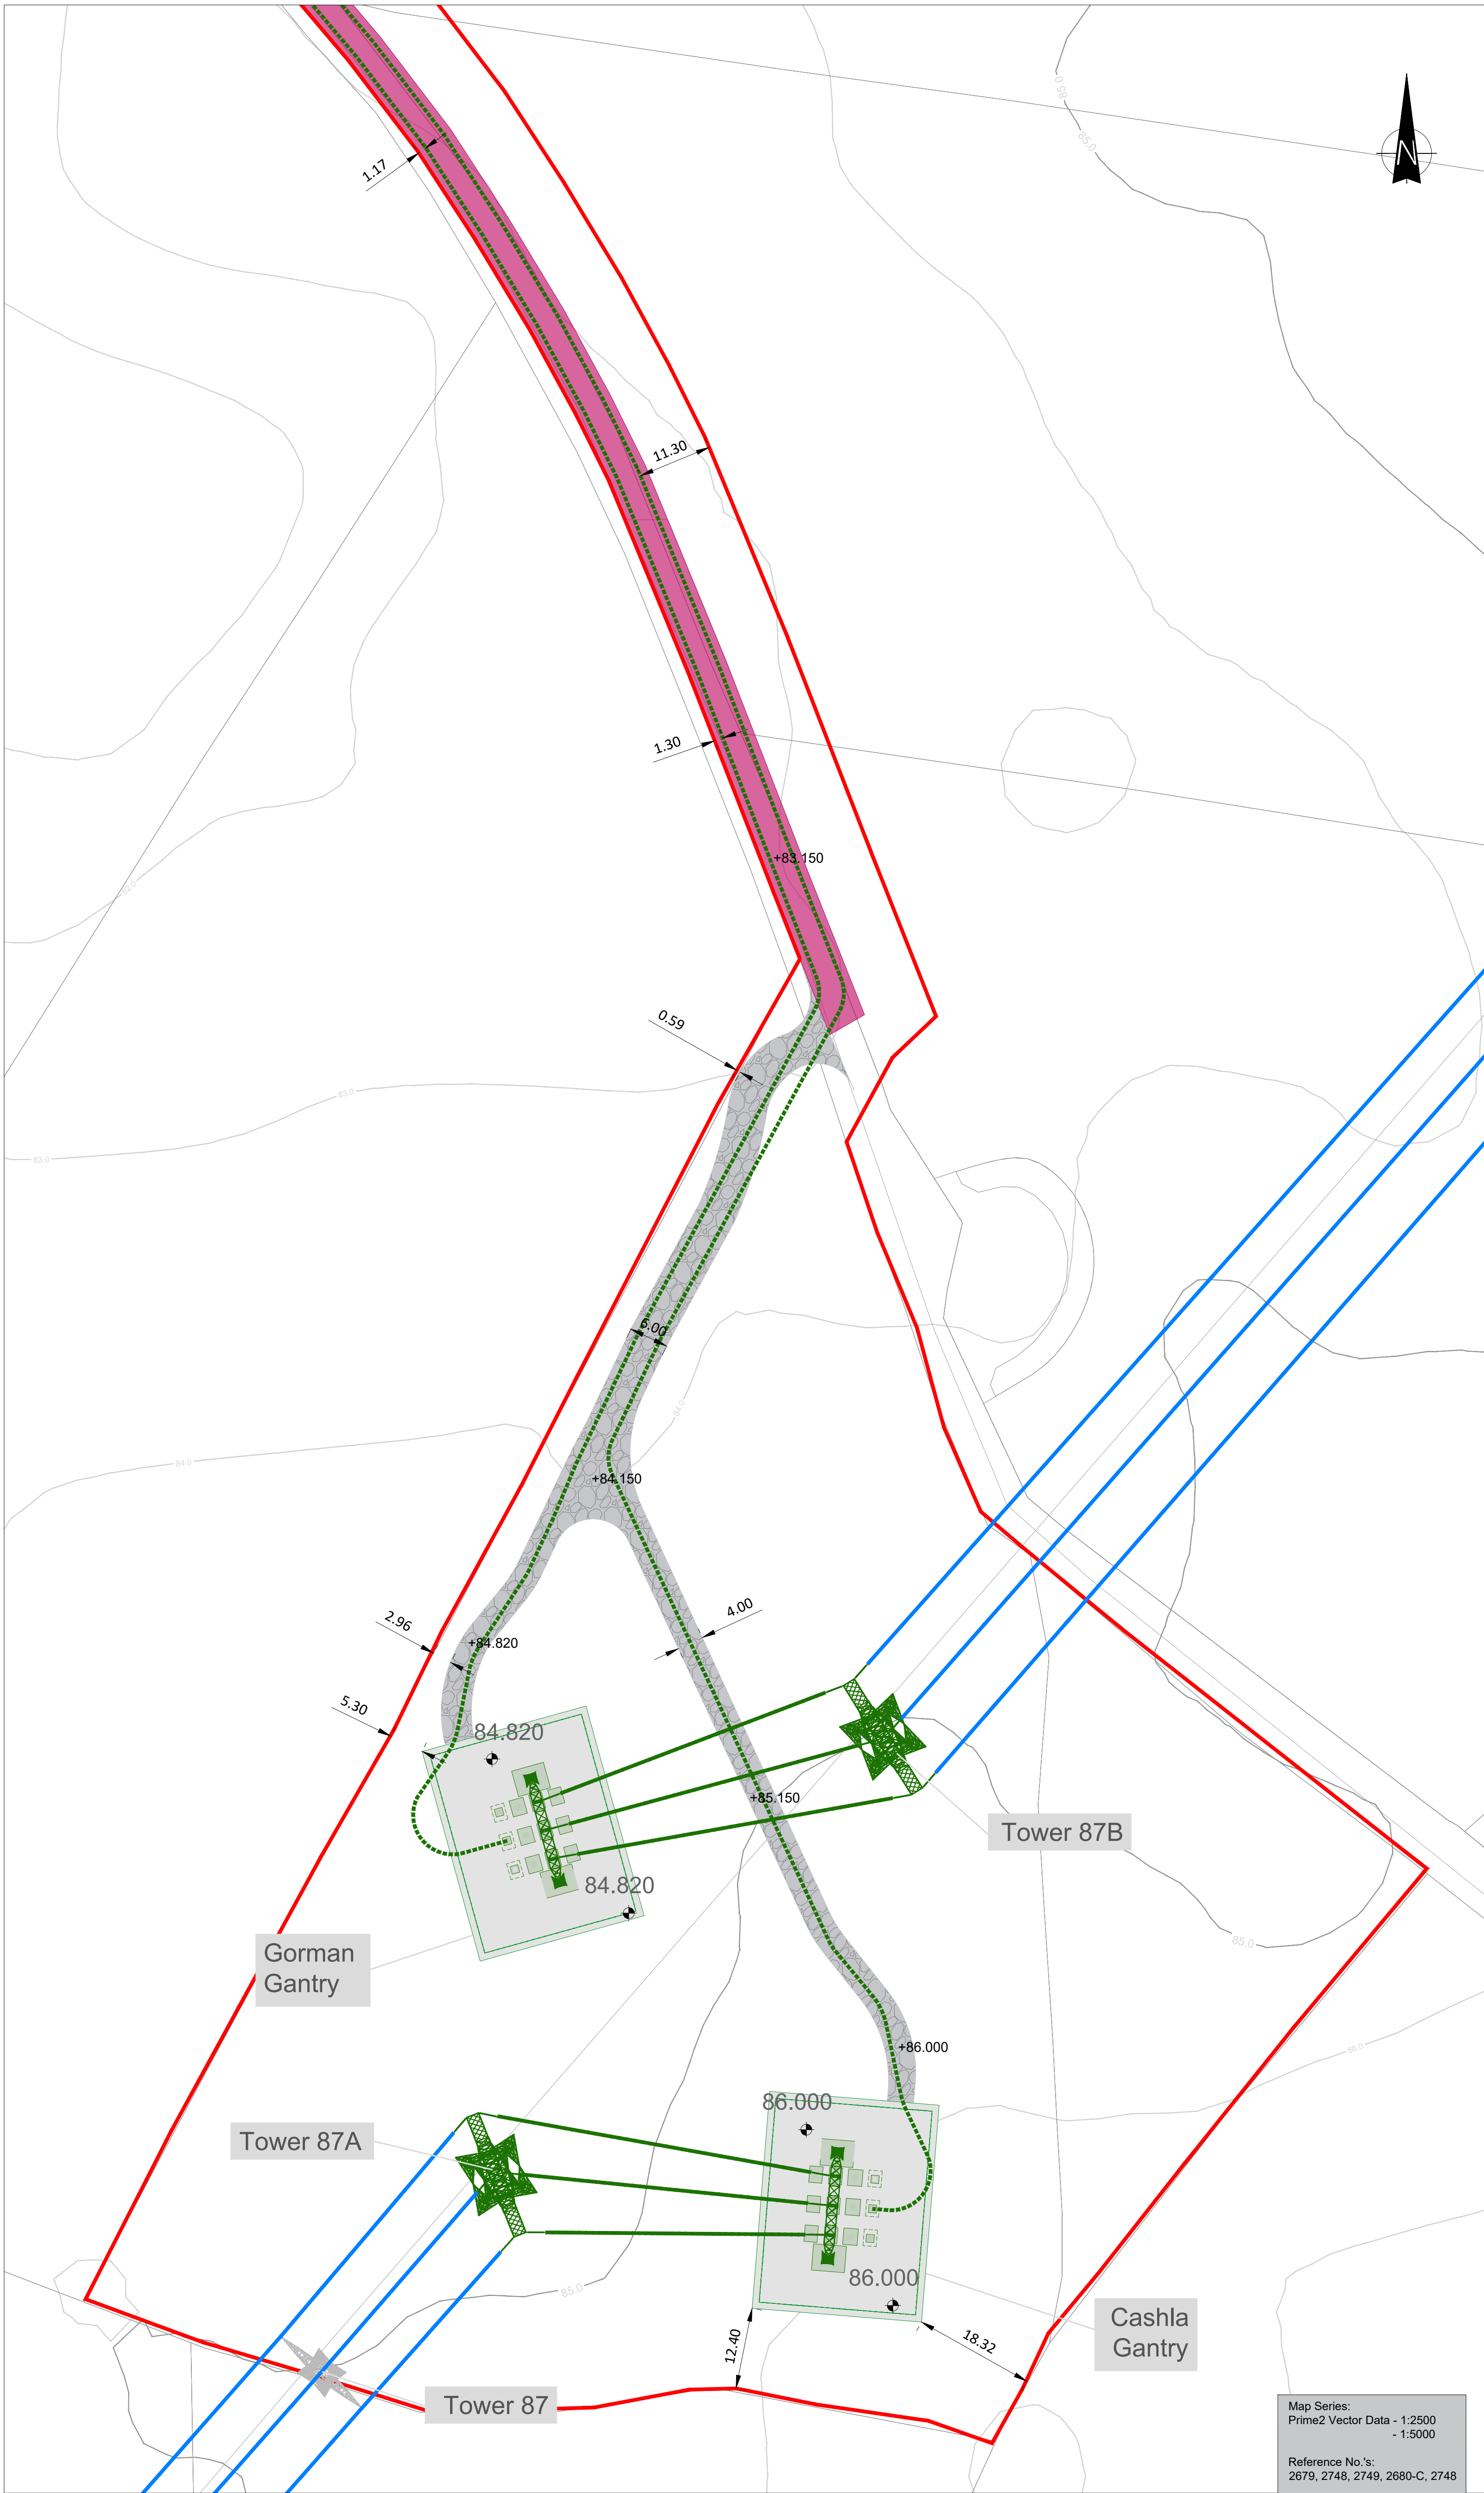

LEGEND: -

Cable Access Track	
Public Road Corridor	
Underground Cable	
Existing 220kV Overhead Line	
Proposed Overhead Line	
Cable Compound	
Existing 220kV Tower	
Proposed Angle Mast	
Finished Compound Level	
Existing Contours	
Proposed Levels	
Planning Application Boundary	

NOTES: -

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PROJECT

## Clonberne Wind Farm 220kV Grid Connection

CLIENT

Clonberne Windfarm Limited

CONSULTANTS

**MKO** Planning and Environmental Consultants

ISSUE/REVISION

Issue/Revision	Date	Description
P1	04.06.24	Issued for Planning
I/R	DATE	DESCRIPTION

PROJECT NUMBER

05-990

SHEET TITLE

Site Layout Plan  
Sheet 9 of 9

SHEET NUMBER

05990-DR-111

Site Layout Plan  
Scale: 1:500




Map Series:  
Prime2 Vector Data - 1:2500  
- 1:5000

Reference No.'s:  
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# PROJECT

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## Clonbern Wind Farm 220kV Grid Connection

CLIENT

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Clonberne Windfarm Limited

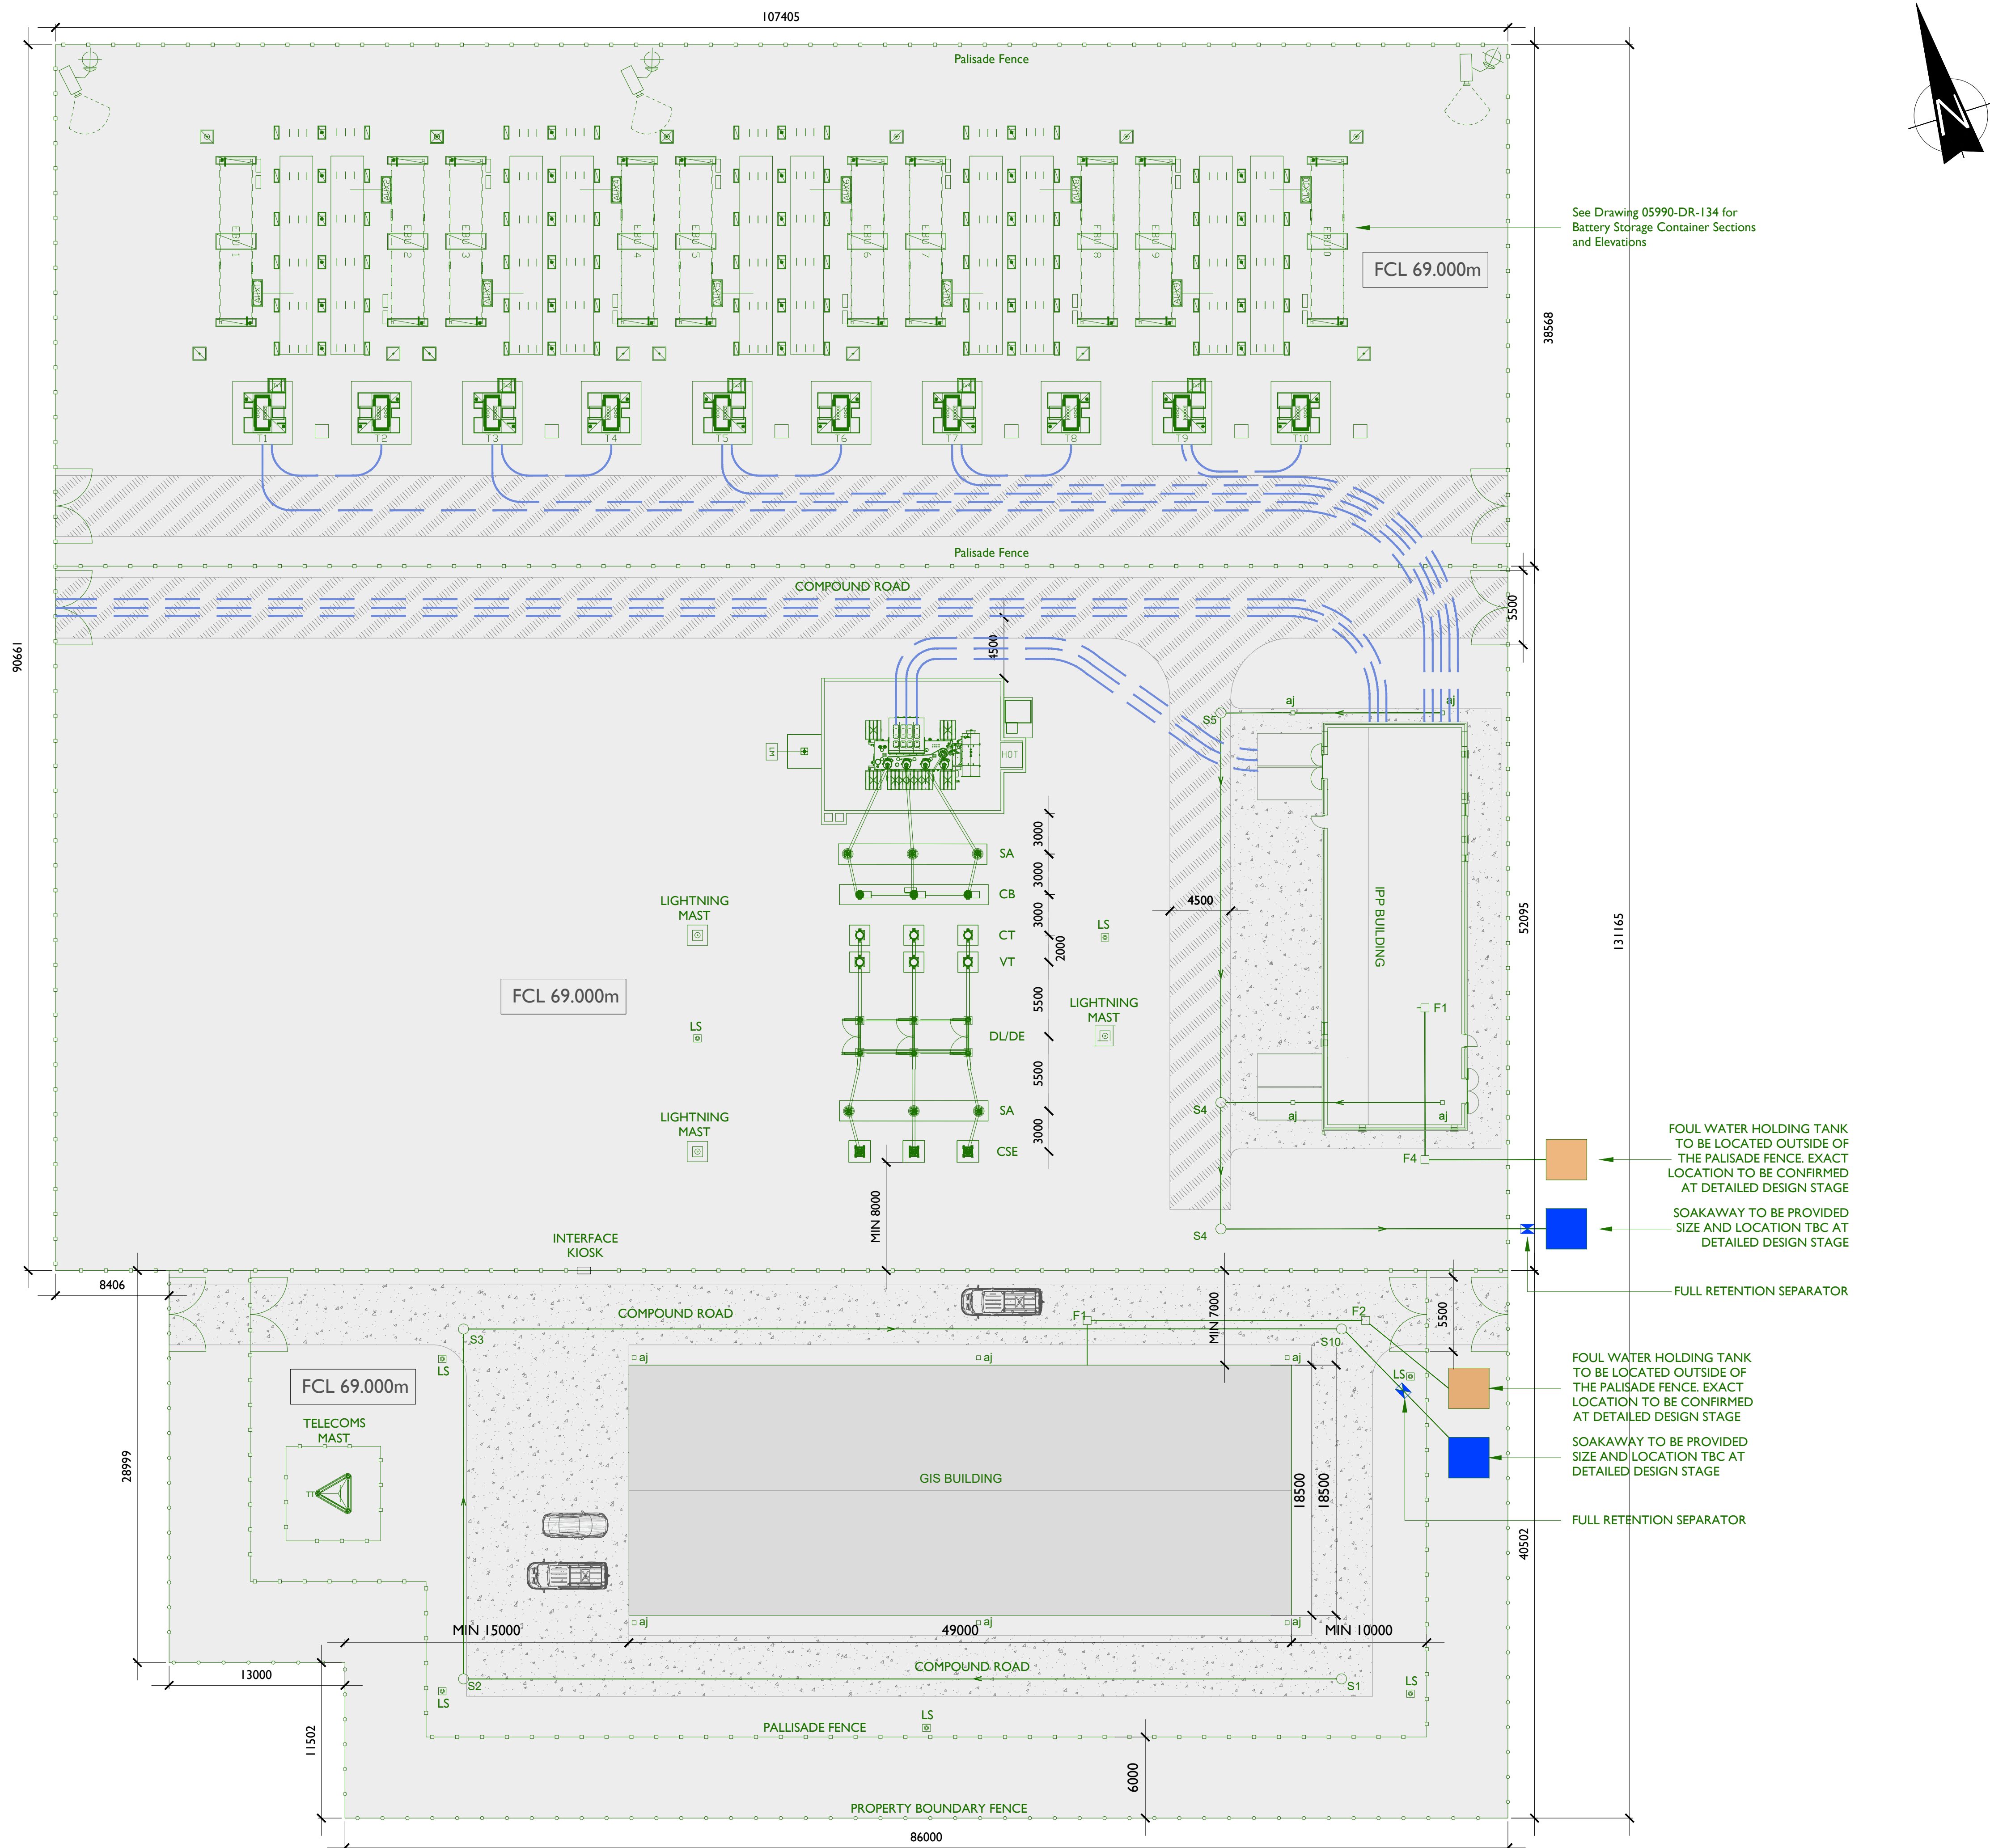




## CONSULTANTS

## NOTES: -

---

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3. Final Specifications of Buildings and Electrical Equipment is to be as per Eirgrid and ESB Specifications
4. The Elevation of the Compound will be depicted by localized Topography such that Cu/IV Earthworks associated with the construction of the Compound are banned.

LEGEND: -

- |                                      |   |
|--------------------------------------|---|
| Substation Internal Wind Farm Cables |  |
| Substation Asphalt Road              |  |
| Substation Concrete Road             |  |
| Auxiliary Transformer                |  |
| Transformer                          |  |

## ISSUE/REVISION

P1	04.06.24	Issued for Planning
I/R	DATE	DESCRIPTION

## PROJECT NUMBER

05-990


## SHEET TITLE

220kV GIS Substation Plan


## SHEET NUMBER

05990-DR-112




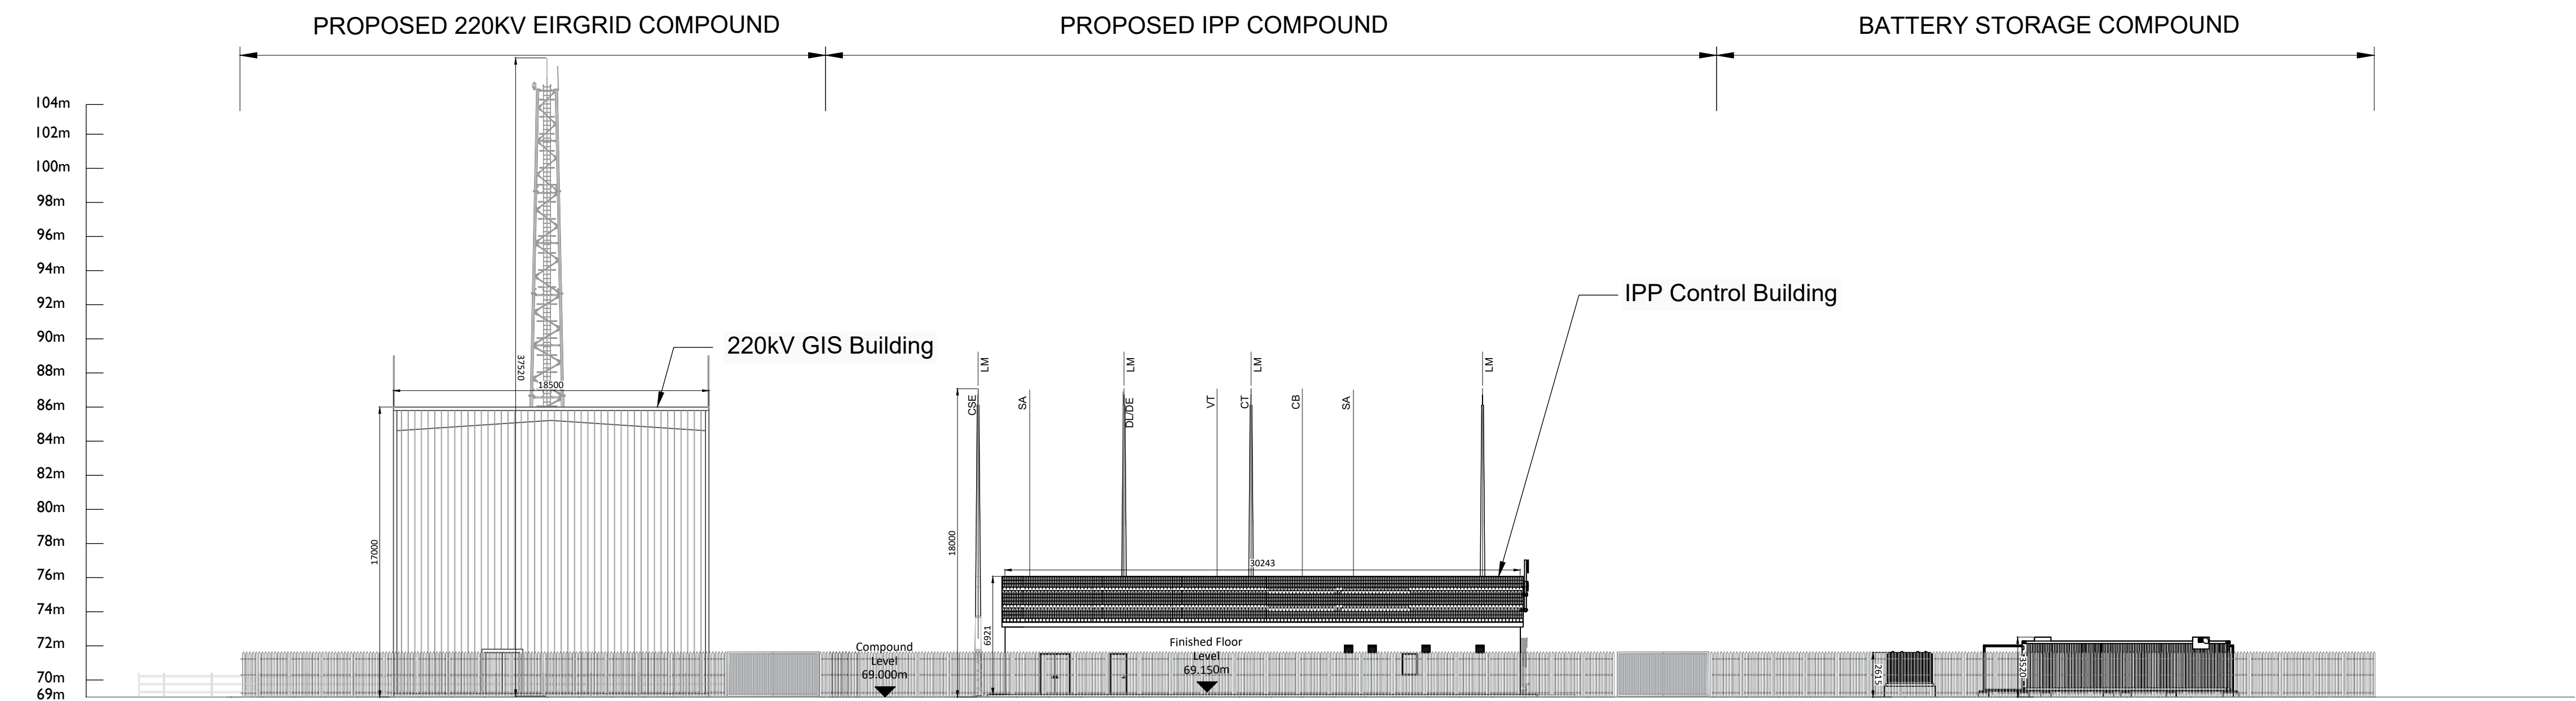


**North East Elevation**  
Scale: 1:250

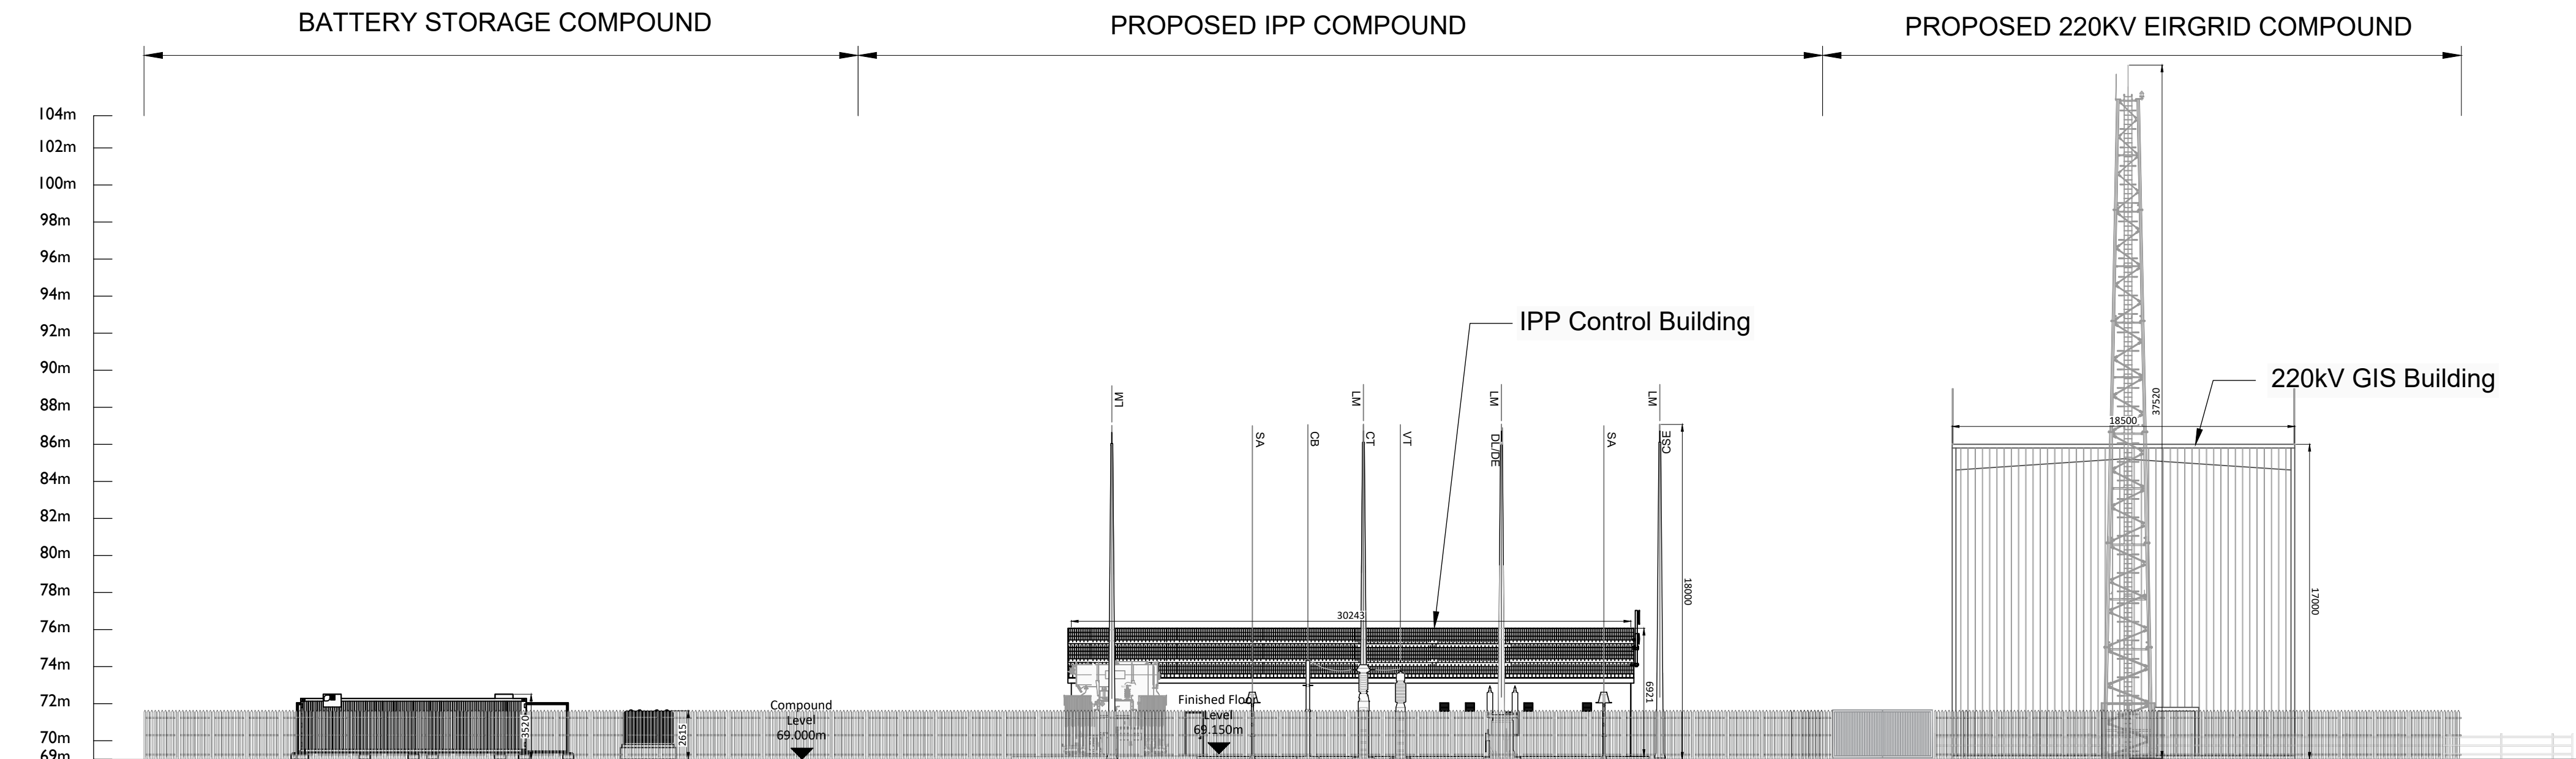

**South West Elevation**  
Scale: 1:250

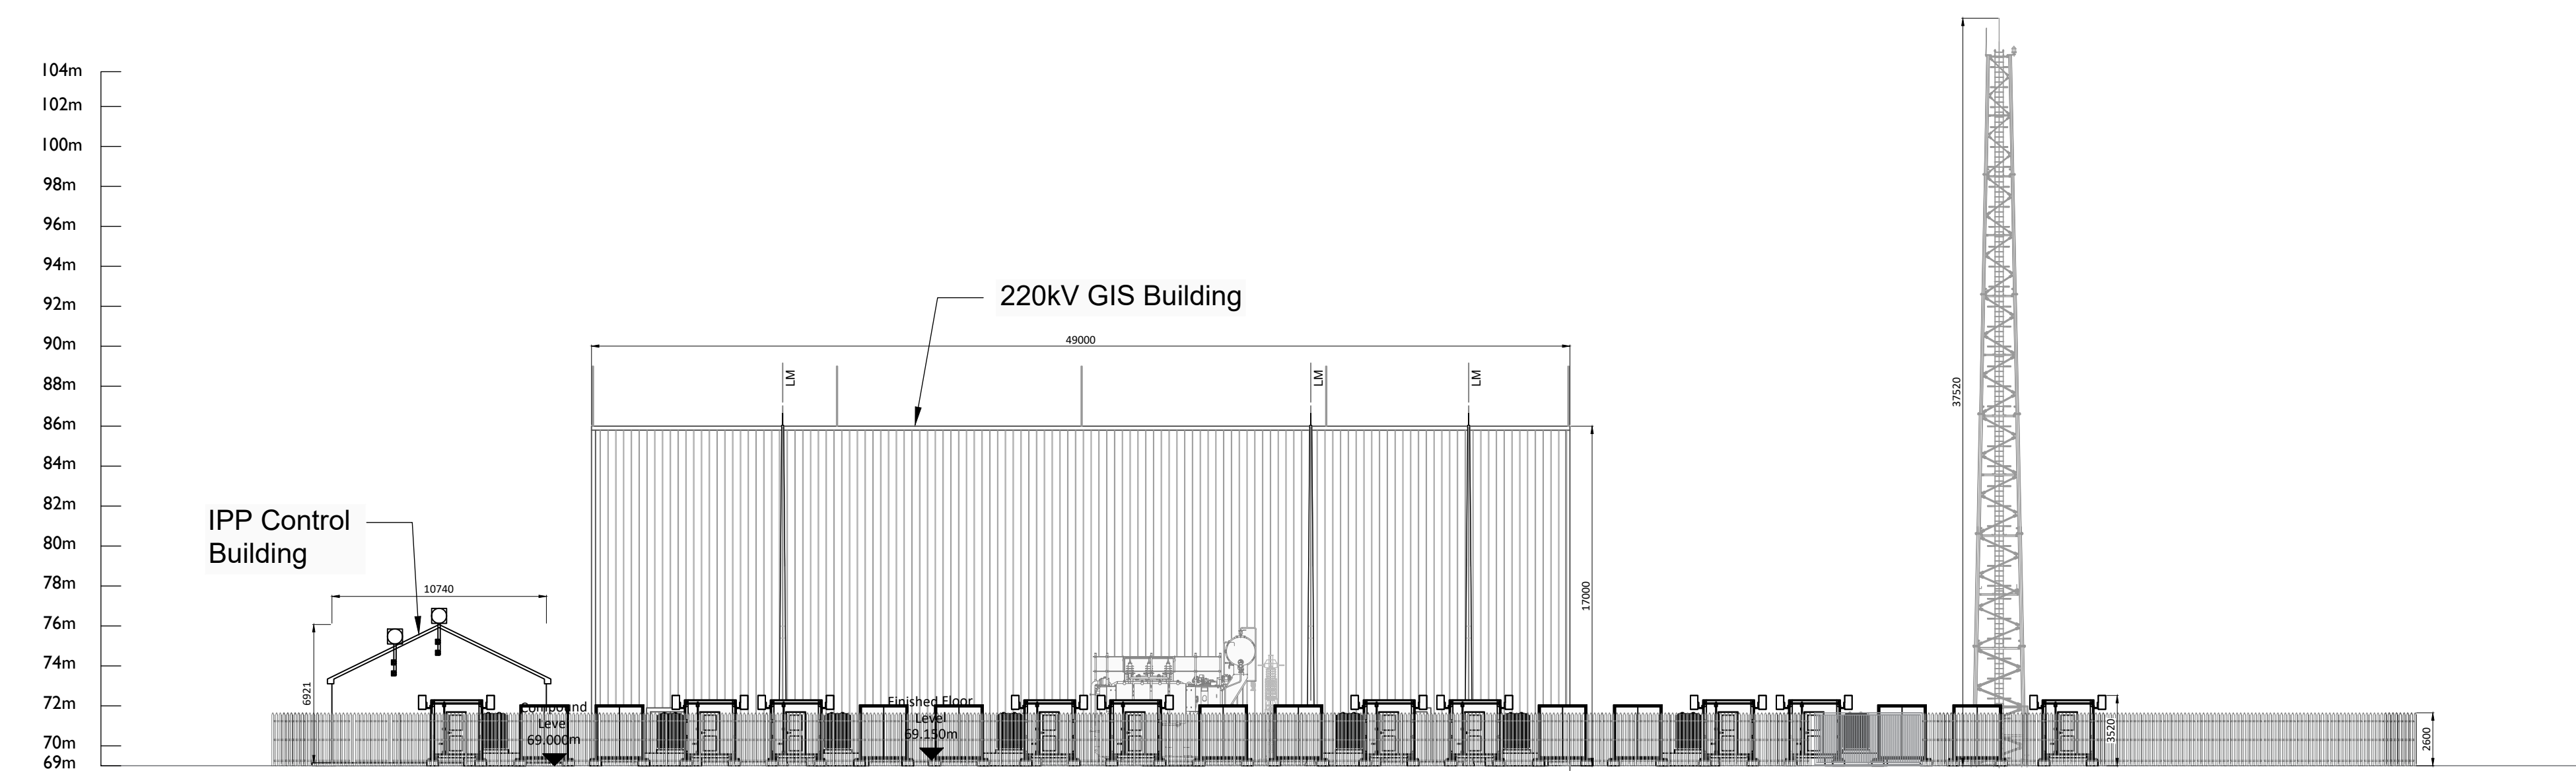

**North West Elevation**  
Scale: 1:250

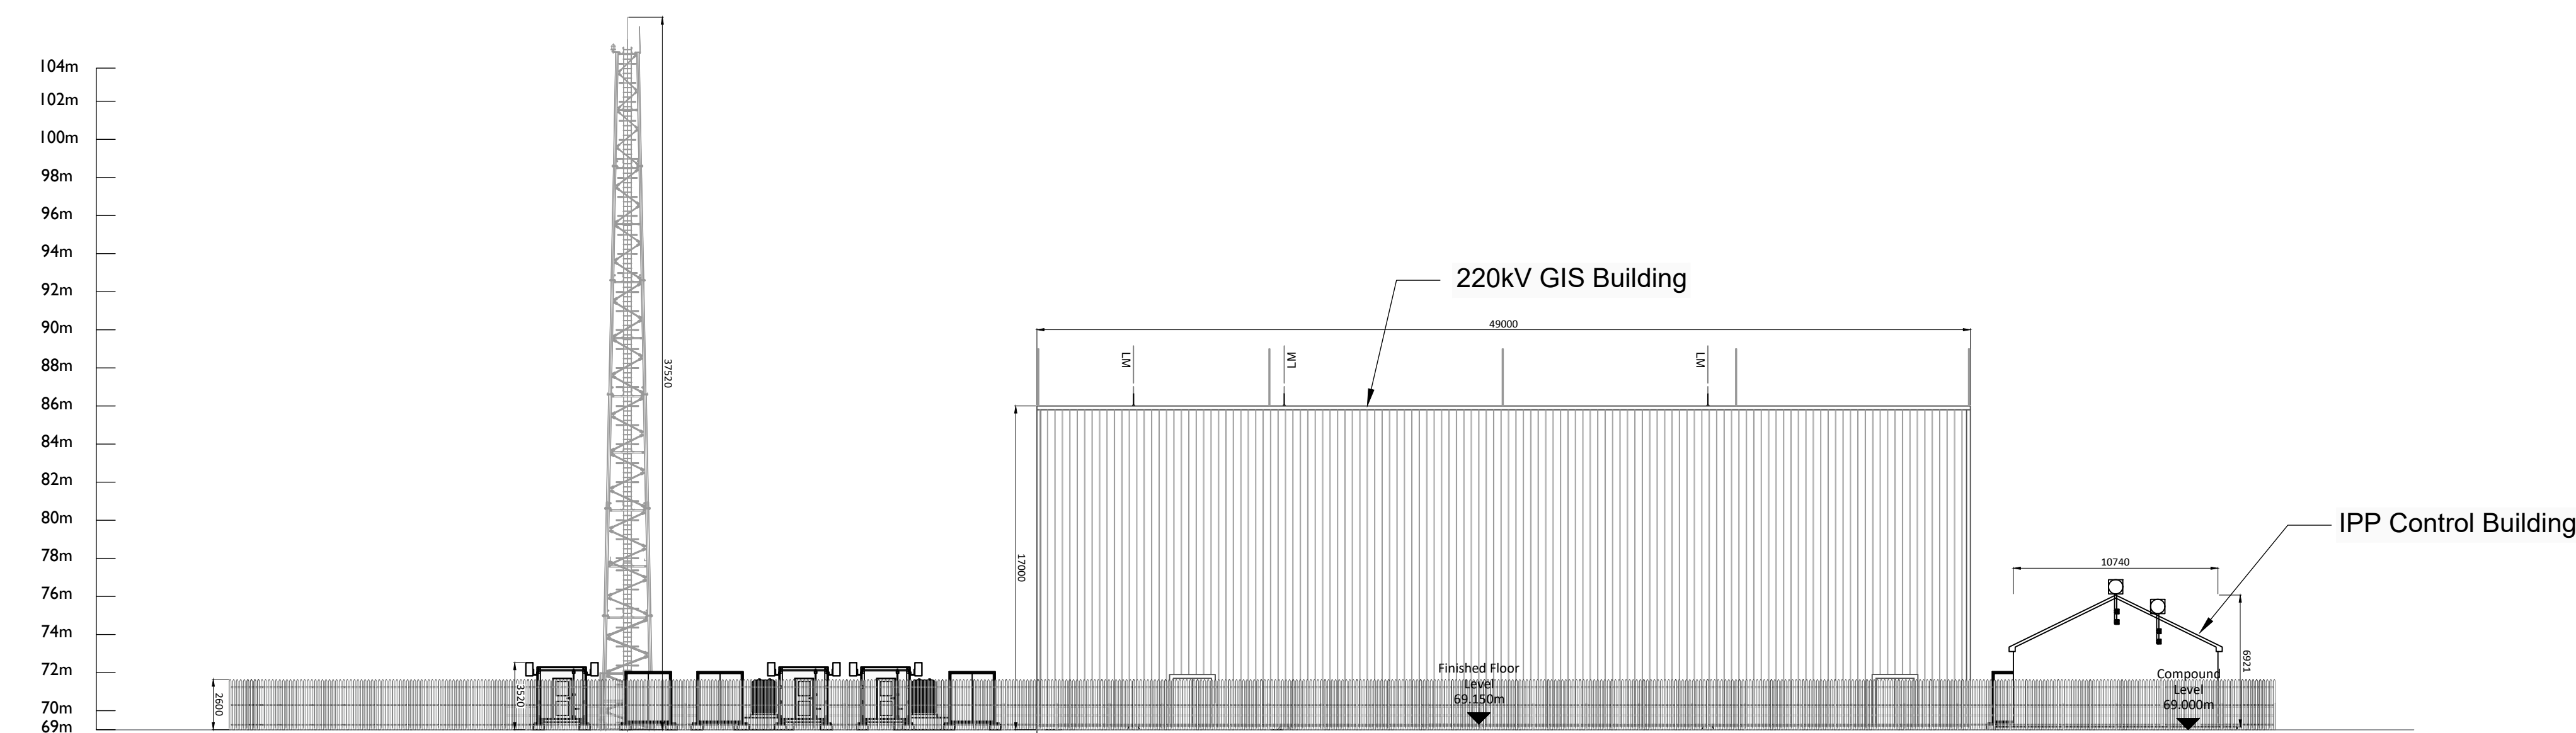

**South East Elevation**  
Scale: 1:250

PROJECT  
**Clonberne Wind Farm**  
**220kV Grid Connection**

CLIENT  
**Clonberne Windfarm Limited**

CONSULTANTS

NOTES: -  
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4. The Elevation of the Compound will be depicted by localized Topography such that Cuffill Earthworks associated with the construction of the Compound are balanced.

LEGEND: -	
	Description
CSE	Cable Sealing End.
SA	Surge Arrester
D/DE	Line / Earth Disconnect
VT	Voltage Transformer
CT	Current Transformer
CB	Circuit Breaker
LM	Lightning Mast


ISSUE/REVISION		
P1	04.06.24	Issued for Planning
IR	DATE	DESCRIPTION

KEY PLAN

PROJECT NUMBER  
05-990  
SHEET TITLE  
Substation Compound Elevations


SHEET NUMBER  
05990-DR-113



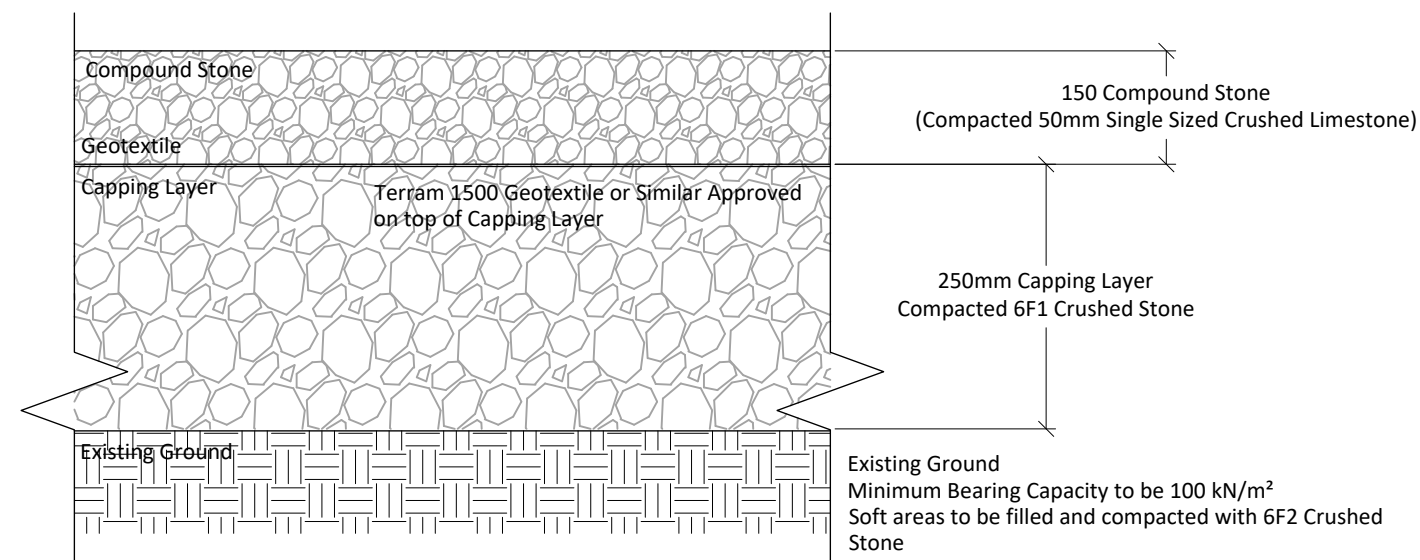


### Typical Compound Detail

SCALE 1:10

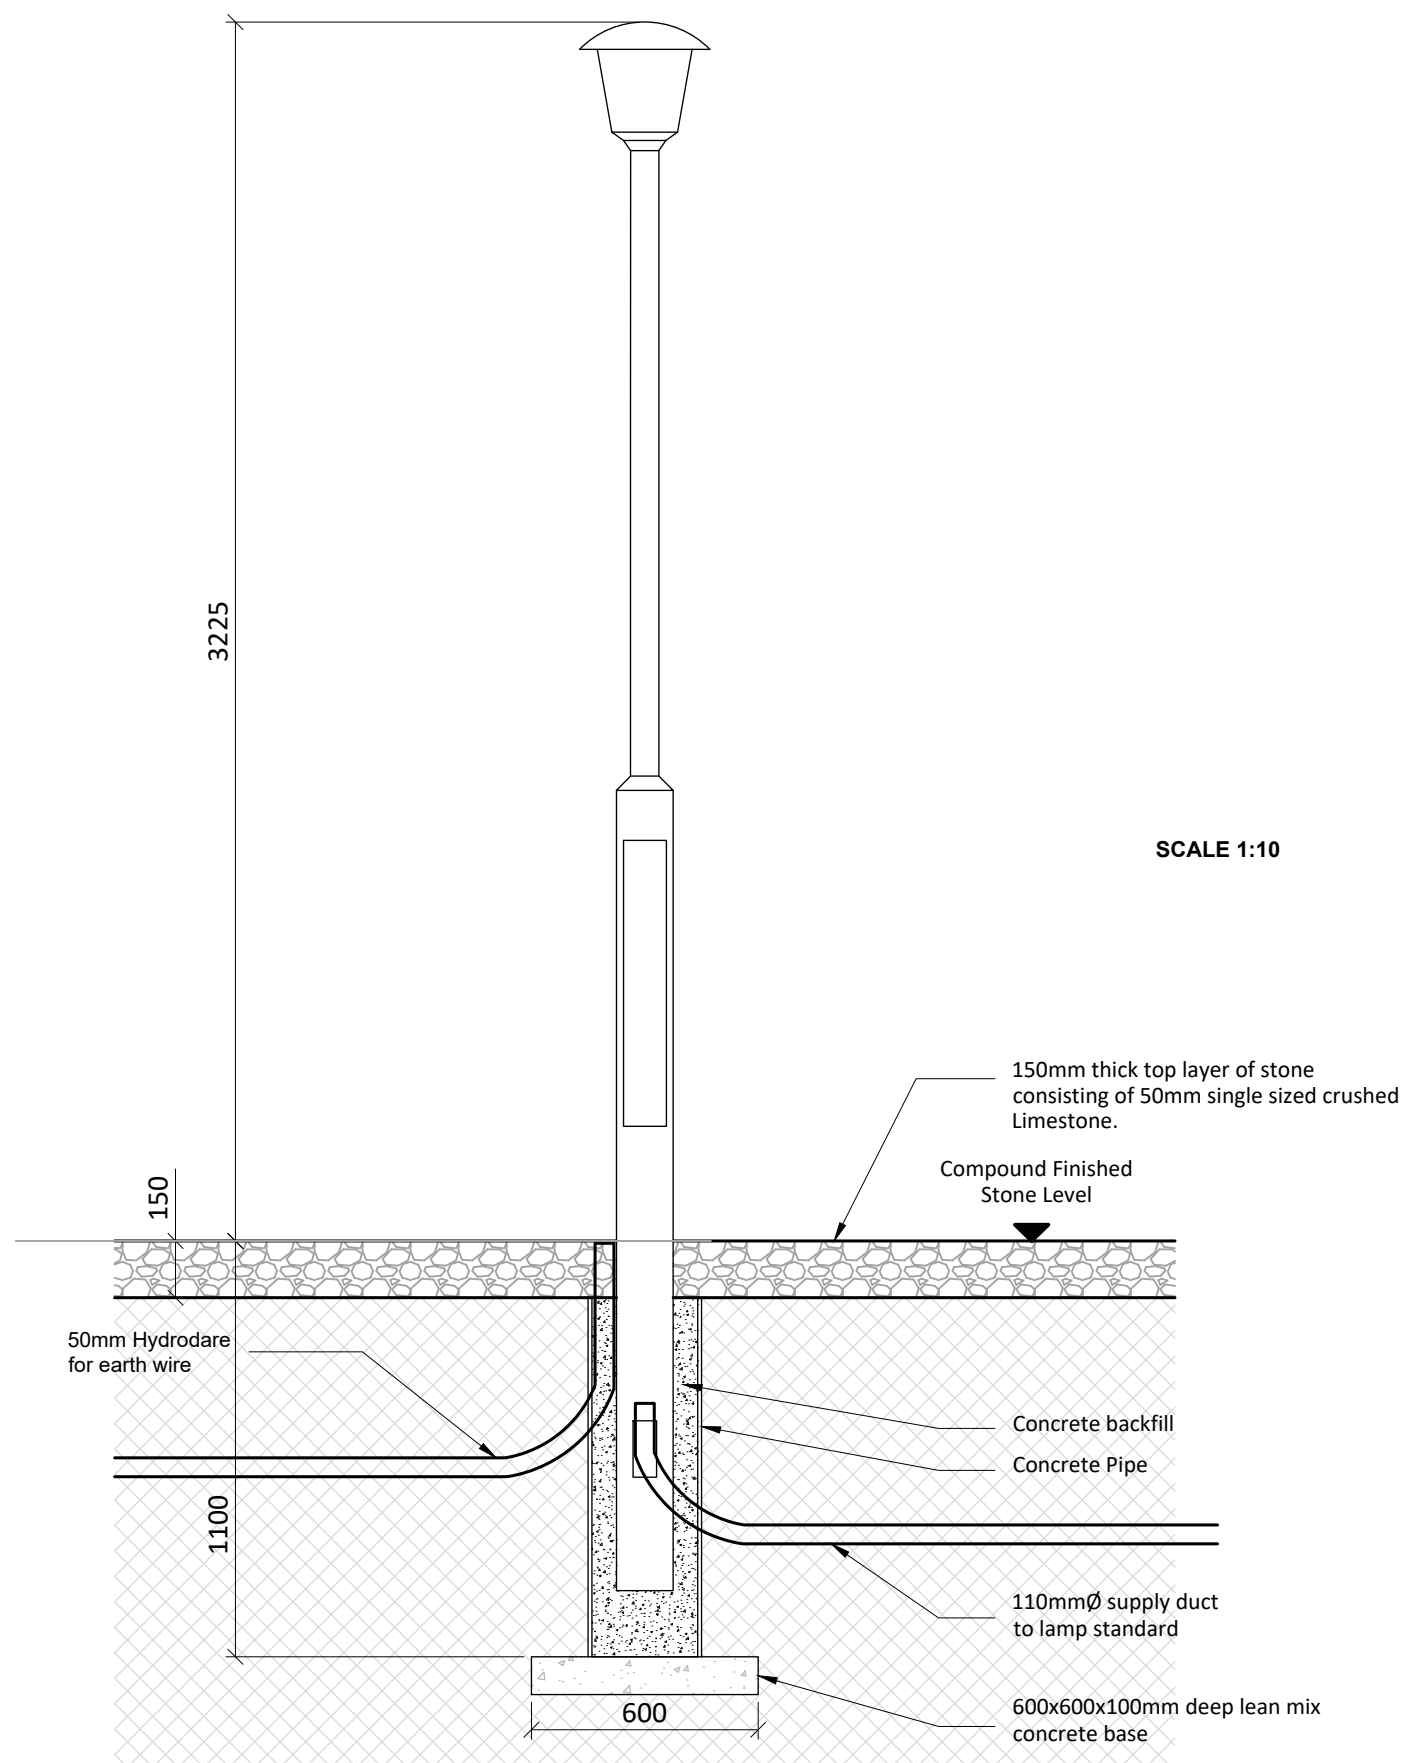


### Lighting Column & Surround Detail

SCALE 1:20

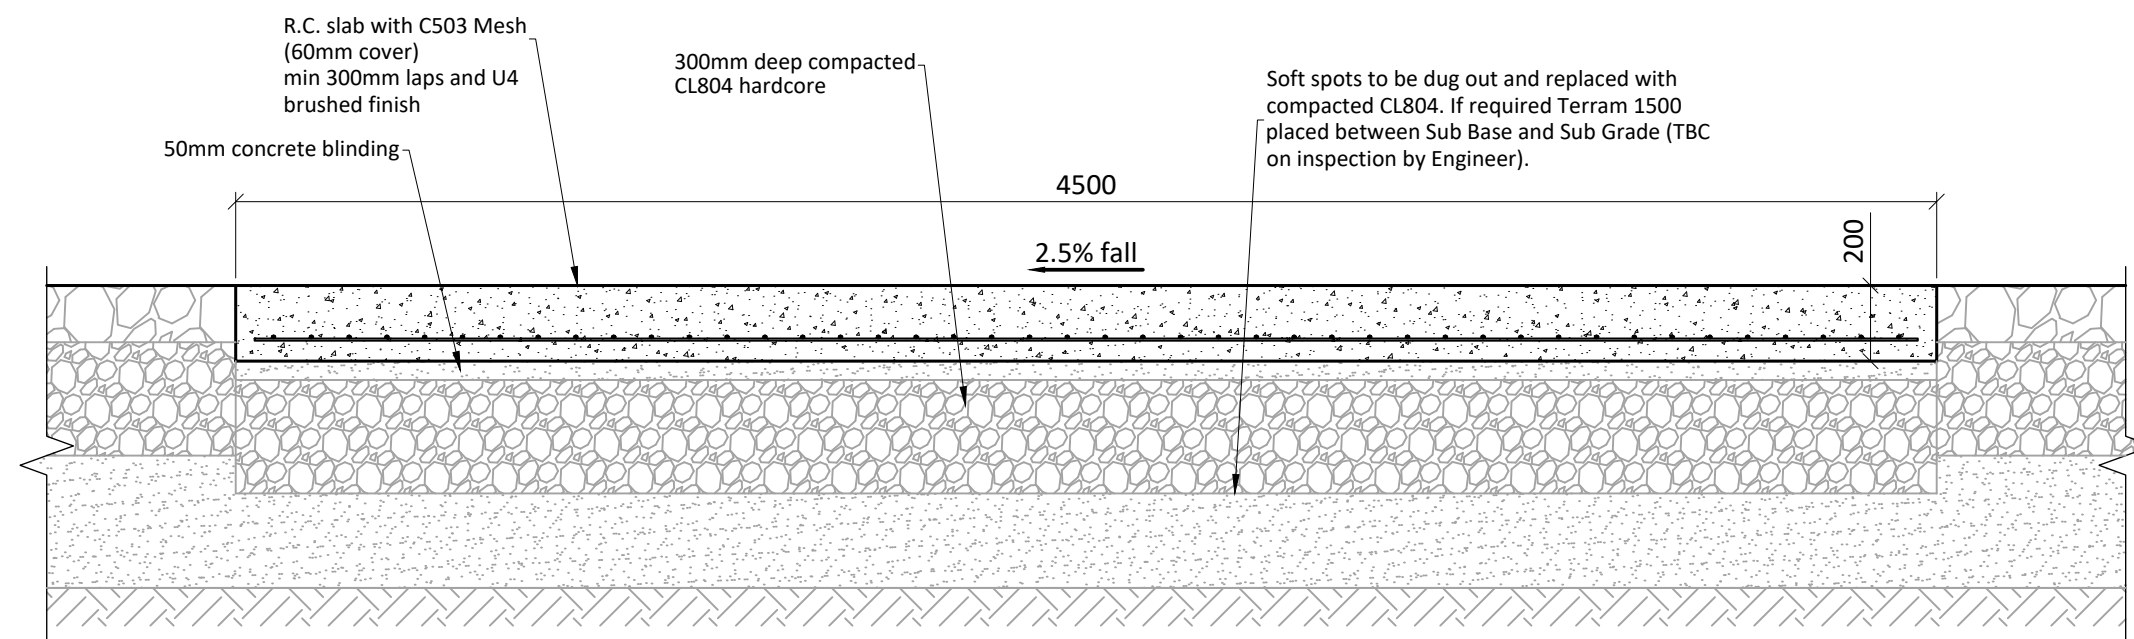


**Typical Section - Concrete Access Road**  
SCALE 1:20

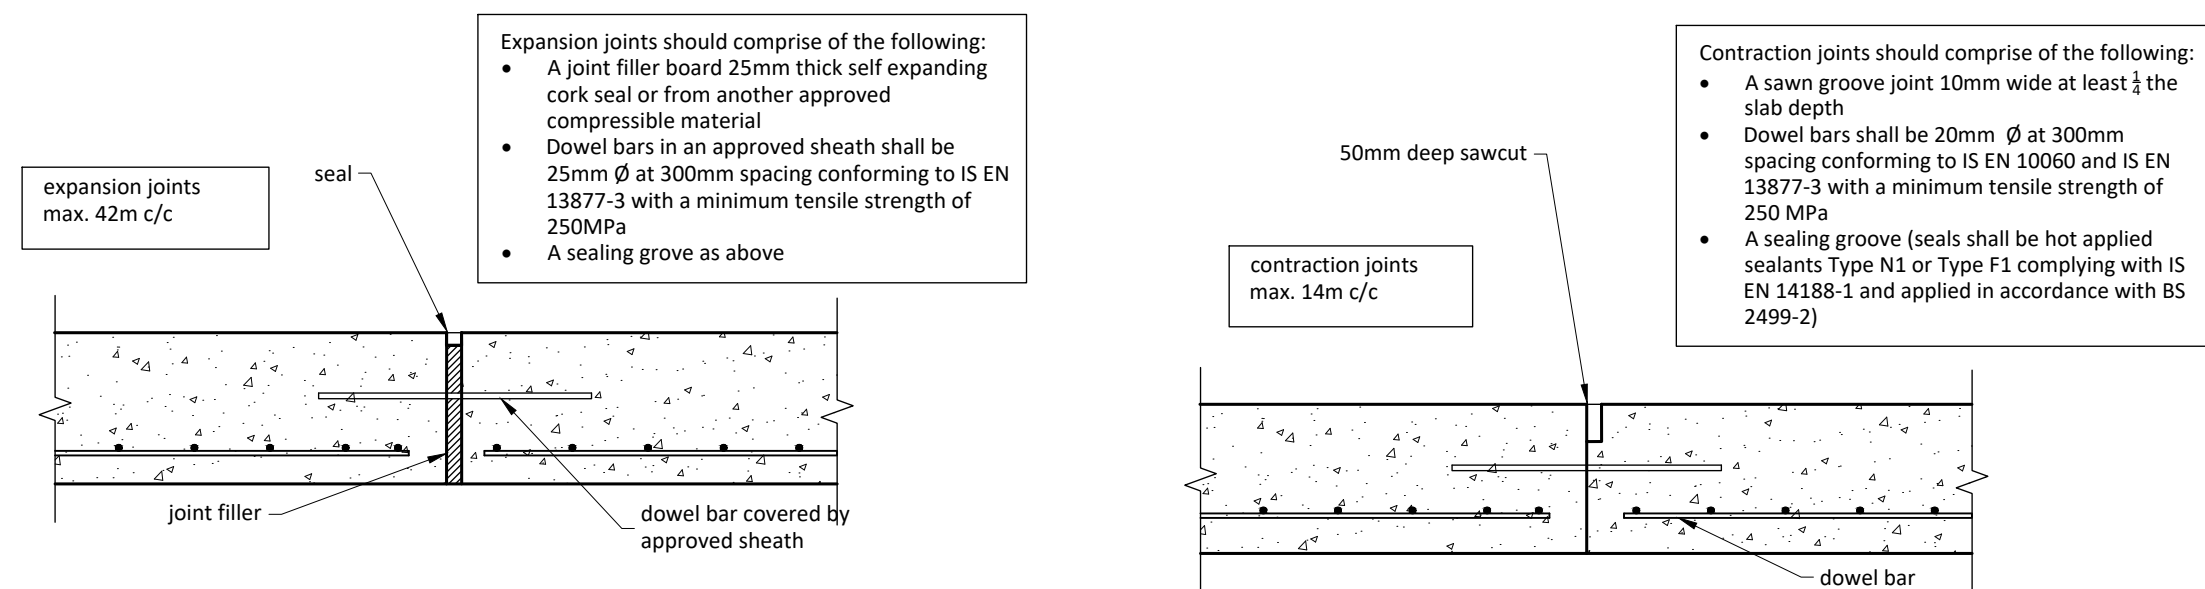

### Concrete Access Road Expansion Joint

### Concrete Access Road Contraction Joint

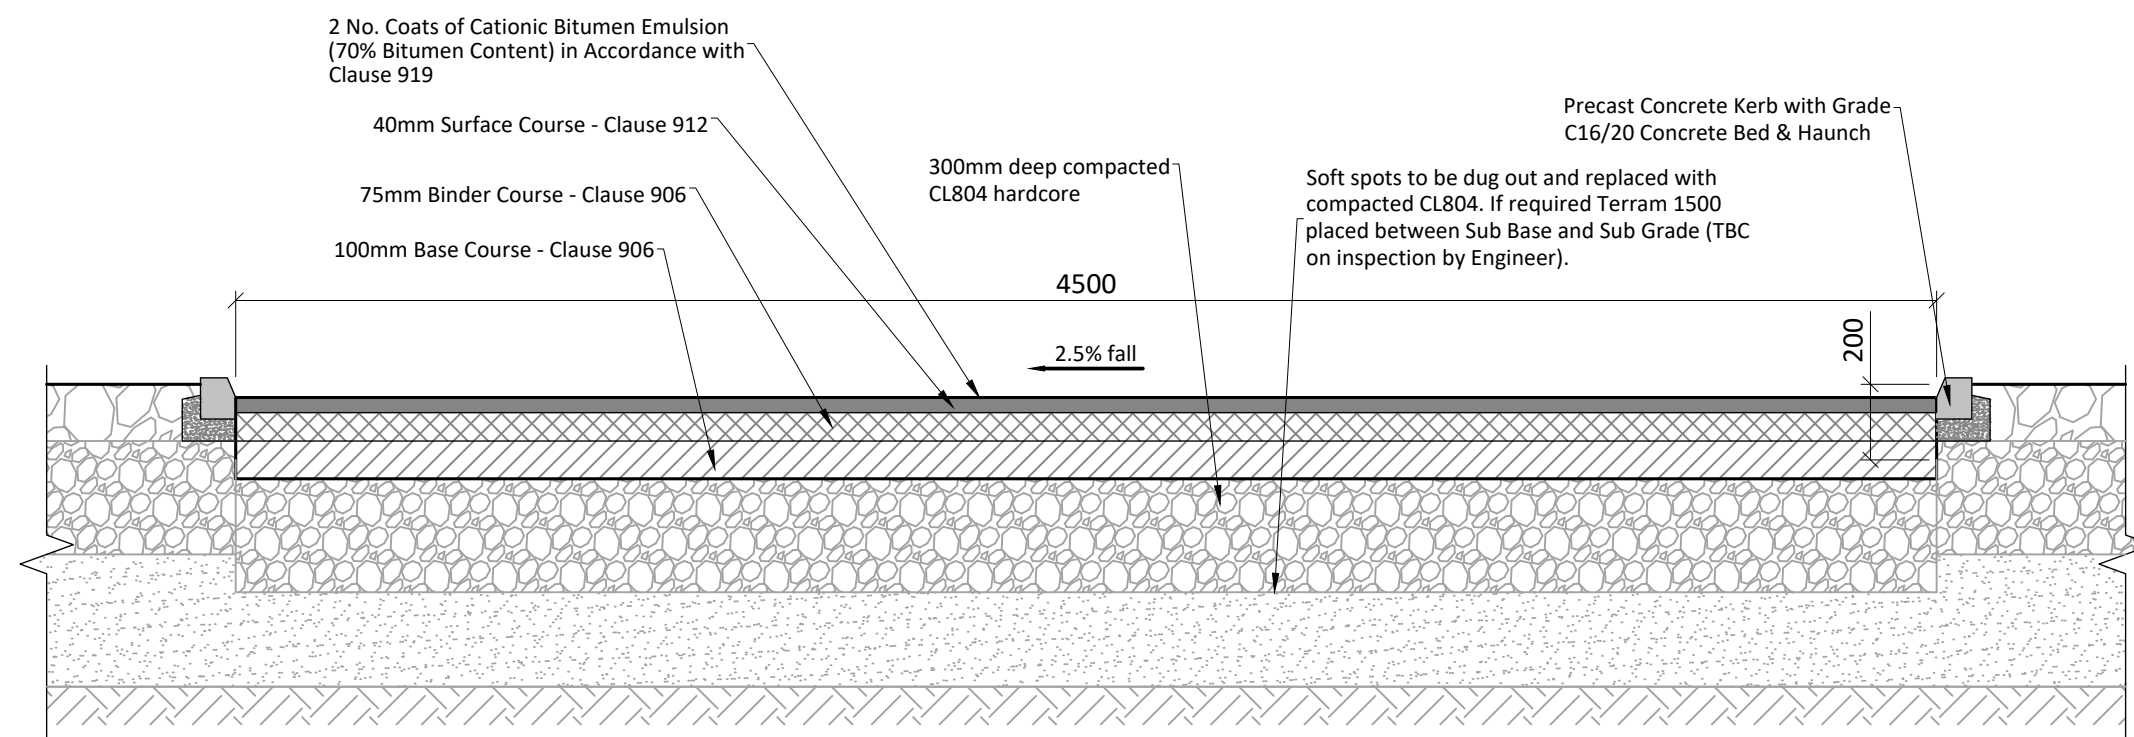

**Typical Section - Asphalt Access Road**  
SCALE 1:20

<b>ISSUE/REVISION</b>		
P1	04.06.24	Issued for Planning
I/R	DATE	DESCRIPTION









ISO A1 594mm x 841mm


Project Management Initials: Designer: CH Checked: GD Approved: RG

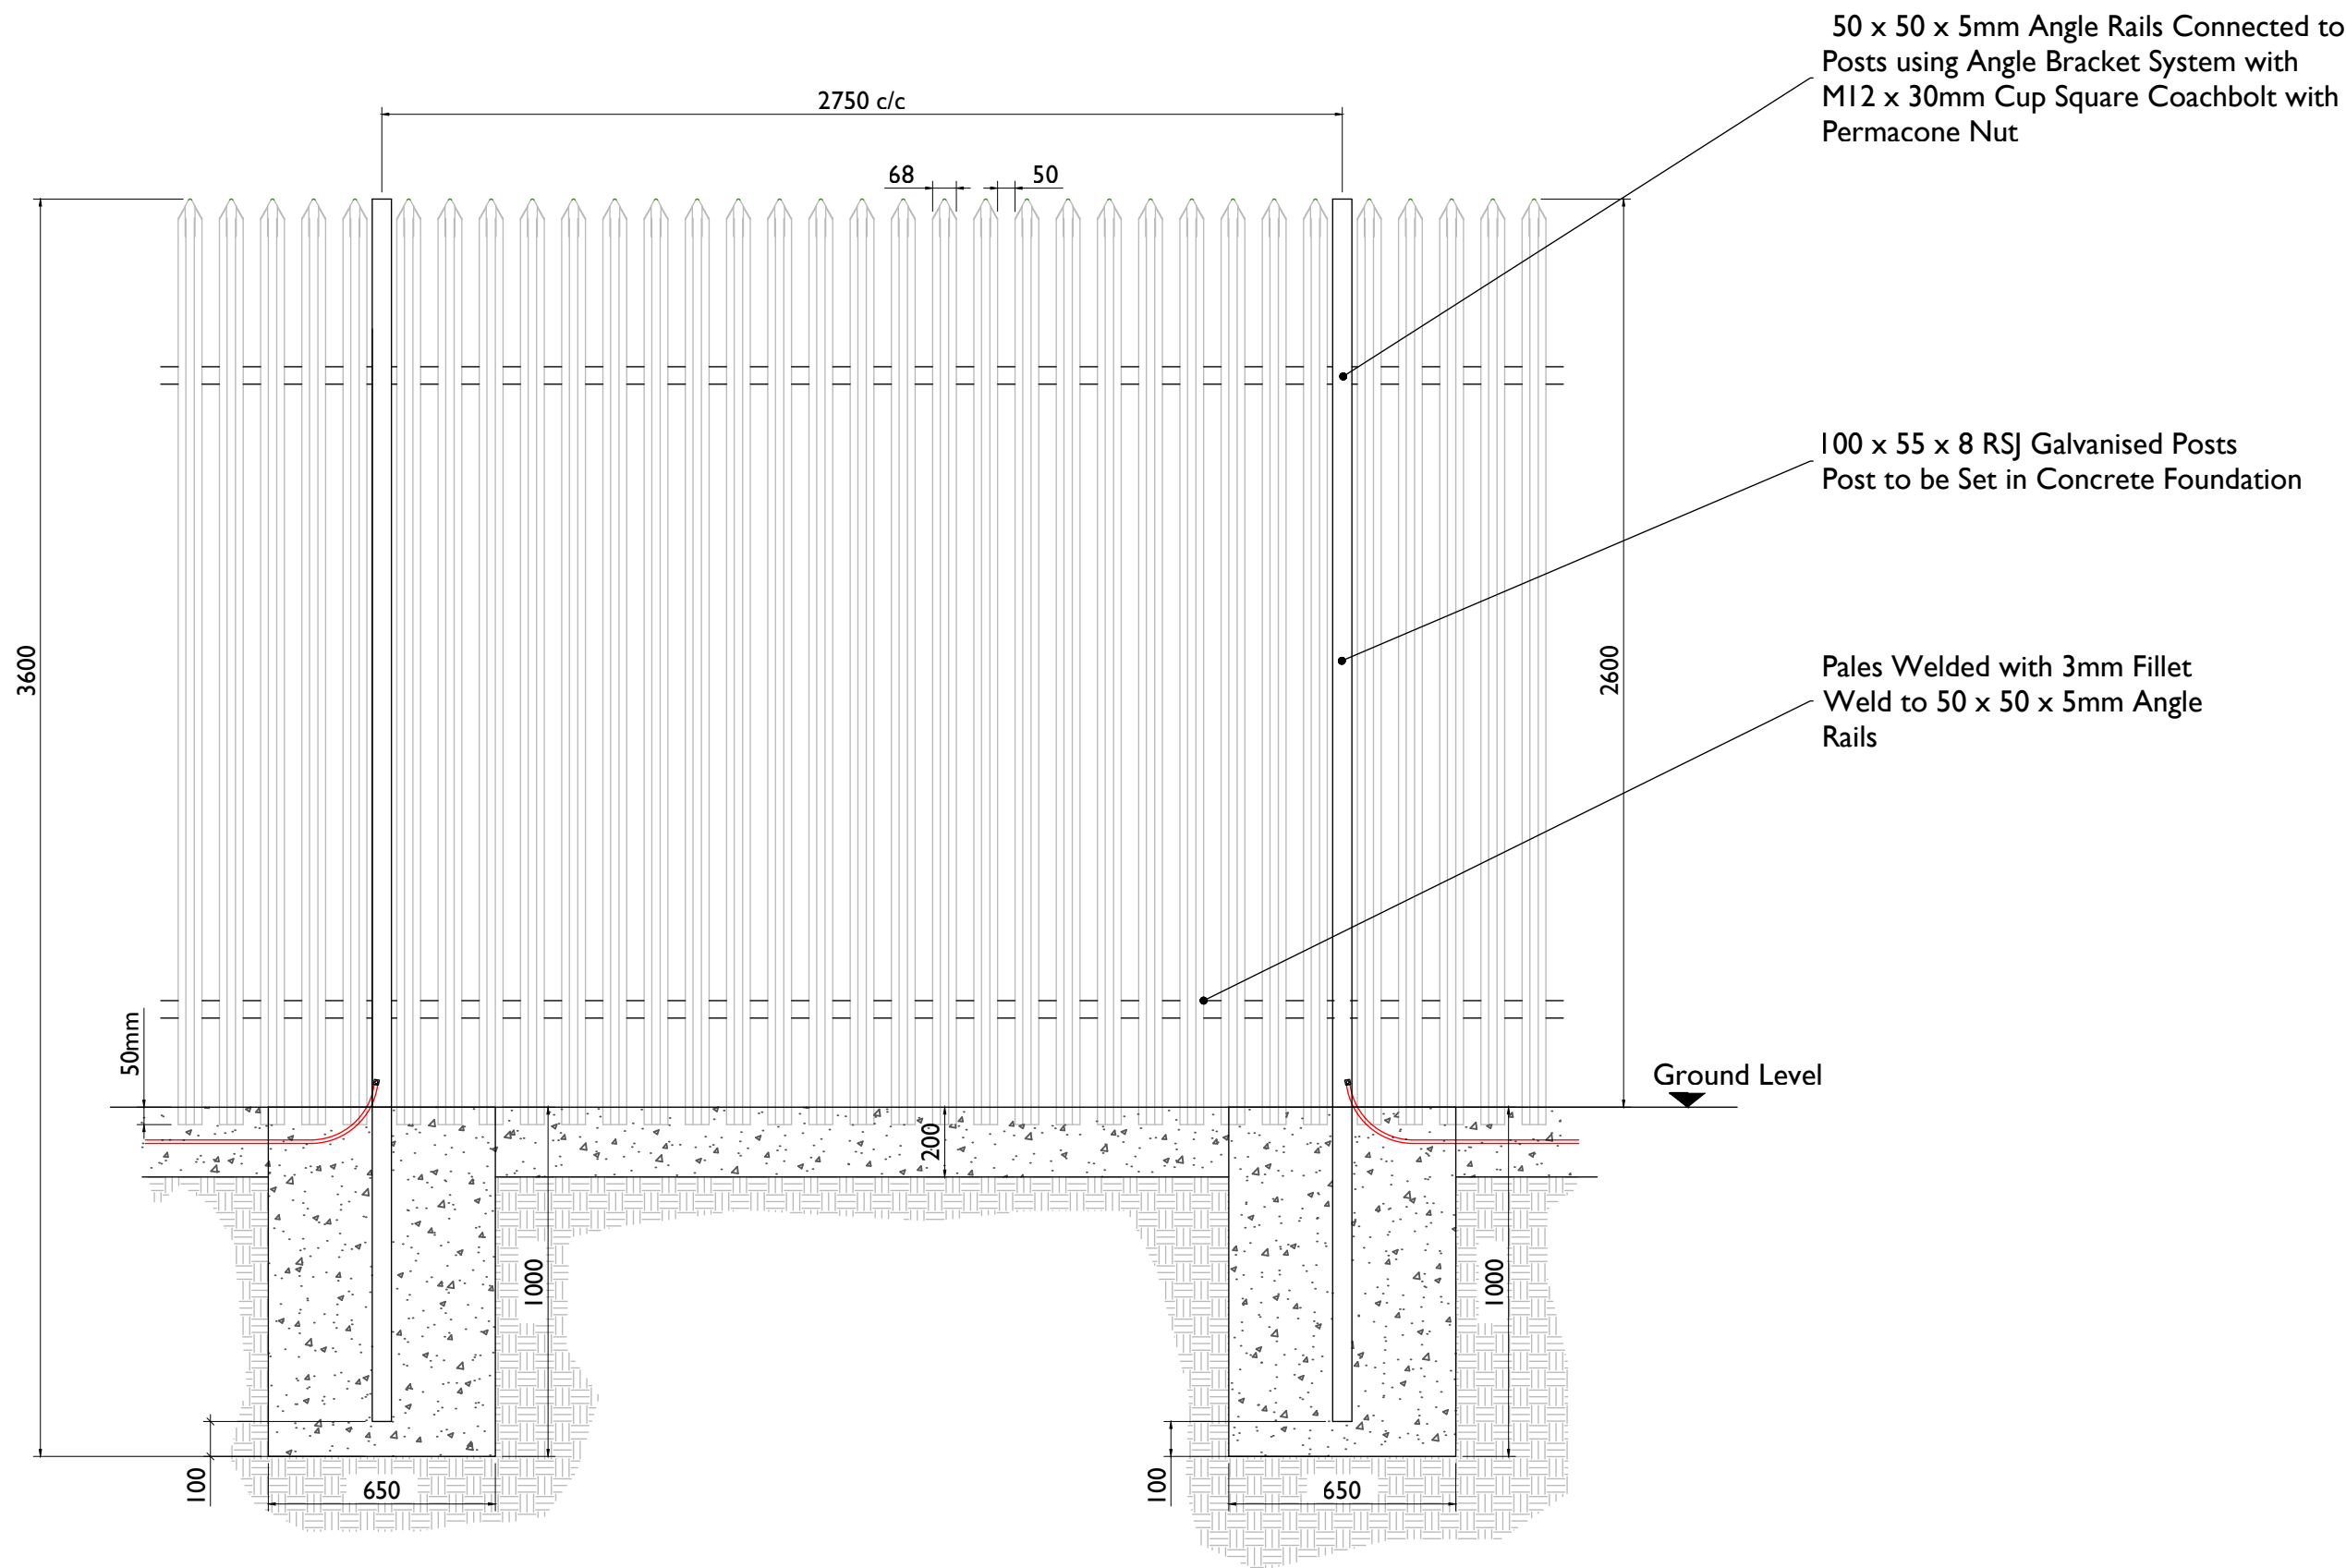

**PALISADE FENCING DETAILS - ELEVATION**  
SCALE 1:20

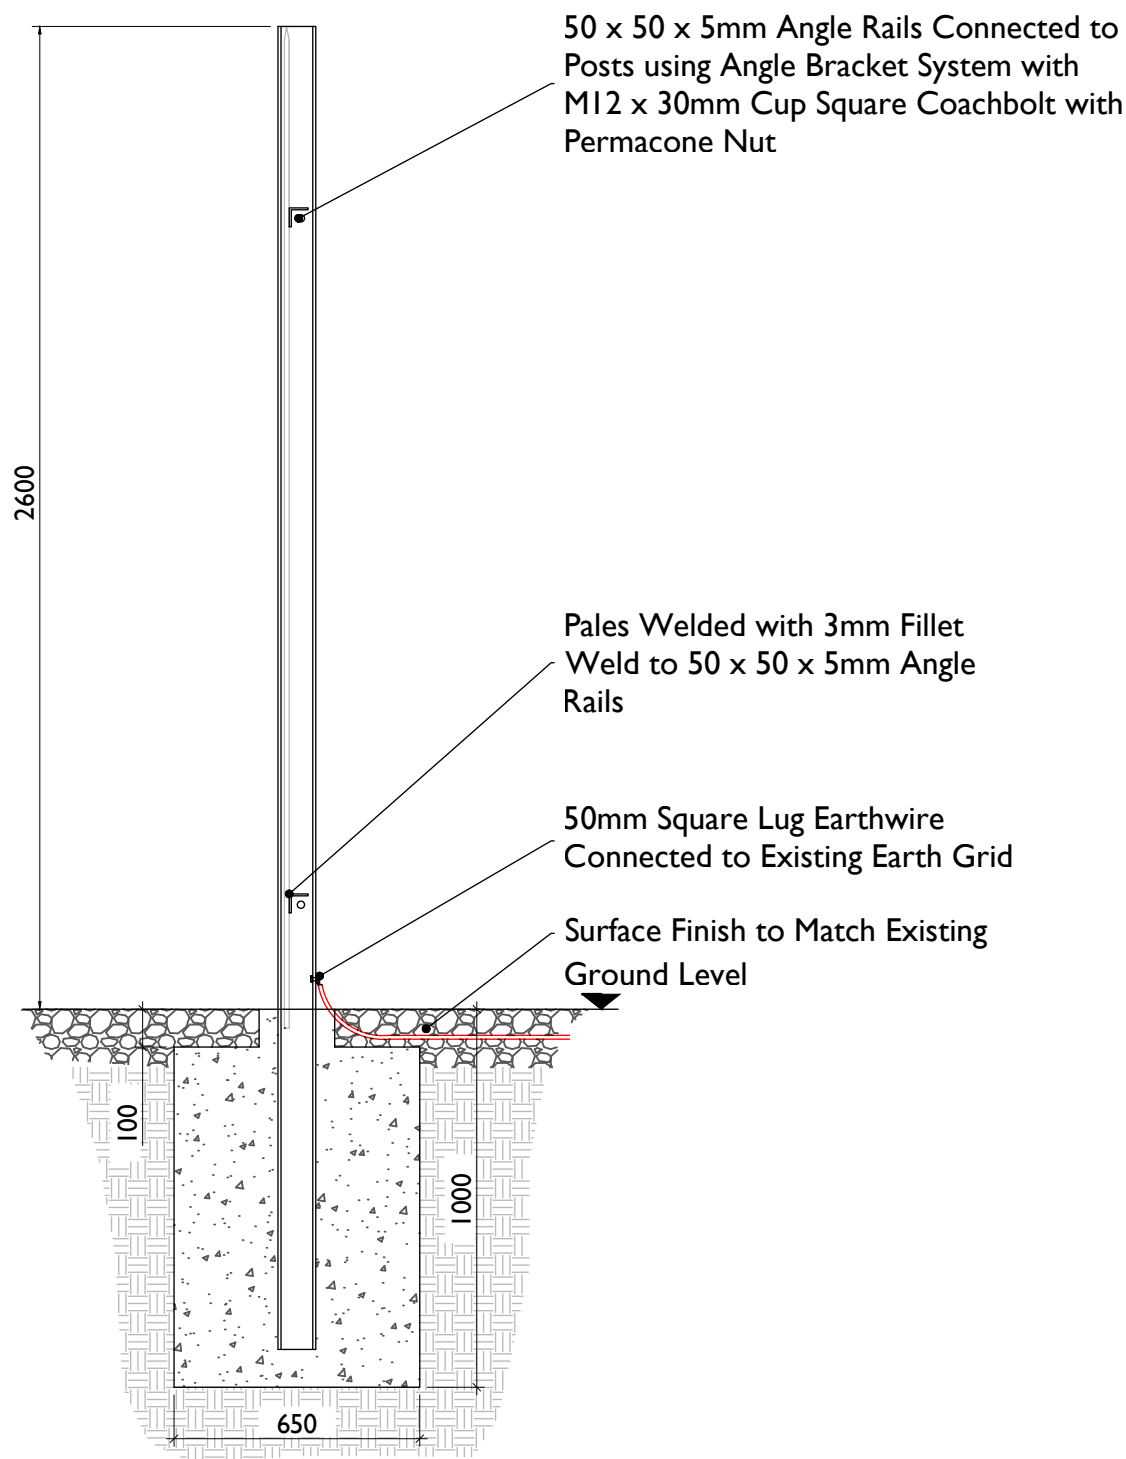

**PALISADE FENCING DETAILS - SECTION**  
SCALE 1:20

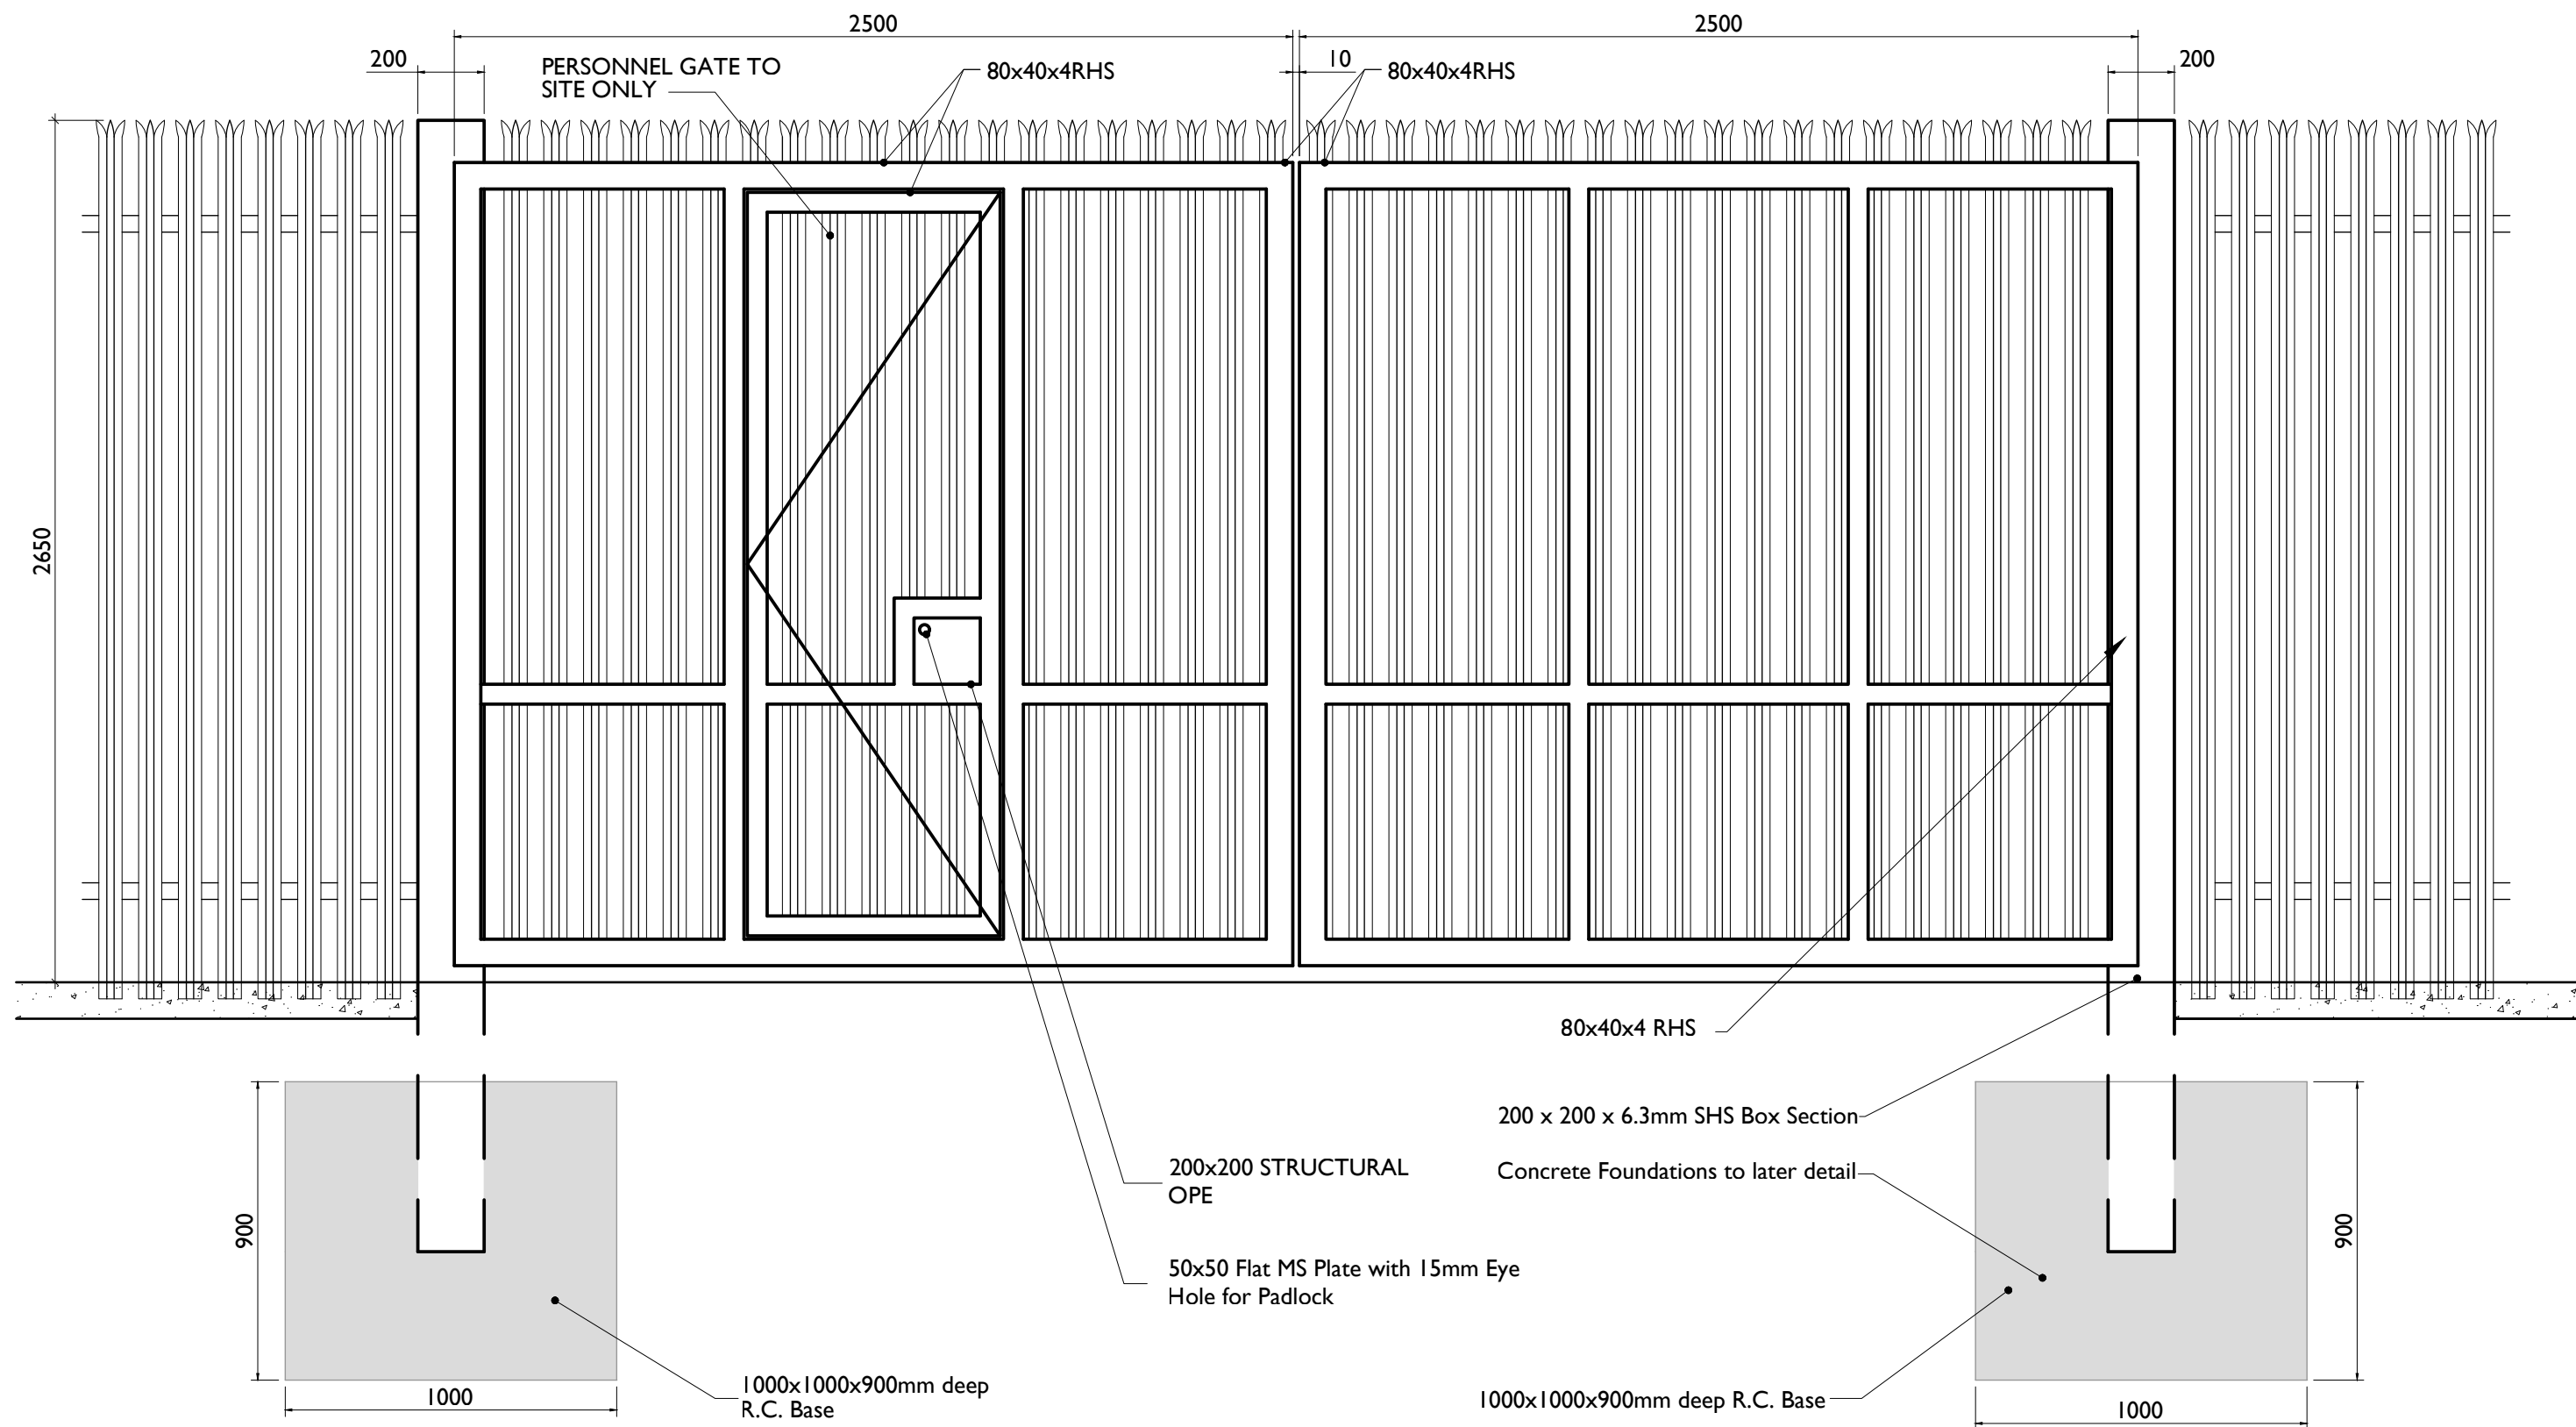

**PALISADE FENCING DETAILS - ELEVATION**  
SCALE 1:20

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Tel: 00 44 1256406664

PROJECT

**Clonberne Wind Farm**  
**220kV Grid Connection**

CLIENT

**Clonberne Windfarm Limited**

CONSULTANTS

- NOTES: -
- This drawing is to be read in conjunction with relevant drawings, specifications and reports
  - Dimensions are in millimetres, unless noted otherwise
  - Drawings are not to be scaled use figured dimensions only

LEGEND: -

ISSUE/REVISION		
P1	04.06.24	Issued for Planning
I/R	DATE	DESCRIPTION

PROJECT NUMBER


**05-990**

SHEET TITLE

**Gate & Fencing Details**

SHEET NUMBER

**05990-DR-1116**

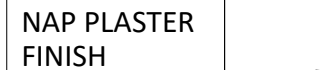


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Scale : 1:75




Scale : 1:75



Scale : 1:75

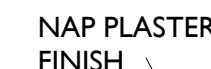Scale : 1:75

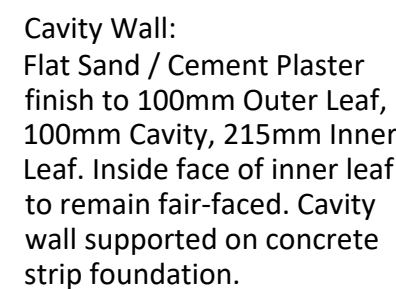

Scale : 1:75

# Clonberne Wind Farm 220kV Grid Connection

Clonberne Windfarm Limited

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4. The Elevation of the Compound will be depicted by localized Topography such that Cut/Fill Earthworks associated with the construction of the Compound are balanced.

Levels shown thus 93.340m 

Concrete Footpath shown thus 


P1	04.06.24	Issued for Planning
I/R	DATE	DESCRIPTION

## MV Customer Switchgear Room Plan And Elevations & Section




ISO A1 594mm x 841mm

Project Management Initials: Designer: RR Checked: CH Approved: AC

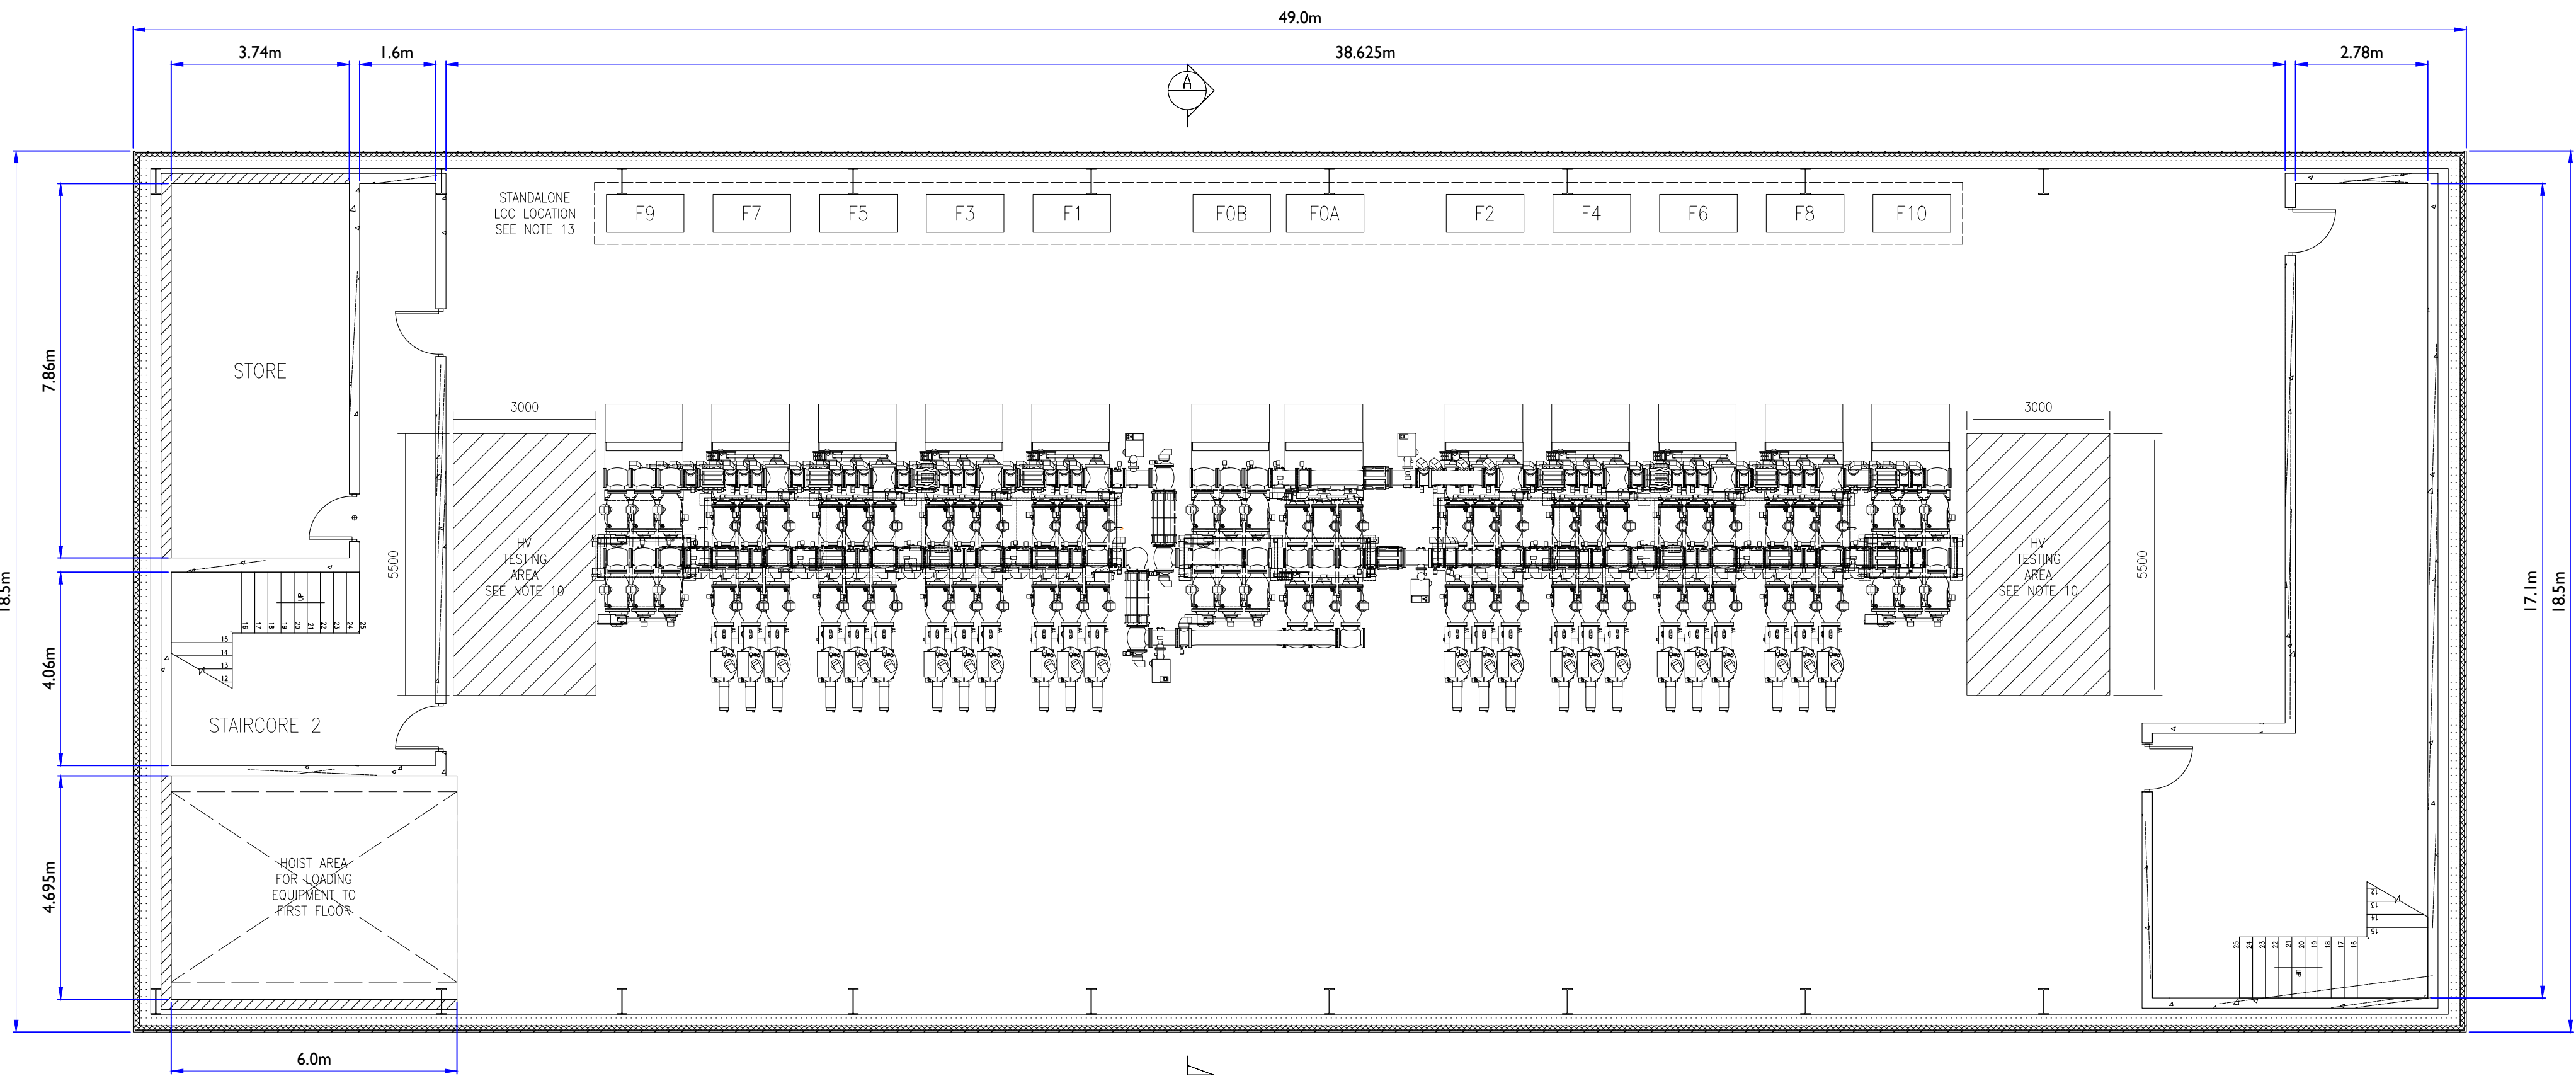

FIRST FLOOR PLAN  
SCALE: 1:100

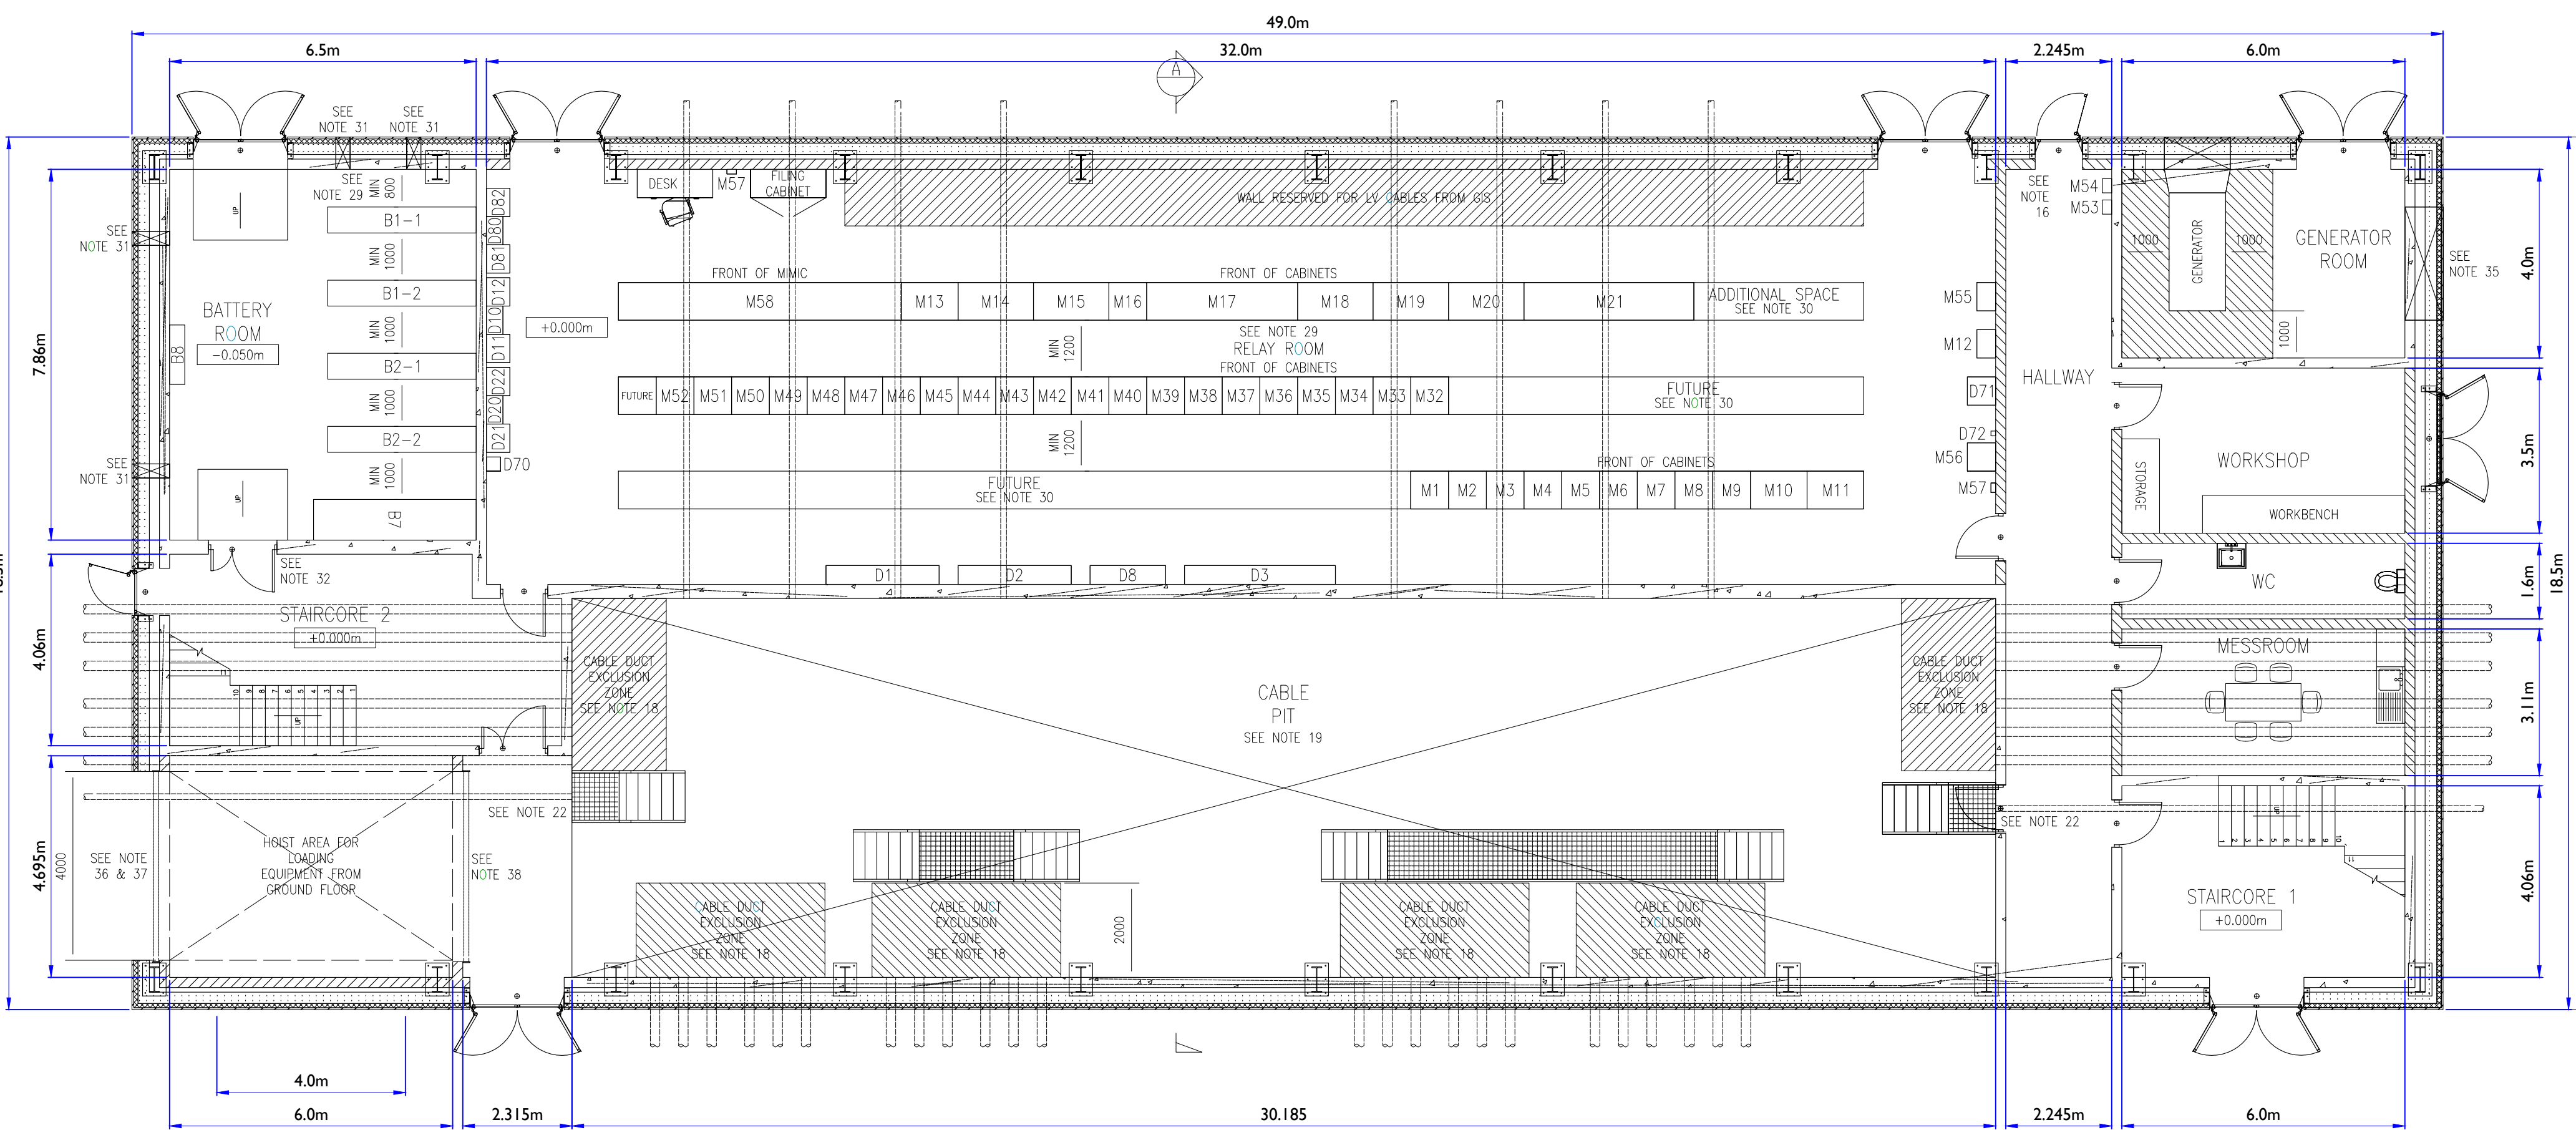

GROUND FLOOR PLAN  
SCALE: 1:100



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PROJECT

Clonberne Wind Farm  
220kV Grid Connection

CLIENT

Clonberne Windfarm Limited

CONSULTANTS

NOTES: -

LEGEND: -

ISSUE/REVISION

NO.	DATE	DESCRIPTION
P1	04.06.24	Issued for Planning
I/R	DATE	DESCRIPTION

PROJECT NUMBER

05-990

SHEET TITLE

220kV GIS Building  
General Arrangement  
Ground & First Floor Plans


SHEET NUMBER

05990-DR-118



ISO A1 594mm x 841mm

Project Management Initials: Designer: RR Checked: CH Approved: AC

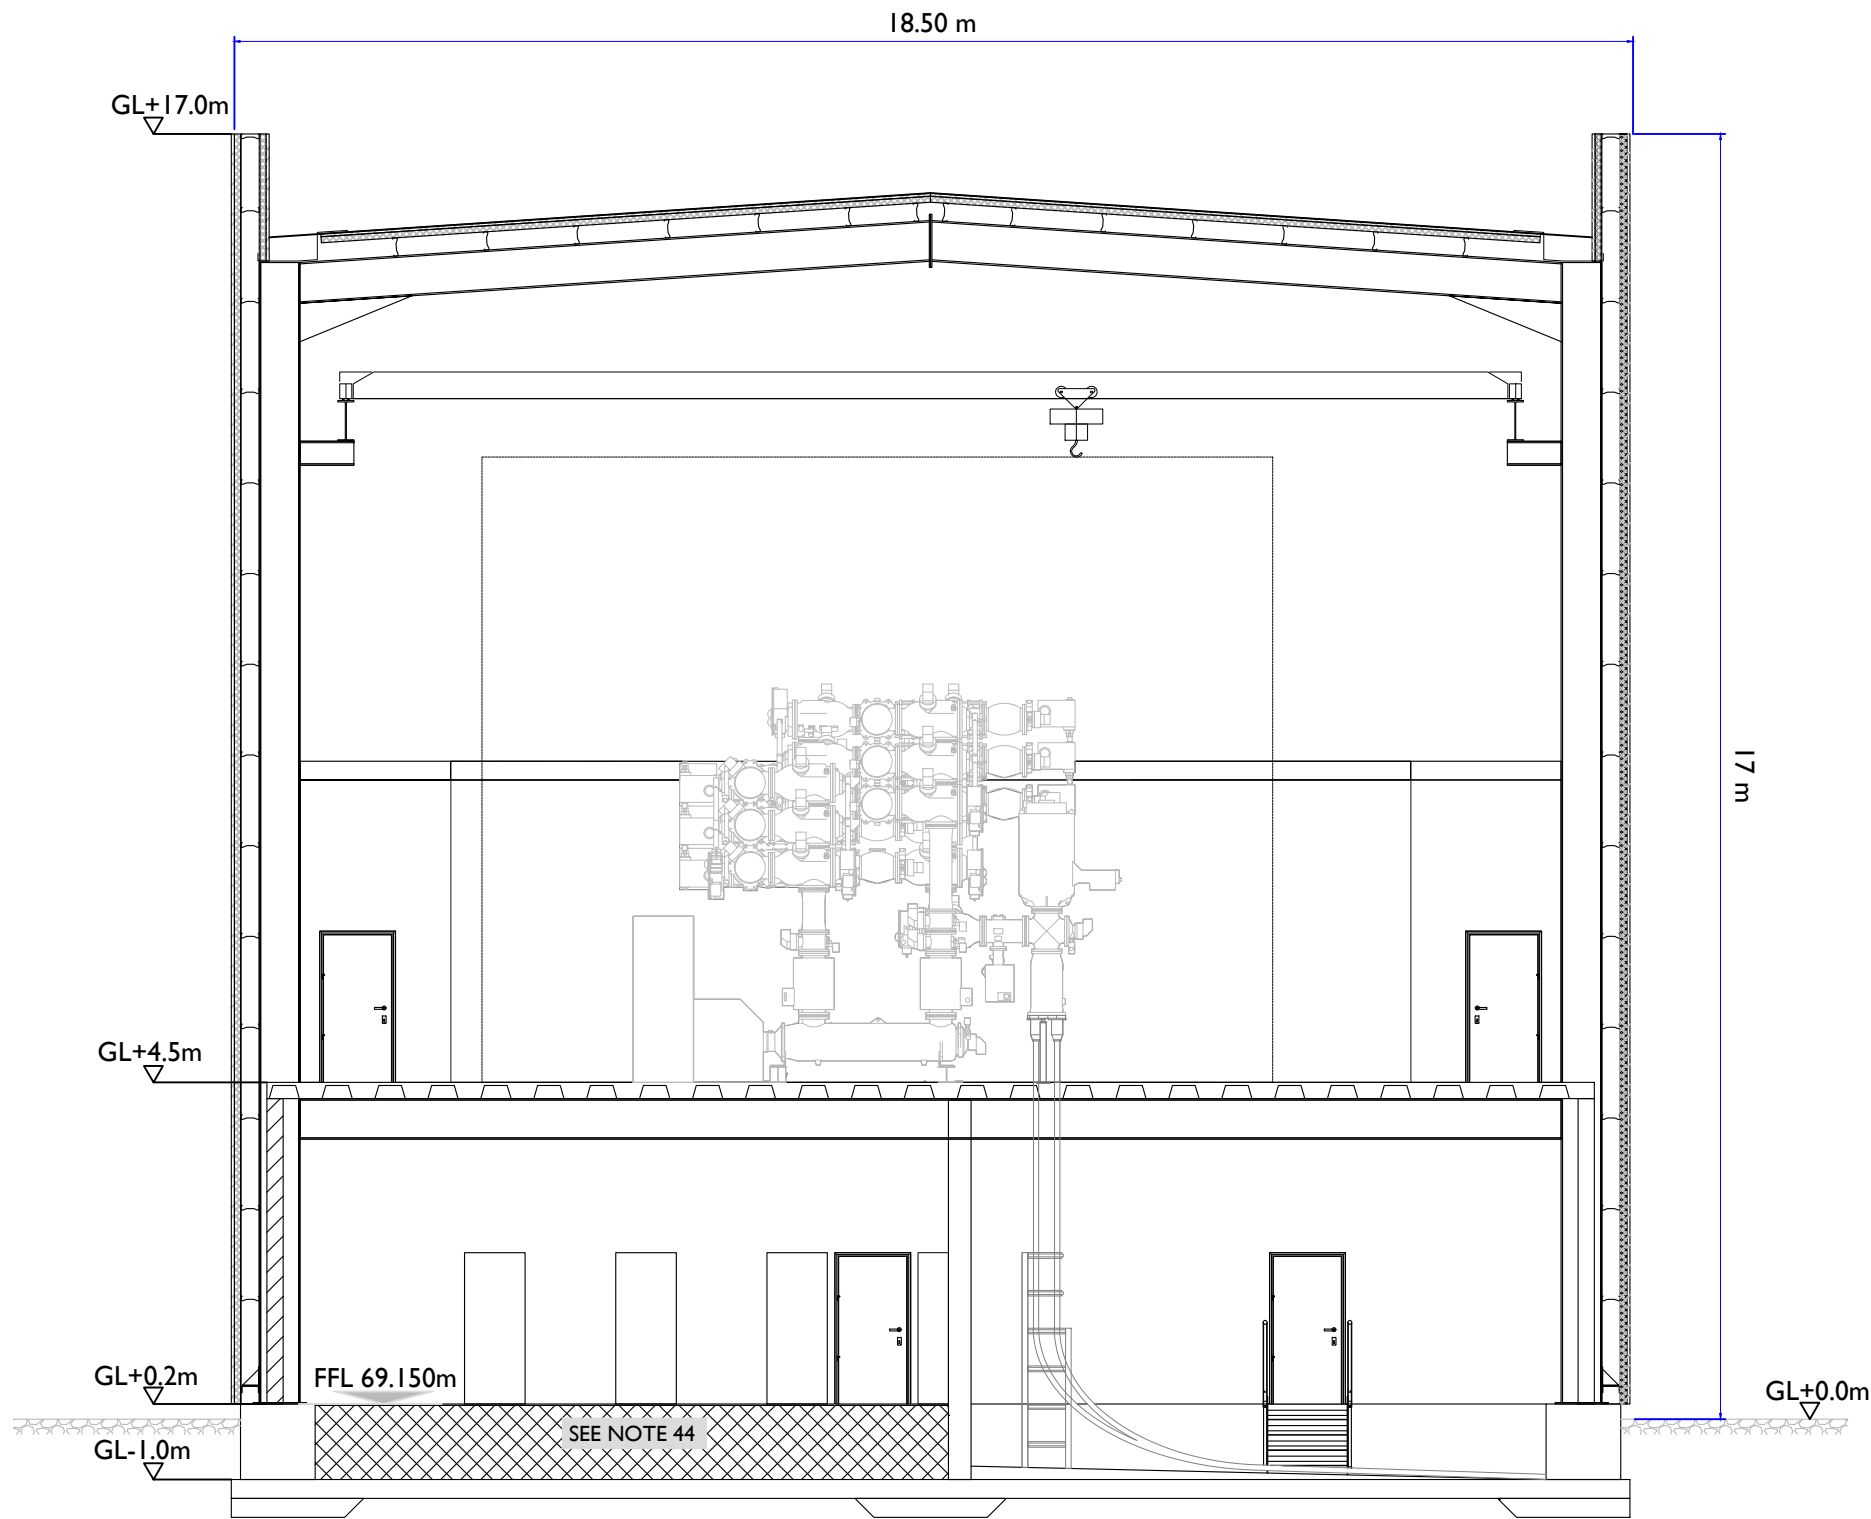

ELEVATION - SECTION A-A  
SCALE: 1:100

CABINET/EQUIPMENT LIST		
CABINET DESIGNATION	DESCRIPTION	DIMENSIONS
B1-1	220V DC BATTERY 1, STAND 1	3150x550
B1-2	220V DC BATTERY 1, STAND 2	3150x550
B2-1	220V DC BATTERY 2, STAND 1	3150x550
B2-2	220V DC BATTERY 2, STAND 2	3150x550
B7	48V DV TELECOMS BATTERY	3450x860
B8	48V DC STATION BATTERY	1260x320
D1	220V DC DISTRIBUTION BOARD 1	2400x400
D2	220V DC DISTRIBUTION BOARD 2	2400x400
D8	48V DC DISTRIBUTION BOARD	1600x400
D3	AC DISTRIBUTION BOARD	3200x400
D10	220V BATTERY No. 1 CHARGER CHANGEOVER SWITCH & FUSE BOX	600x350
D11	220V BATTERY No. 1 CHARGER 1 & BATTERY SUPERVISION	600x500
D12	220V BATTERY No. 1 CHARGER 2 & BATTERY SUPERVISION	600x500
D20	220V BATTERY No. 2 CHARGER CHANGEOVER SWITCH & FUSE BOX	600x350
D21	220V BATTERY No. 2 CHARGER 1 & BATTERY SUPERVISION	600x500
D22	220V BATTERY No. 2 CHARGER 2 & BATTERY SUPERVISION	600x500
D80	24/48V BATTERY: CHARGER 1 & BATTERY SUPERVISION	600x350
D81	24/48V BATTERY: CHARGER 1 & BATTERY SUPERVISION	600x500
D82	24/48V BATTERY: CHARGER 2 & BATTERY SUPERVISION	600x500
D70	48V TELECOMS CONNECTION/FUSE BOX	1600x400
D71	48V SMPS (TELECOMS)	600x600
D72	TELECOMS ISOLATION SWITCH	100x100
M1	OPMUX 1	800x800
M2	OPMUX 2	800x800
M3	OPMUX 3	800x800
M4	ODF	800x800
M5	IP SERVICES	800x800
M6	48V DC (TELECOMS) DISTRIBUTION BOARD	600x600
M7	MAIN DISTRIBUTION FRAME	800x800
M8	NCC RTU 1 (INCLU. GPS CLOCK)	800x800
M9	NCC RTU 2 (INCLU. GPS CLOCK)	800x800
M10	TELEMETERING 1	1200x800
M11	TELEMETERING 2	1200x800
M12	DCC RTU	600x400
M13	SYNCHRONISING PANEL	1200x800
M14	EVENT RECORDER/AAP 1	1600x800
M15	EVENT RECORDER/AAP 2	1600x800
M16	BATTERY SUPERVISION	800x800
M17	SIGNAL INTERPOSING	3200x800
M18	BUSBAR PROTECTION 1	1600x800
M19	BUSBAR PROTECTION 2	1600x800
M20	BUSBAR PROTECTION 3	1600x800
M21	CUSTOMER INTERFACE	4800x800
M22	F19 COUPLER PROTECTION	800x800
M23	F17 PROTECTION	800x800
M24	F17 PROTECTION	800x800
M25	F17 PROTECTION	800x800
M26	F17 PROTECTION	800x800
M27	F17 PROTECTION	800x800
M28	F17 PROTECTION	800x800
M29	F17 PROTECTION	800x800
M30	F17 PROTECTION	800x800
M31	F9A SECTIONALISER PROTECTION	800x800
M32	F9B SECTIONALISER PROTECTION	800x800
M33	F7 PROTECTION	800x800
M34	F7 PROTECTION	800x800
M35	F5 PROTECTION	800x800
M36	F5 PROTECTION	800x800
M37	F3 PROTECTION	800x800
M38	F3 PROTECTION	800x800
M39	F1 PROTECTION	800x800
M40	F1 PROTECTION	800x800
M41	F0A SECTIONALISER PROTECTION	800x800
M42	F0B SECTIONALISER PROTECTION	800x800
M43	F2 PROTECTION	800x800
M44	F2 PROTECTION	800x800
M45	F4 PROTECTION	800x800
M46	F4 PROTECTION	800x800
M47	F6 PROTECTION	800x800
M48	F6 PROTECTION	800x800
M49	F8 PROTECTION	800x800
M50	F8 PROTECTION	800x800
M51	F10 COUPLER PROTECTION	800x800
M52	REMOTE INTERROGATION/DISTURBANCE RECORDER	800x800
M53	INTRUDER ALARM PANEL	
M54	FIRE ALARM PANEL	
M55	ETIT	600x400
M56	EIRGRID ENERGY METERING	800x800
M57	TELEPHONE POINTS (2No.)	
M58	MIMIC	600x800

GENERAL:

NOTE 1:  
THIS DRAWING IS PRODUCED FOR INFORMATION PURPOSES ONLY. ALL DIMENSIONS, REFERENCES (EG. LIGHTNING MAST LOCATIONS ETC.) GIVEN ARE INDICATIVE AND SHOULD NOT BE USED AS PART OF A DETAILED DESIGN.

NOTE 2:  
THIS IS A CONCEPTUAL DESIGN. DETAILED DESIGN IS REQUIRED PENDING CONFIRMATION OF SPECIFIC EQUIPMENT SUPPLIER AND SITE DETAILS.

NOTE 3:  
BUILDING HAS BEEN SPECIFICALLY DESIGNED TO ACCOMMODATE 4 No. TRANSFORMER BAYS (CABLE CONNECTION) AND 8 No. FEEDER BAYS (CABLE CONNECTIONS).

NOTE 4:  
WHERE THERE IS MORE THAN ONE MINIMUM DISTANCE STATED FOR A SPECIFIC AREA THE LARGEST MINIMUM DISTANCE SHOULD BE ADHERED TO.

NOTE 5:  
FIRE AND ATEX ZONES NOT SHOWN, THIS SHOULD BE CONSIDERED DURING THE CUSTOMER DESIGN.

NOTE 6:  
CIVIL CALCULATIONS ARE TO BE CARRIED OUT AT THE DETAIL DESIGN STAGE AND TAKE INTO ACCOUNT SPECIFIC, EXISTING SITE GROUND CONDITIONS.

SWITCH GEAR

NOTE 7 (AS ILLUSTRATED ON DRAWING):  
THE SWITCHGEAR SHOWN ON THIS DRAWING IS INDICATIVE ONLY. DIMENSIONS OF THE OVERALL BUILDING SHALL BE DESIGNED TO SUIT MANUFACTURER SPECIFIC DIMENSIONS. ENVELOPE AROUND THE SWITCHGEAR SHALL BE WITH MANUFACTURER RECOMMENDATIONS FOR ON-GOING OPERATION, MAINTENANCE AND REPLACEMENT OF HV PLANT.

NOTE 8:  
REQUIREMENT FOR GIS OVERPRESSURE VENTS TO BE CONFIRMED BY GIS SUPPLIER.

NOTE 9:  
ALL OPES IN GIS ROOM FOR LV AND HV CABLES TO BE FIRE SEALED.

NOTE 10 (AS ILLUSTRATED ON DRAWING):  
MINIMUM CLEAR AREA ON BOTH SIDES OF THE GIS FOR THE HV TEST EQUIPMENT IS 3000mm.

NOTE 11:  
LV CABLE ROUTING FOR FUTURE SWITCHGEAR BAYS SHALL BE CONSIDERED AS PART OF THE DETAILED DESIGN. DIFFERENCES IN LENGTH BETWEEN THE RELAY ROOM AND THE SWITCHGEAR HALL MUST BE NOTED AT THE DETAIL DESIGN PHASE, WITH LV CABLING ROUTED ACCORDINGLY.

NOTE 12:  
SPECIFIC SWITCHROOM FLOOR REQUIREMENTS ARE TO SUIT THE MANUFACTURER'S SPECIFICATIONS AND ARE TO BE EVALUATED AT THE DETAIL DESIGN STAGE.

NOTE 13:  
BOTH OPTIONS OF LCC, INTEGRATED AND STANDALONE, HAVE BEEN SHOWN FOR INFORMATIONAL PURPOSES.

NOTE 14:  
HIGH FREQUENCY MESH IS TO BE LAID WITHIN THE GIS FLOOR AND SUIT SWITCHGEAR MANUFACTURER REQUIREMENTS. FOR FUTURE DETAILS ON EIRGRID EARTHING REQUIREMENTS, REFER TO EIRGRID'S FUNCTIONAL SPECIFICATION XDS-GFS-12-001.

NOTE 15:  
GIS ACCESS PLATFORMS SHOWN ARE INDICATIVE ONLY AND SHALL BE EVALUATED AT THE DETAIL DESIGN PHASE.

HALLWAY

NOTE 16 (AS ILLUSTRATED ON DRAWING):  
FIRE AND ALARM PANELS TO BE LOCATION IN THE VICINITY OF THE MAIN ENTRANCE.

CABLE PITS

NOTE 17:  
THE MAXIMUM LENGTH OF A CABLE THAT CAN BE PUSHED INTO THE CABLE ROOM IS 100m ROUTE LENGTH.

NOTE 18 (AS ILLUSTRATED ON DRAWING):  
BUILDING DESIGNER AND CABLE DESIGNER SHALL BE CO-ORDINATE WORKS TO ENSURE THERE ARE NO OBSTRUCTIONS LOCATED 2m DIRECTLY IN FRONT OF THE CABLE ROOM.

NOTE 19 (AS ILLUSTRATED ON DRAWING):  
ADEQUATE AREA TO BE PROVIDED IN THE VICINITY OF THE GIS BUILDING TO ALLOW SPACE FOR SETTING UP THE EQUIPMENT NEEDED FOR CABLE PULLING OPERATIONS. THIS AREA IS APPROX. 12m x 12m FOR EACH CABLE CIRCUIT, CABLE DESIGNER TO CONSIDER.

NOTE 20:  
AN OPENING MUST BE PROVIDED FOR EACH CIRCUIT TO ALLOW FOR SUITABLE CABLE PULLING DUCTS.

NOTE 21:  
CABLE SUPPORT STEELWORK TO BE PROVIDED BY THE CONTRACTOR. WALL TO BE CAPABLE OF SUPPORTING HV CABLES, RING CT'S ETC.

NOTE 22 (AS ILLUSTRATED ON DRAWING):  
AN OPENING SHALL BE PROVIDED UNDER THE

STAIRS FOR CABLE PULLING.

NOTE 23:  
SUITABLE ANCHOR POINTS SHALL BE INSTALLED FOR CABLE PULLING.

NOTE 24 (AS ILLUSTRATED ON DRAWING):  
INDICATIVE MODULAR/RELOCATABLE WALKWAY BRIDGES HAVE BEEN SHOWN WITHIN THE CABLE PIT AND ARE INTENDED TO PROVIDE AN UNIMPEDED ROUTE OF ESCAPE FROM THE PIT IN THE EVENT OF AN EMERGENCY. BRIDGES ARE TO BE CONSTRUCTED WITH A NON-METALLIC MATERIAL. I.E. GLASS REINFORCED PLASTIC.

NOTE 25:  
CABLE PIT ENTRY DUCTS LOCATIONS ARE INDICATIVE ONLY. DUCTING SHALL BE FACILITATED TO SUIT THE ULTIMATE DEVELOPMENT OF THE STATION TO REDUCE THE POSSIBILITY OF WATER INGRESS.

NOTE 26:  
RISK ASSESSMENT TO BE CARRIED OUT AT DETAIL DESIGN STAGE TO EVALUATE THE REQUIREMENT FOR FORCED VENTILATION WITHIN CABLE PIT.

NOTE 27:  
LINK BOXES LOCATED IN THE CABLE BASEMENTS SHALL BE READILY ACCESSIBLE FOR OPERATIONS STAFF FOR THE MAINTENANCE PURPOSES WITH SAFETY SIGNAGE AS OUTLINED IN THE EIRGRID CABLE SPECIFICATIONS.

NOTE 28:  
TELECOMMUNICATIONS DUCTS SHALL BE ROUTED DIRECTLY TO THE RELAY ROOM AS PER ESB TELECOMS REQUIREMENTS.

BATTERY ROOM:

NOTE 29 (AS ILLUSTRATED ON DRAWING):  
MINIMUM CLEAR DISTANCE BETWEEN 220V BATTERY STANDS AND WALLS IS 800mm.

NOTE 30:  
BATTERIES SHOULD BE LOCATED AWAY FROM THE WALL TO ENSURE ACCESS TO ALL THE BATTERY CELLS FOR MAINTENANCE. BATTERIES SHOULD NOT BE LOCATED IN FRONT OF AIR VENTS.

NOTE 31 (AS ILLUSTRATED ON DRAWING):  
SCREENED VENTS (2 HIGH LEVEL AND 2 LOW LEVEL) ARE TO BE INSTALLED IN THE BATTERY ROOM AS PER IEC 62485-2 ON ADJACENT EXTERNAL WALL. MINIMUM VENT DIMENSIONS: 900x225mm.

NOTE 32 (AS ILLUSTRATED ON DRAWING):  
ACCESS DOOR TO STAIRCORE 2 FROM HOIST AREA, AND ADDITIONAL DOUBLE DOOR EXIT IN BATTERY ROOM TO BE SIZED APPROPRIATELY. SIZE REQUIREMENT TBC IN LINE WITH FIRE REGULATIONS.

NOTE 33:  
BATTERY ROOM FLOOR IS TO BE FITTED WITH NON-SLIP, ACID RESISTANT VINYL AS PER THE REQUIREMENTS OF XDS-GFS-13-001-R2.

NOTE 34:  
DETAIL DESIGN IS TO CARRY OUT APPROPRIATE RISK ASSESSMENT & VENTILATION CALCULATIONS TO EVALUATE BATTERY ROOM VENT REQUIREMENTS.

GENERATOR ROOM

NOTE 35 (AS ILLUSTRATED ON DRAWING):  
MINIMUM DIESEL GENERATOR LOUVRE DIMENSIONS 1200x1200mm.

HOIST AREA

NOTE 36 (AS ILLUSTRATED ON DRAWING):  
EQUIPMENT ACCESS DOOR TO SIZED SUCH THAT A STANDARD ESB TRUCK CAN BE REVERSED IN HOIST AREA (MIN 4000mm WIDTH).

NOTE 37 (AS ILLUSTRATED ON DRAWING):  
ROLLER SHUTTER DOOR EXTENDS TO CEILING LEVEL OF THE GROUND FLOOR OF THE GIS BUILDING.

NOTE 38 (AS ILLUSTRATED ON DRAWING):  
ROLLER SHUTTER DOOR TO BE INSTALLED BETWEEN HOIST AREA AND THE CABLE PIT AND IS INTENDED TO PREVENT VERTICAL FIRE TRAVEL BETWEEN THE FIRST AND SECOND FLOORS OF THE BUILDING, INLINE WITH FIRE REGULATIONS

RELAY ROOM

NOTE 39 (AS ILLUSTRATED ON DRAWING):  
RELAY ROOM MUST BE SIZED APPROPRIATELY TO ALLOW FOR ULTIMATE DEVELOPMENT OF STATION.

NOTE 40 (AS ILLUSTRATED ON DRAWING):  
SPACE SHOULD BE CONSIDERED FOR ADDITIONAL TELECOMS AND PROTECTION PANELS.

NOTE 41:  
INDICATIVE CABLE ACCESS SHOWN.

NOTE 42:  
A TELECOMS EARTH BAR SHALL BE INSTALLED IN CLOSE PROXIMITY TO THE DCC RTU.

NOTE 43:  
NO ELECTRICAL EQUIPMENT (INCL. BATTERIES) SHALL BE INSTALLED DIRECTLY IN FRONT OF VENTS.

NOTE 44 (AS ILLUSTRATED ON DRAWING):  
RELAY ROOM FLOOR CONSTRUCTION TO SUIT ROOM REQUIREMENTS,

ROOF ACCESS

NOTE 45:  
ROOF ACCESS IS TO BE EVALUATED AT THE DETAIL DESIGN STAGE BY CONDUCTING A RISK ASSESSMENT.



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PROJECT

Clonberne Wind Farm  
220kV Grid Connection

CLIENT

Clonberne Windfarm Limited

CONSULTANTS

NOTES: -

LEGEND: -

ISSUE/REVISION

P1	04.06.24	Issued for Planning
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PROJECT NUMBER

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SHEET TITLE


220kV GIS Building  
General Arrangement  
Section A-A

SHEET NUMBER

05990-DR-119


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Project Management Initials: Designer: LG Checked: AC Approved: RG

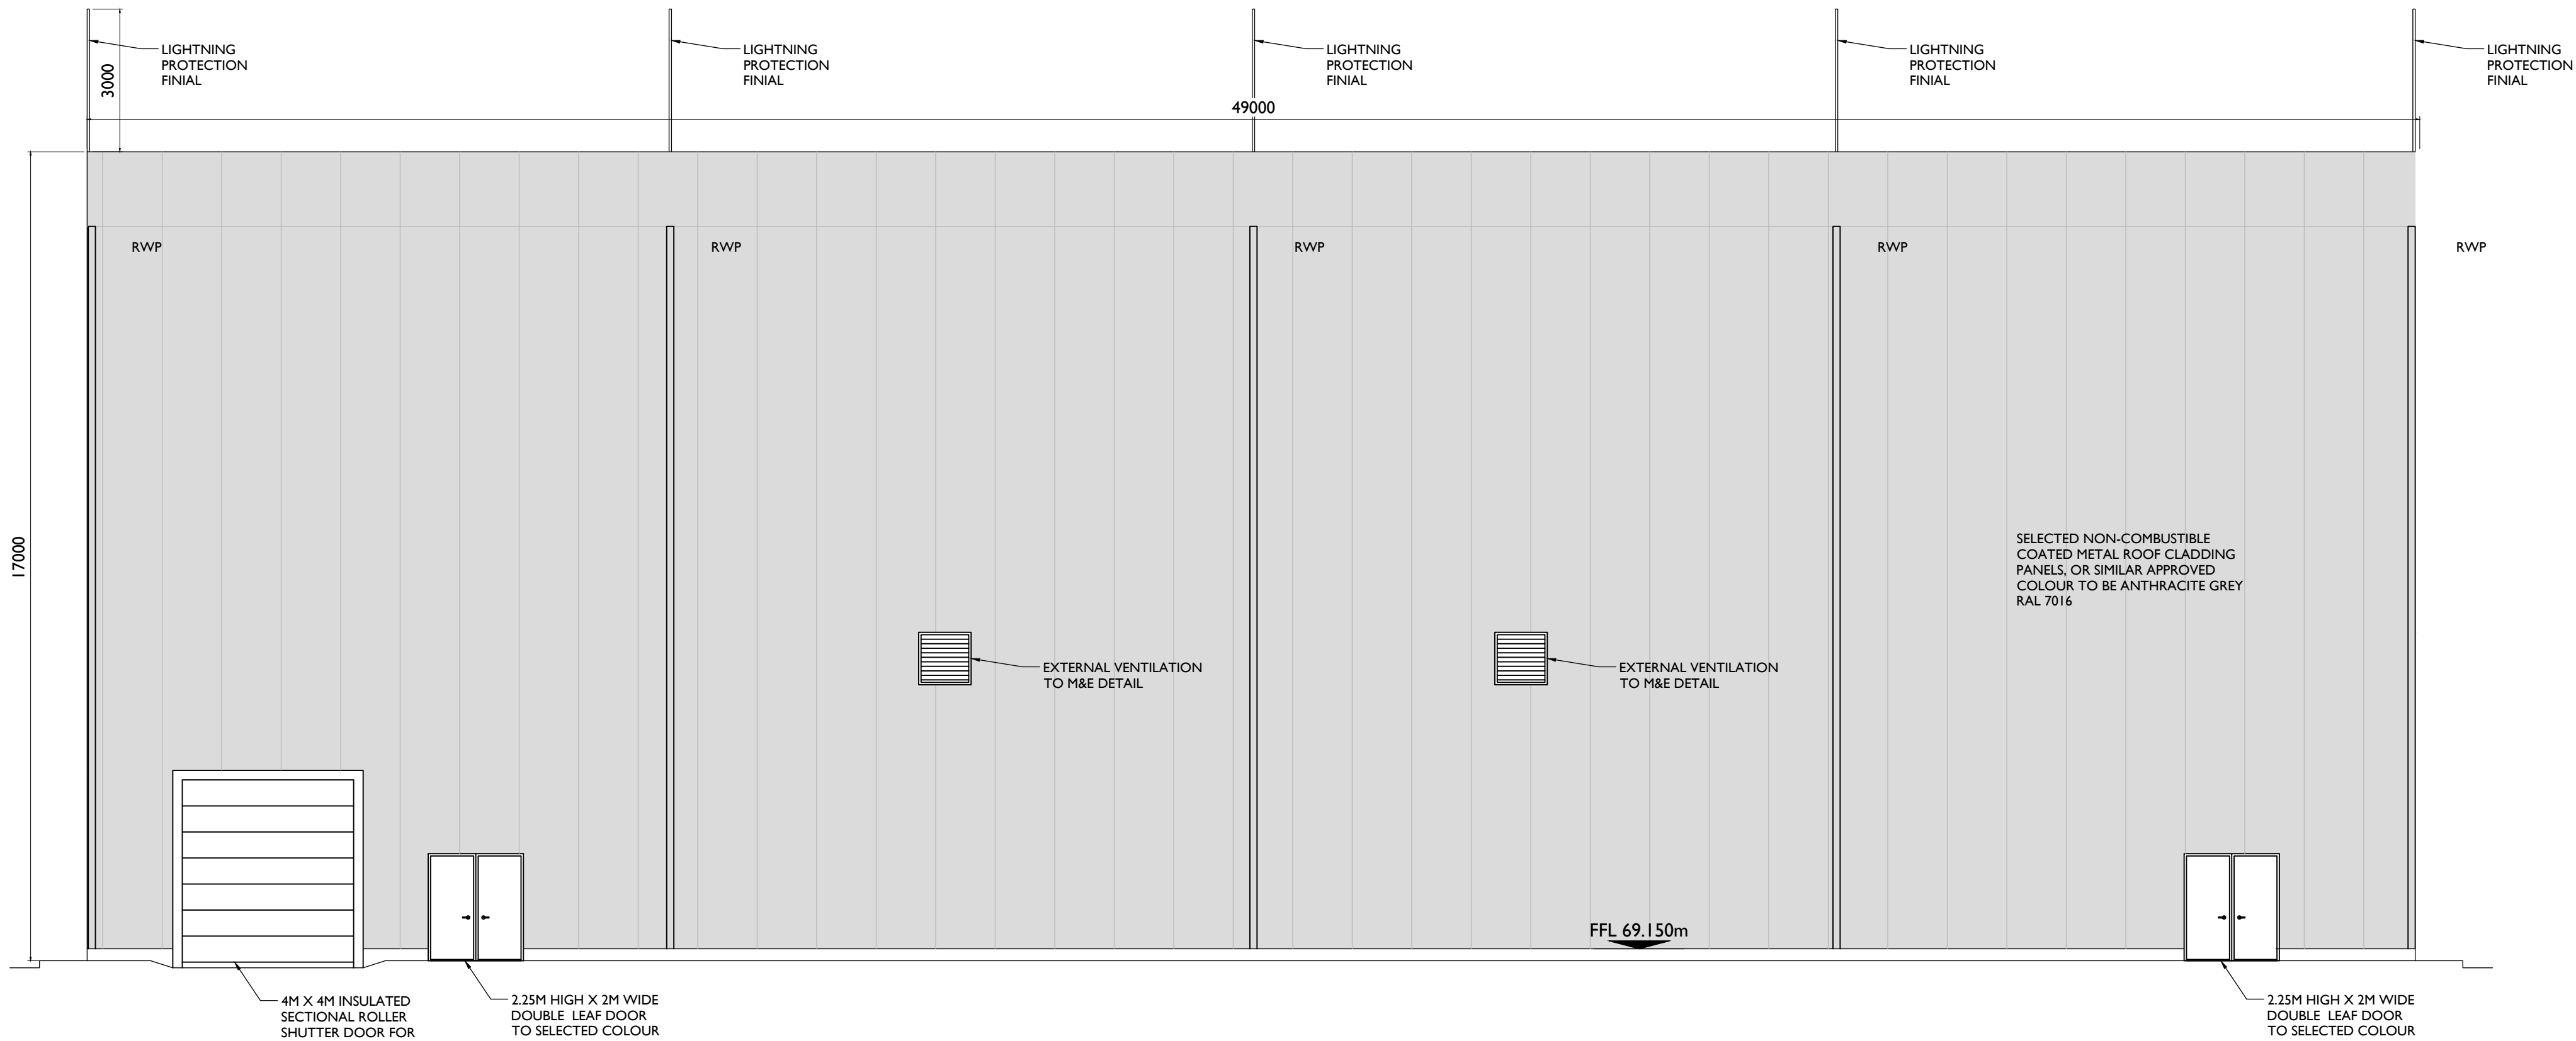

Elevation A

Scale: - 1:100

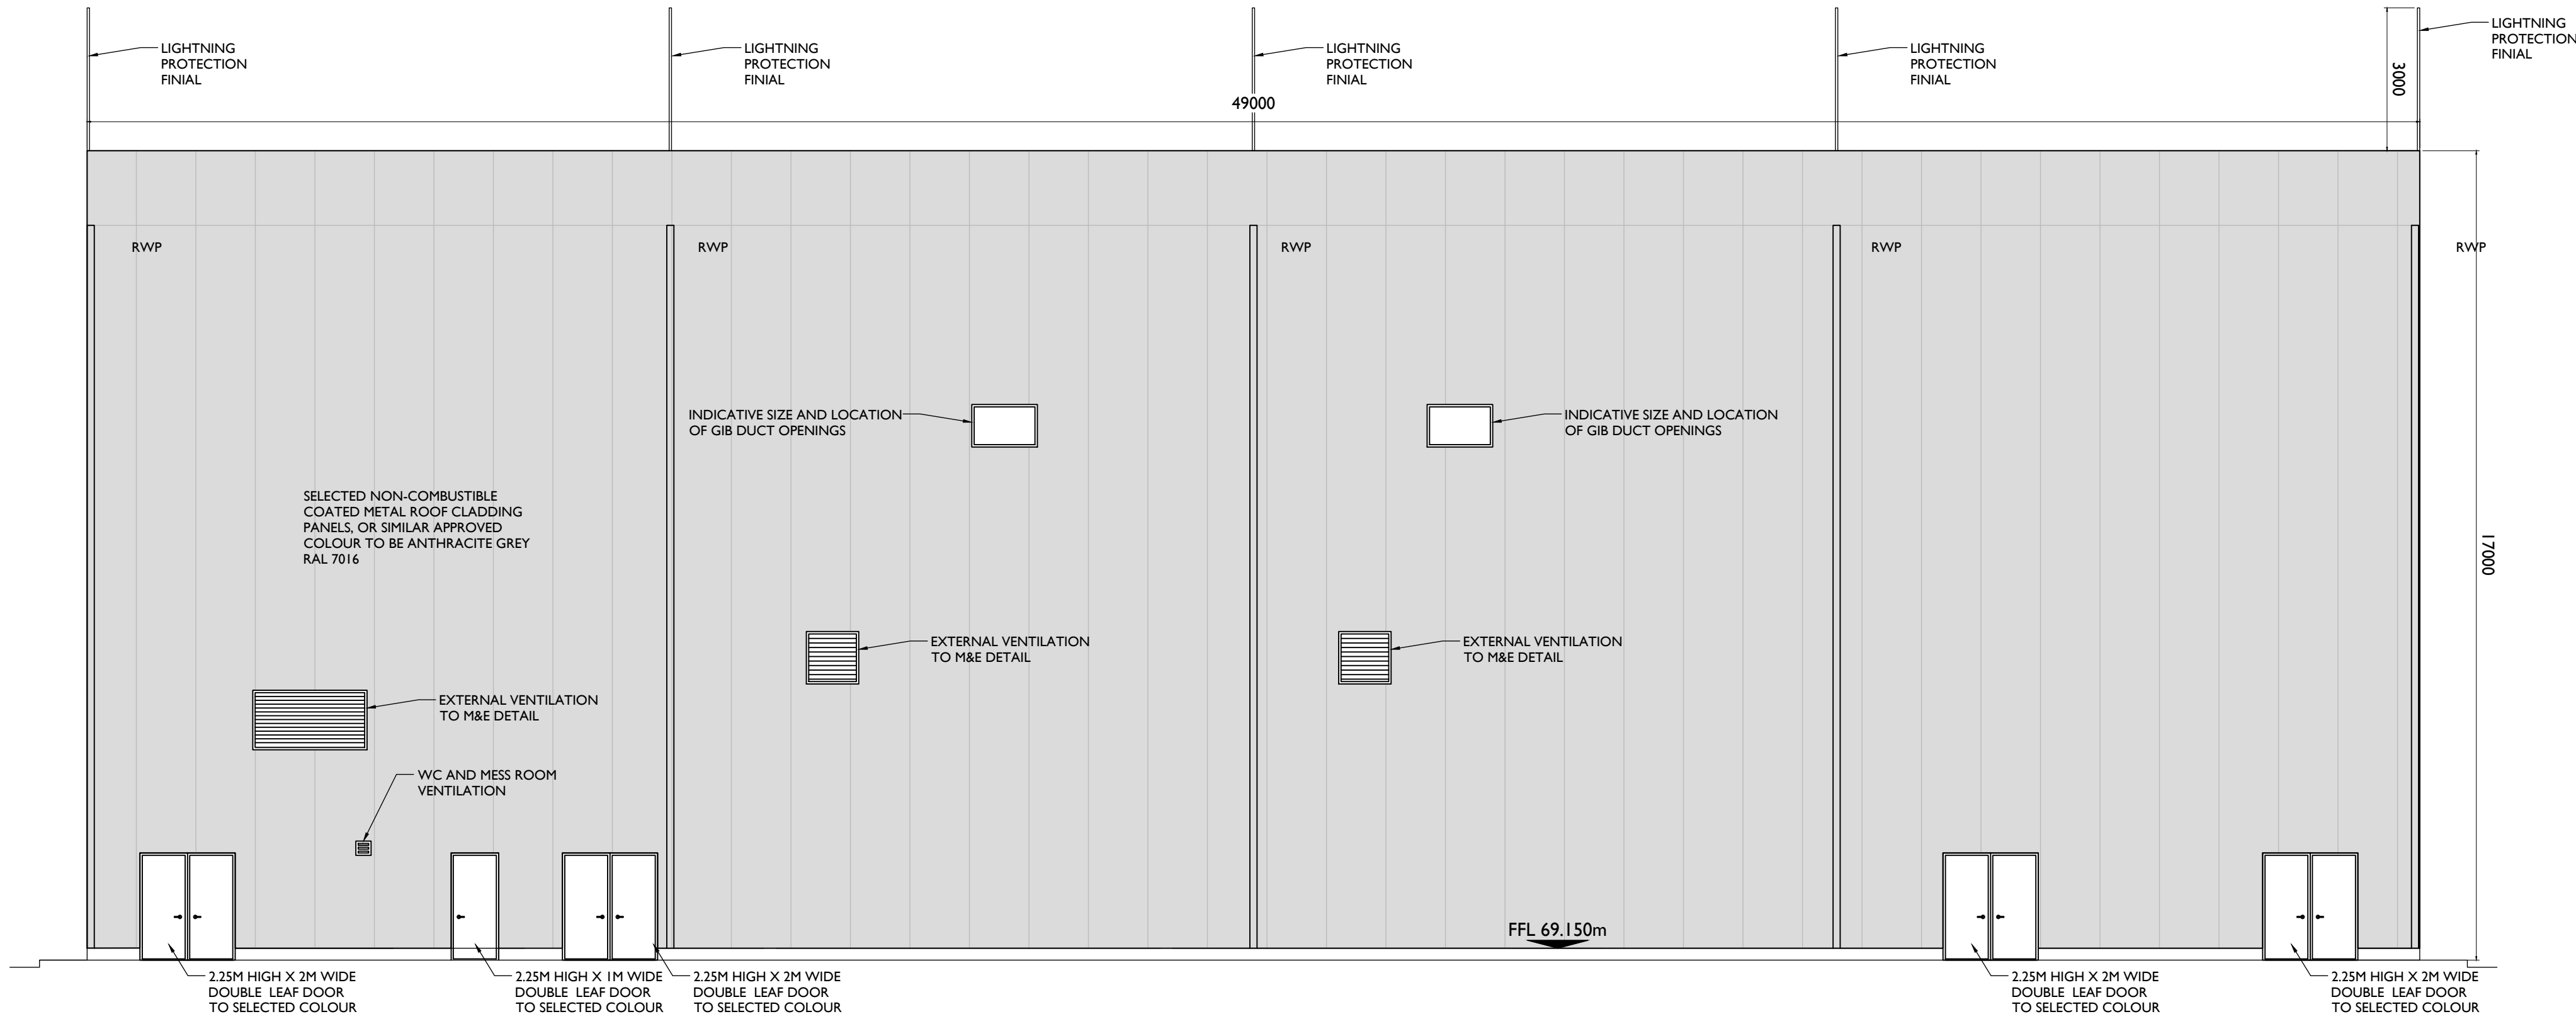

Elevation B

Scale: - 1:100



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PROJECT NUMBER

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SHEET TITLE

220kv GIS Building  
Elevations Sheet 1 of 2


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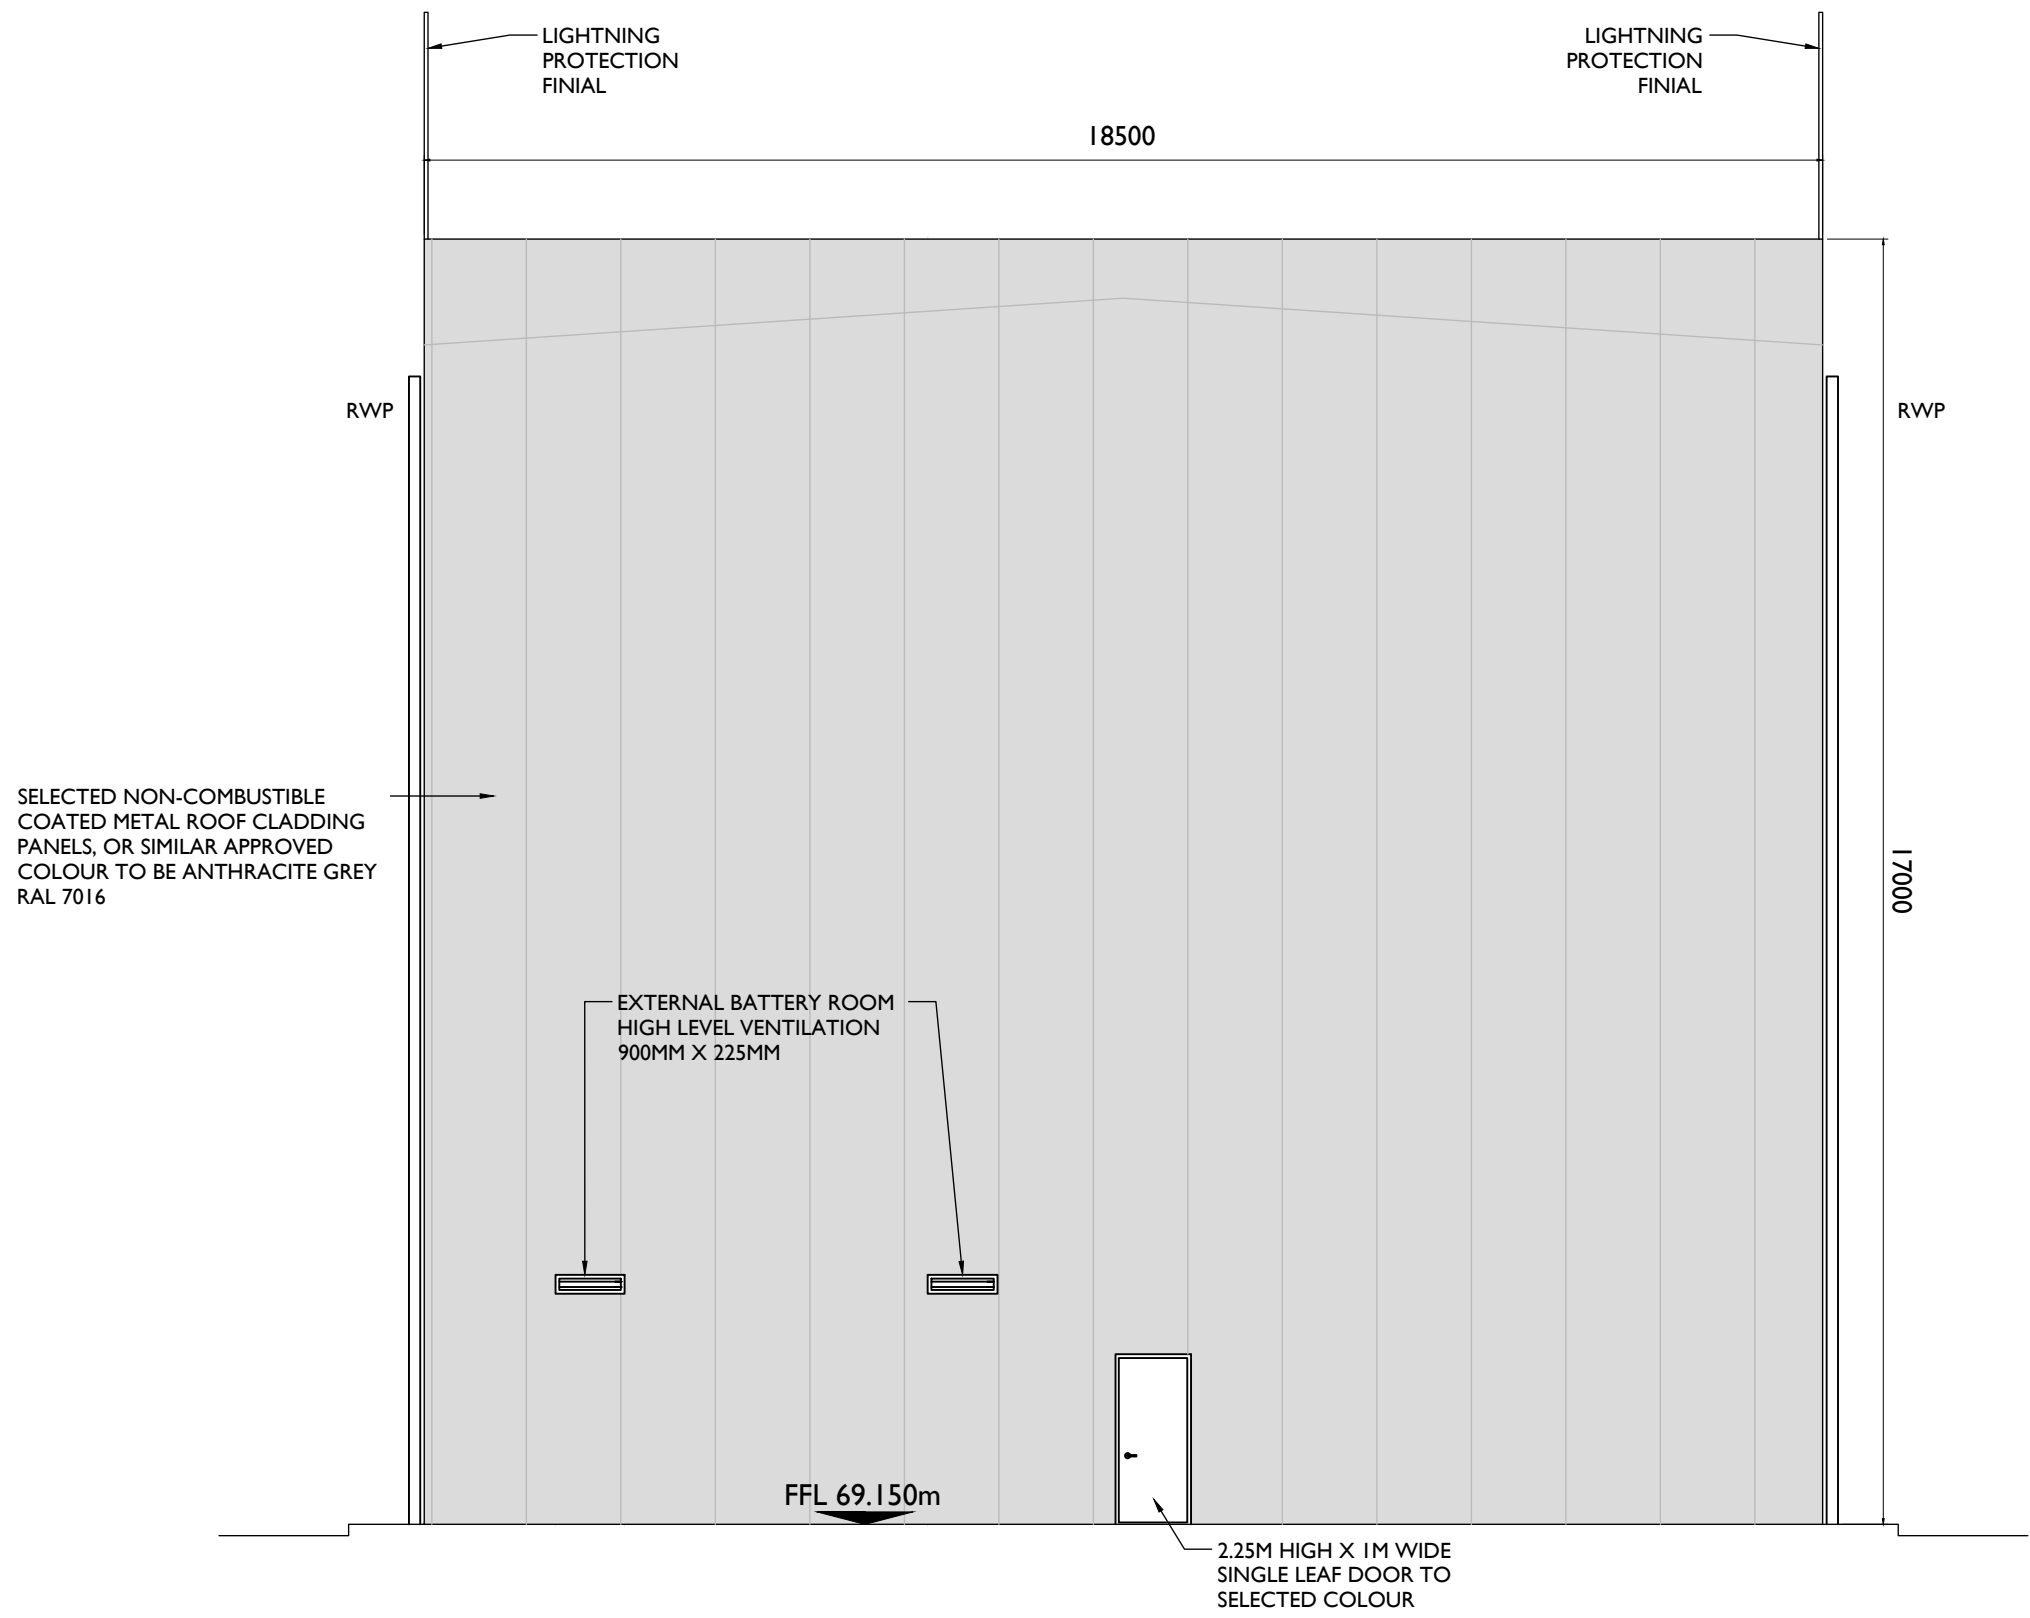


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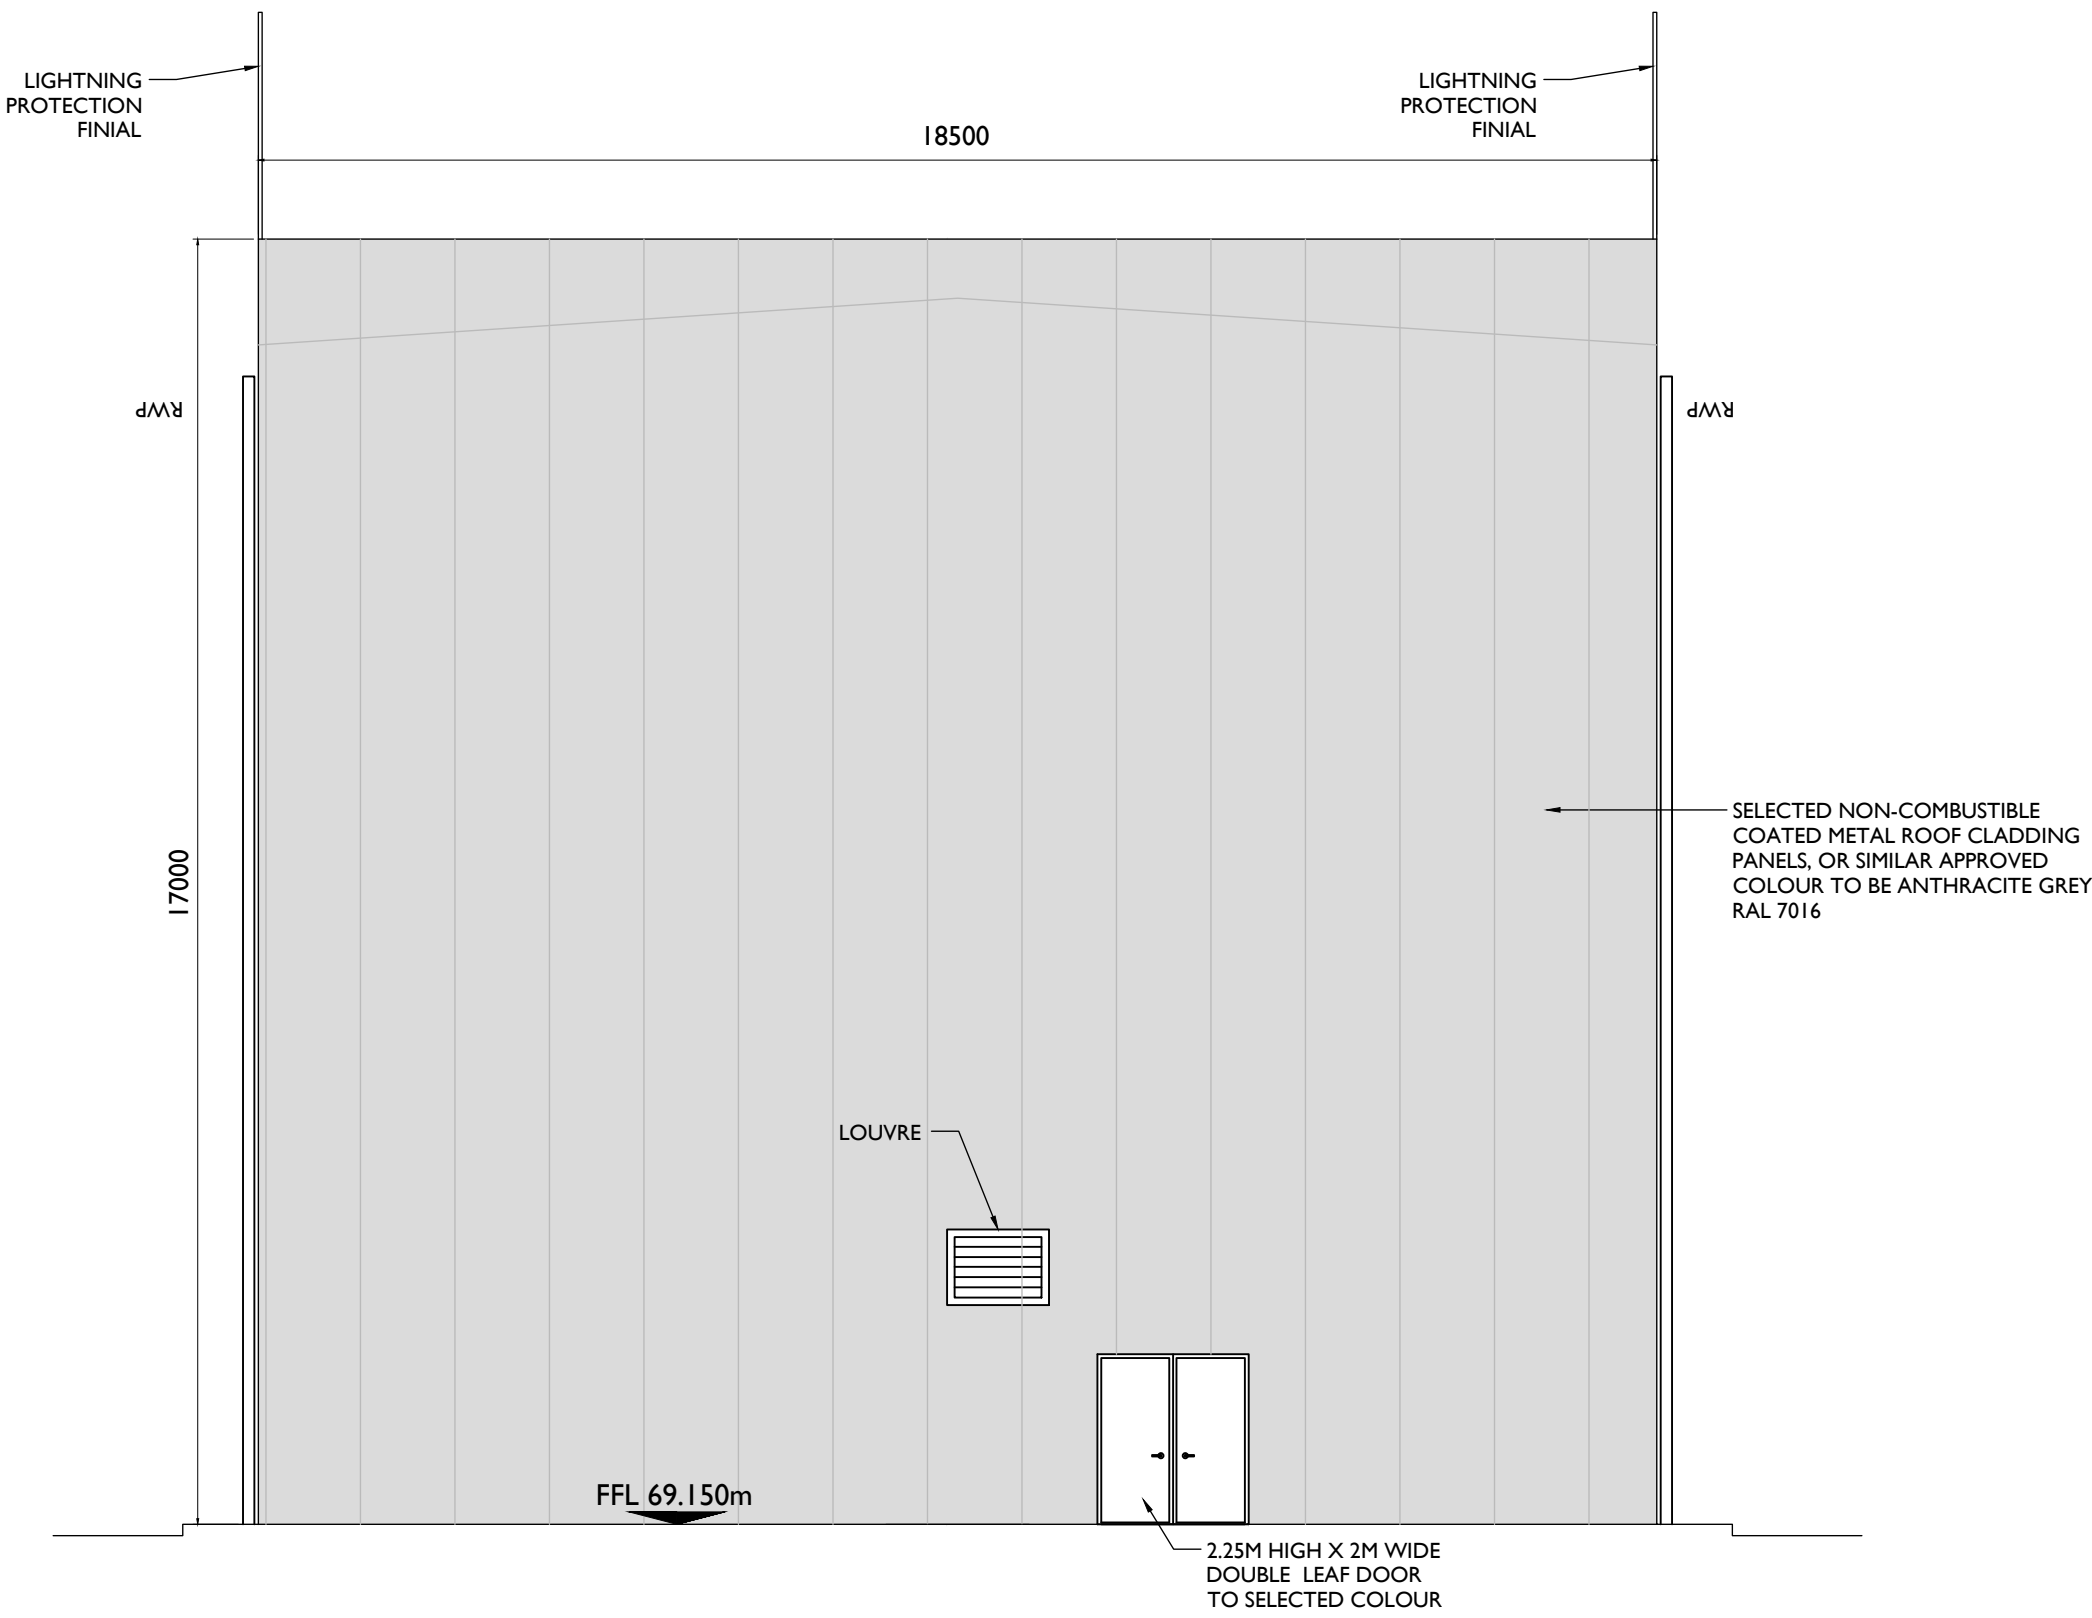
Project Management Initials: Designer: LG Checked: AC Approved: RG



**Roof Plan**  
Scale: - 1:100

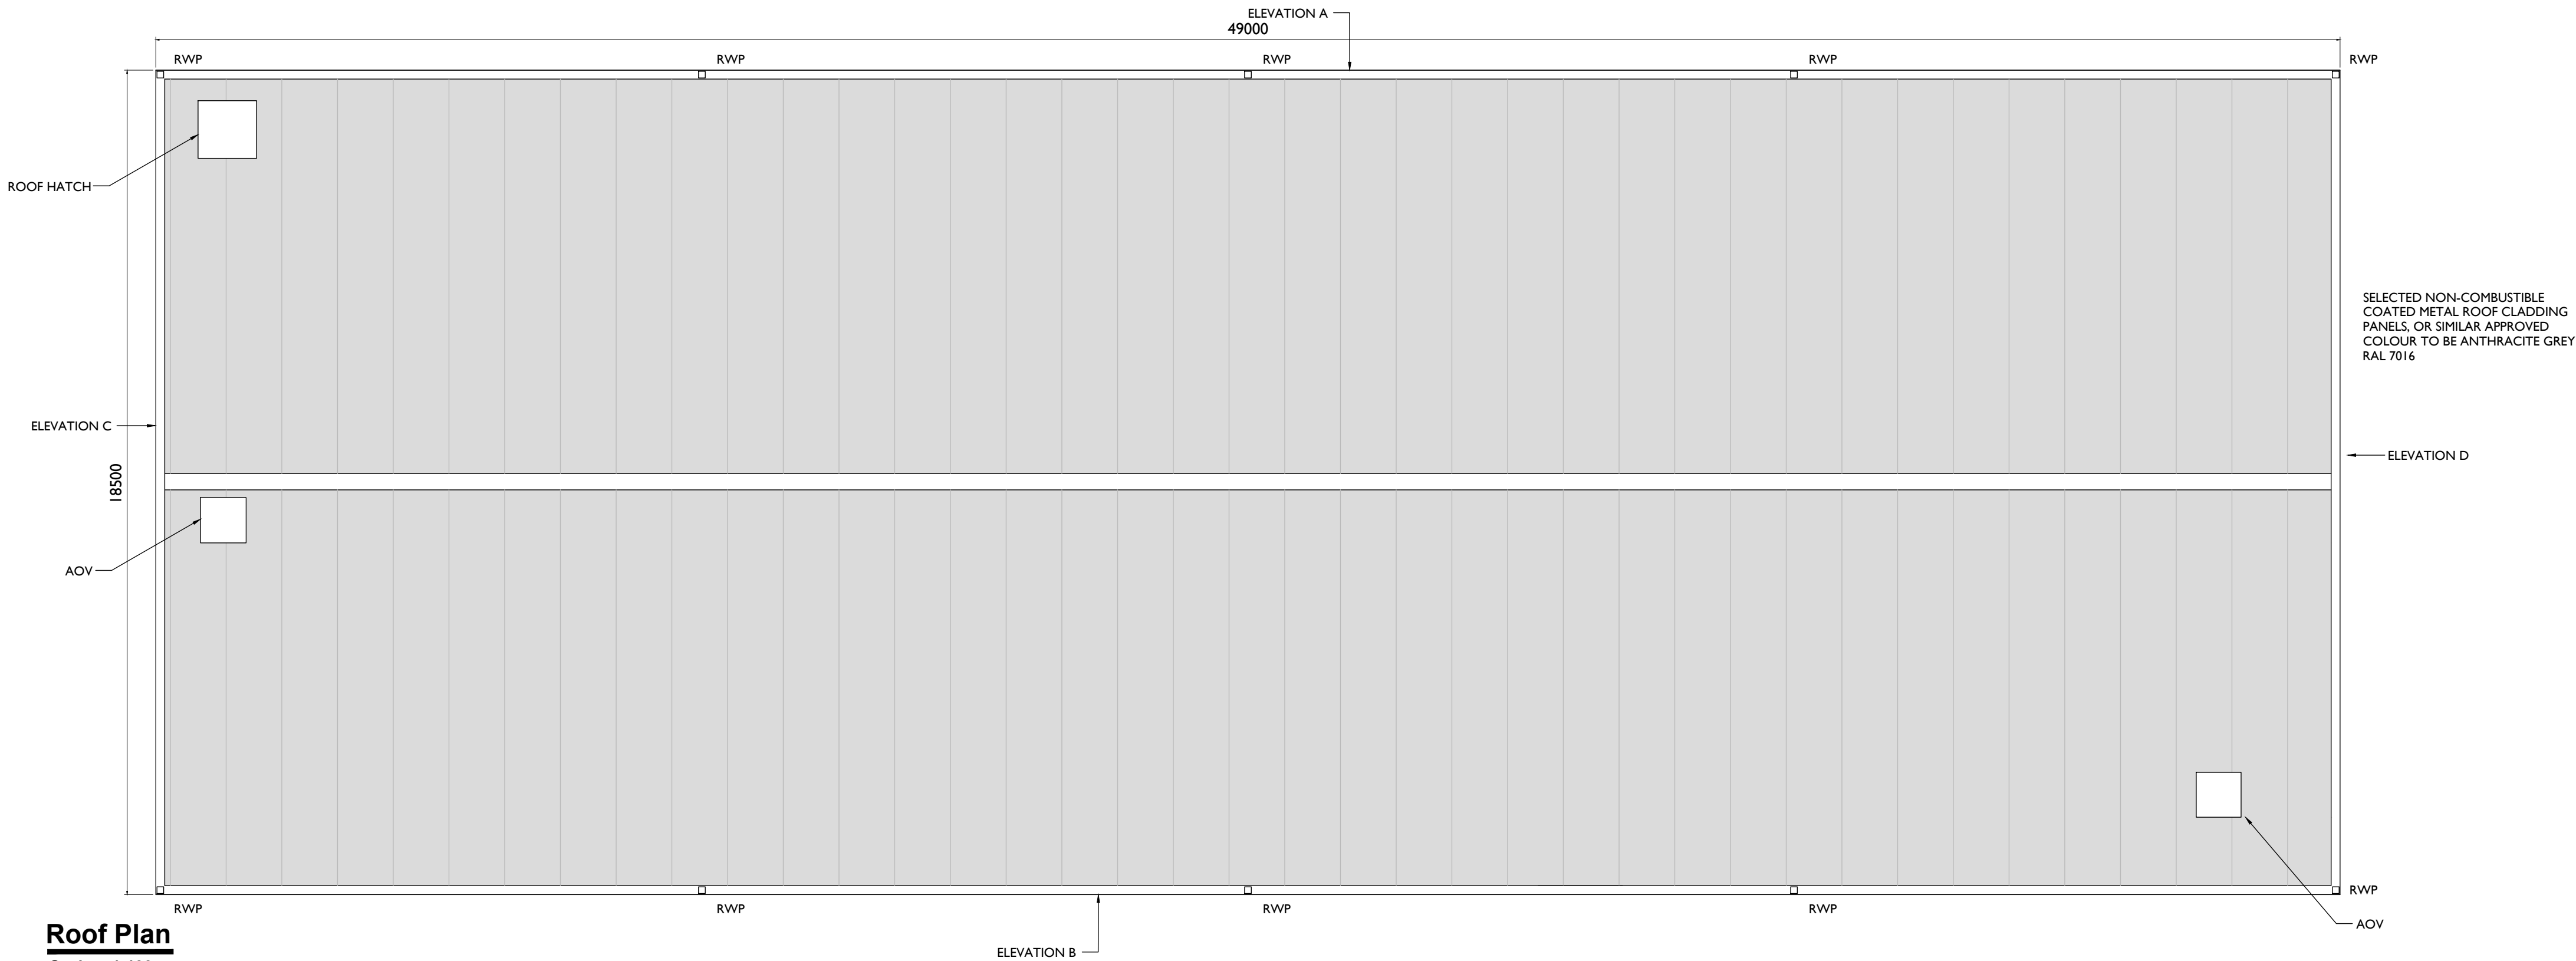

**Elevation C**  
Scale: - 1:100



**Elevation D**  
Scale: - 1:100



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PROJECT

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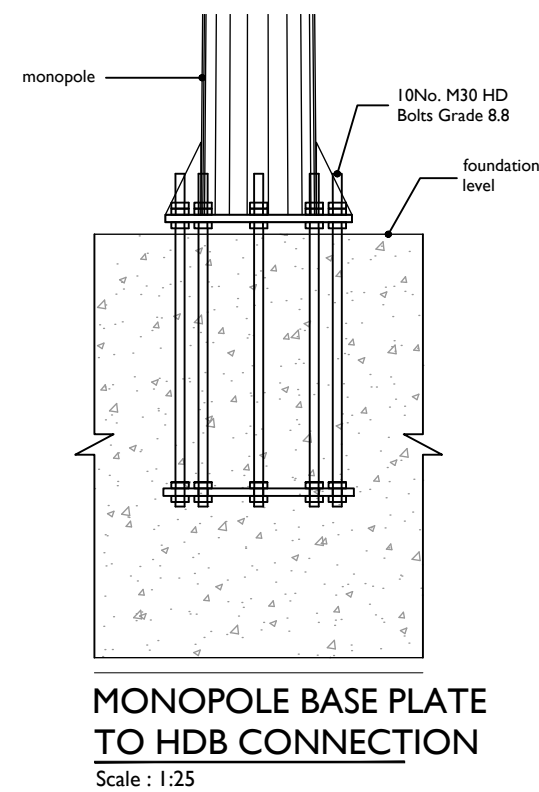
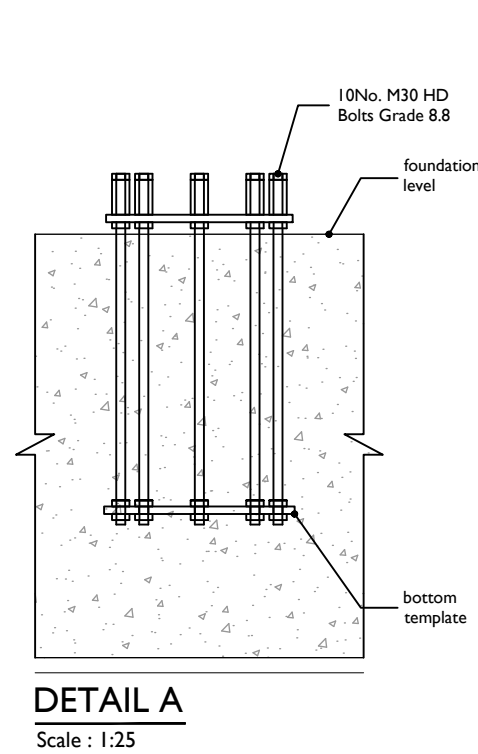
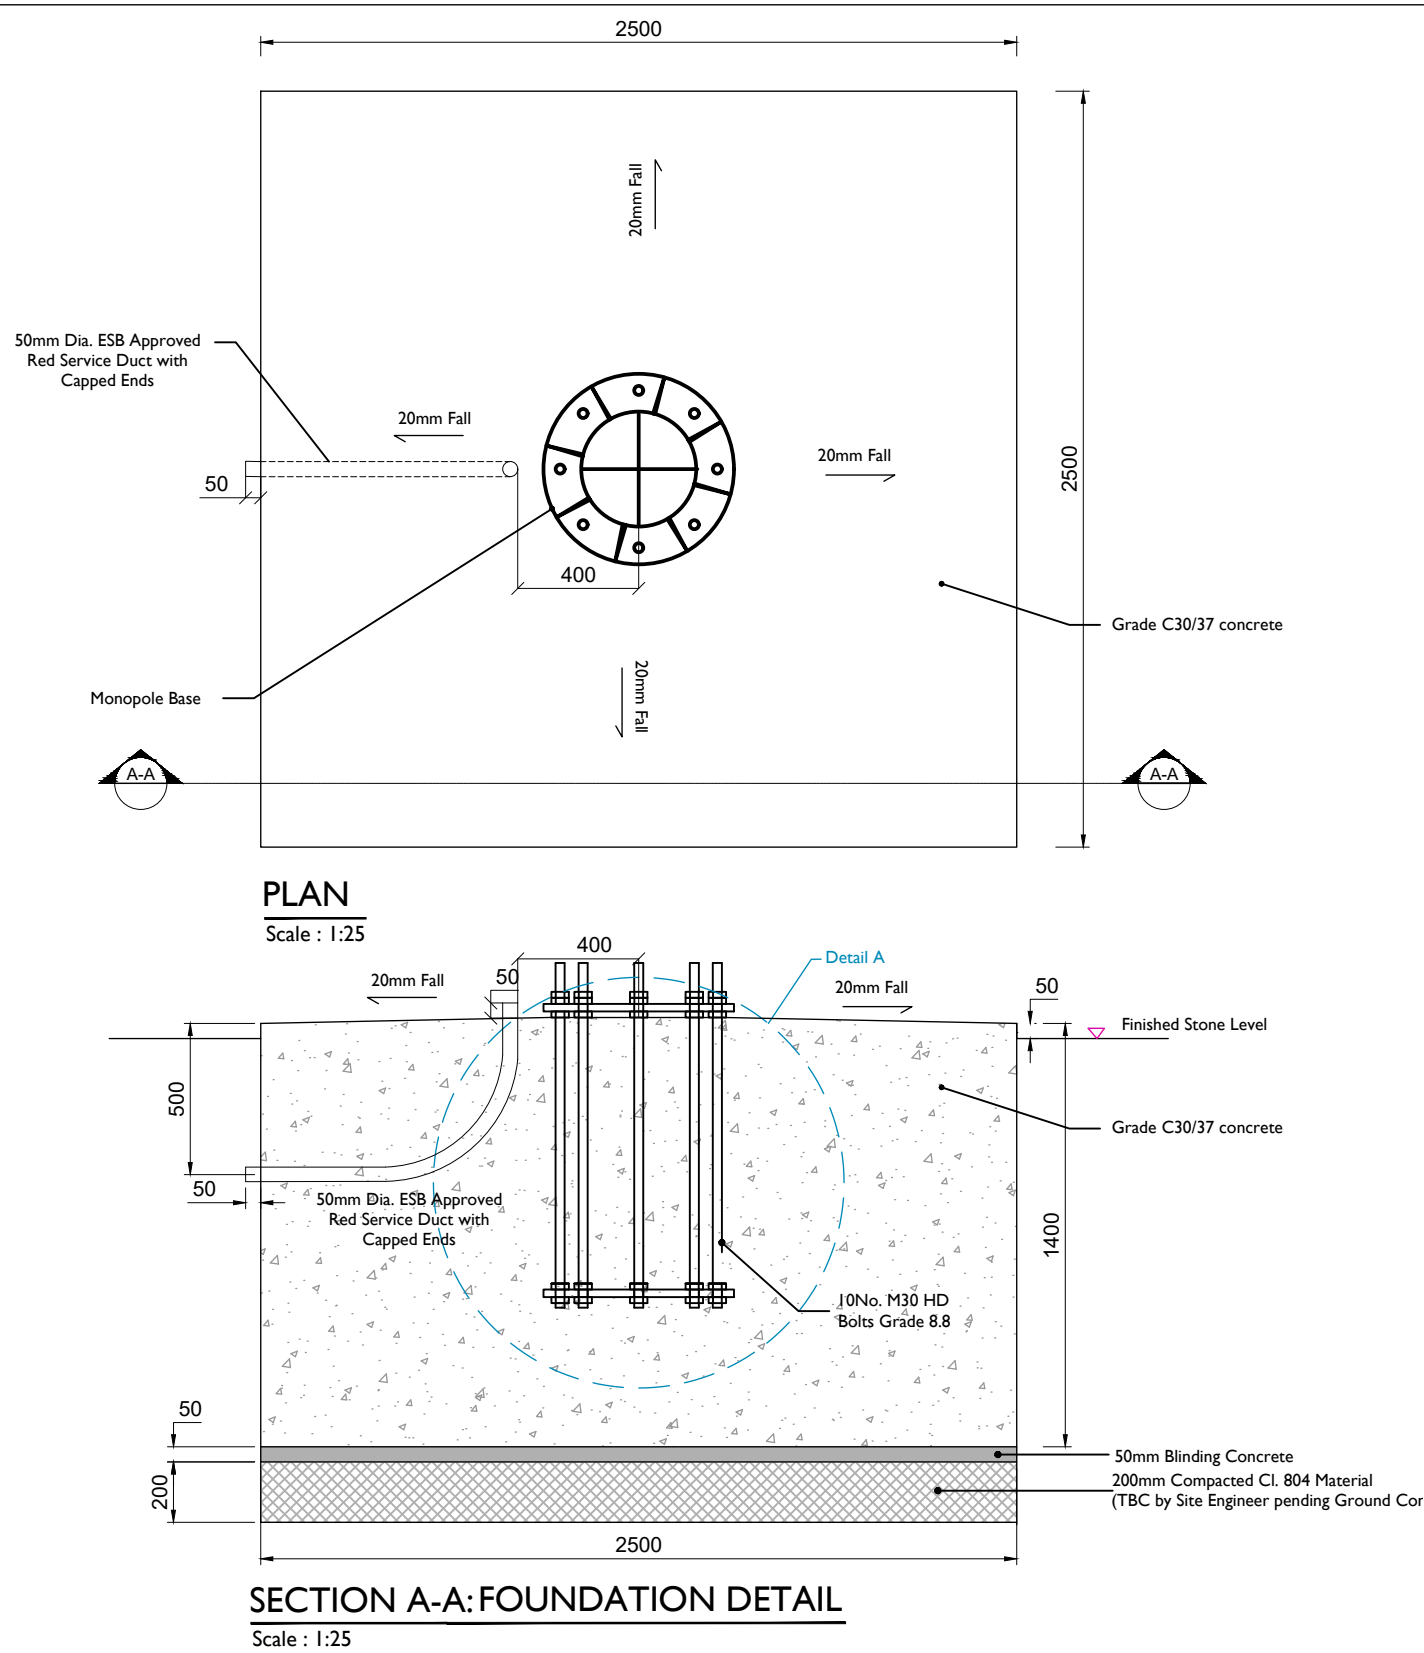
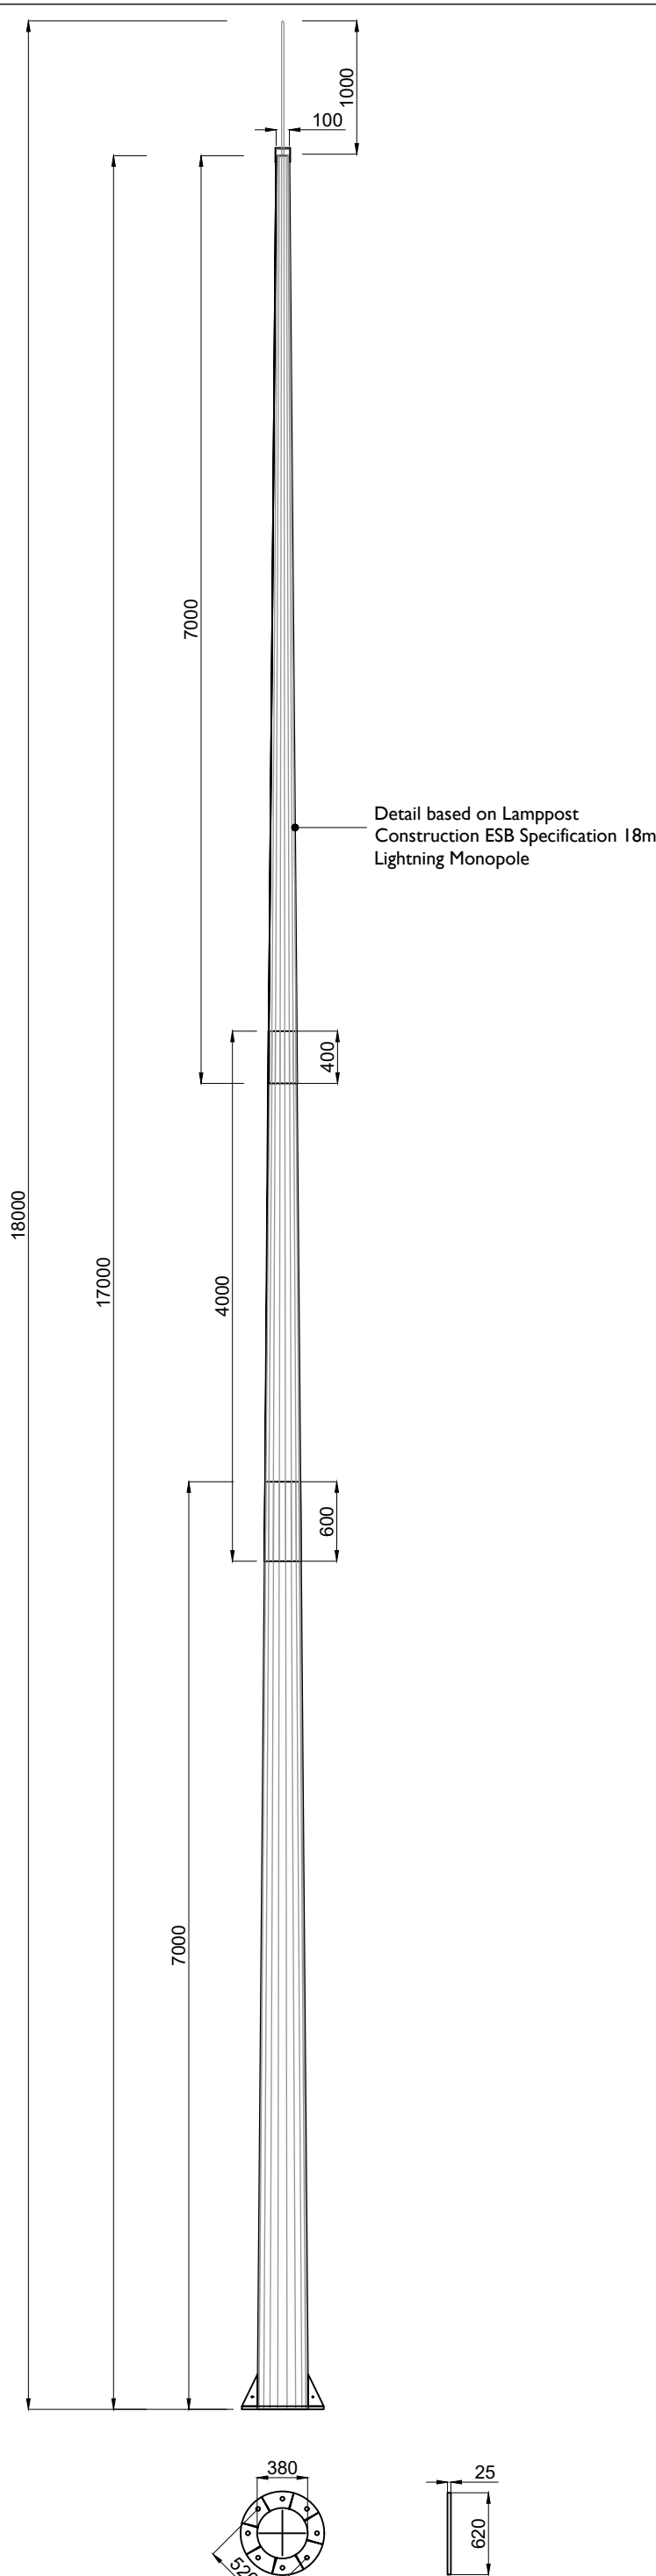
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SHEET TITLE

220kV GIS Building  
Roof Plan & Elevations Sheet 2 of 2

SHEET NUMBER

05990-DR-121



**GENERAL NOTES:**

- ALL drawings to be read in conjunction with the Specification and all Engineers and Architects Drawings.
- All concrete to be in accordance with I.S. EN 206-1:2002 with the Mix Designs shown in Table I
- Concrete finishes to be in accordance with Table 6.1 of the ESB Specification CS17-SO1-005.
- ALL Reinforcement shall be in accordance with BS4449 and scheduled in accordance with BS.8666. 300mm Laps for A142 Mesh 600mm Min Laps for A393 Mesh.
- Refer always to relevant Earth Grid drawing prior to excavations & concrete pours.
- Geometrical tolerances to be in accordance with Table 6.2 of ESB Specification CS17-SO1-005

**FOUNDATION NOTES:**

- Ground to have a minimum Bearing Capacity of 100 kN/m<sup>2</sup>.
- Formation level and Foundations to be inspected and approved by the Engineer prior to any Concrete being poured.
- All Foundations are to be blinded immediately after excavation with 50mm of C16/20 Concrete Blinding.
- Refer always to the relevant Earth Work Drawings prior to Excavations & Concrete pours.

**PROJECT**

Clonberne Wind Farm  
220kV Grid Connection

**CLIENT**

Clonberne Windfarm Limited

**CONSULTANTS**

**NOTES: -**

- This drawing is to be read in conjunction with relevant engineering drawings, specifications and reports
- Dimensions are in millimeters, unless noted otherwise
- Drawings are not to be scaled use figured dimensions only

**LEGEND: -**

**ISSUE/REVISION**

ISSUE/REVISION		
P1	04.06.24	Issued for Planning
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**SHEET TITLE**

Lightning Monopole Details - 18m Mast


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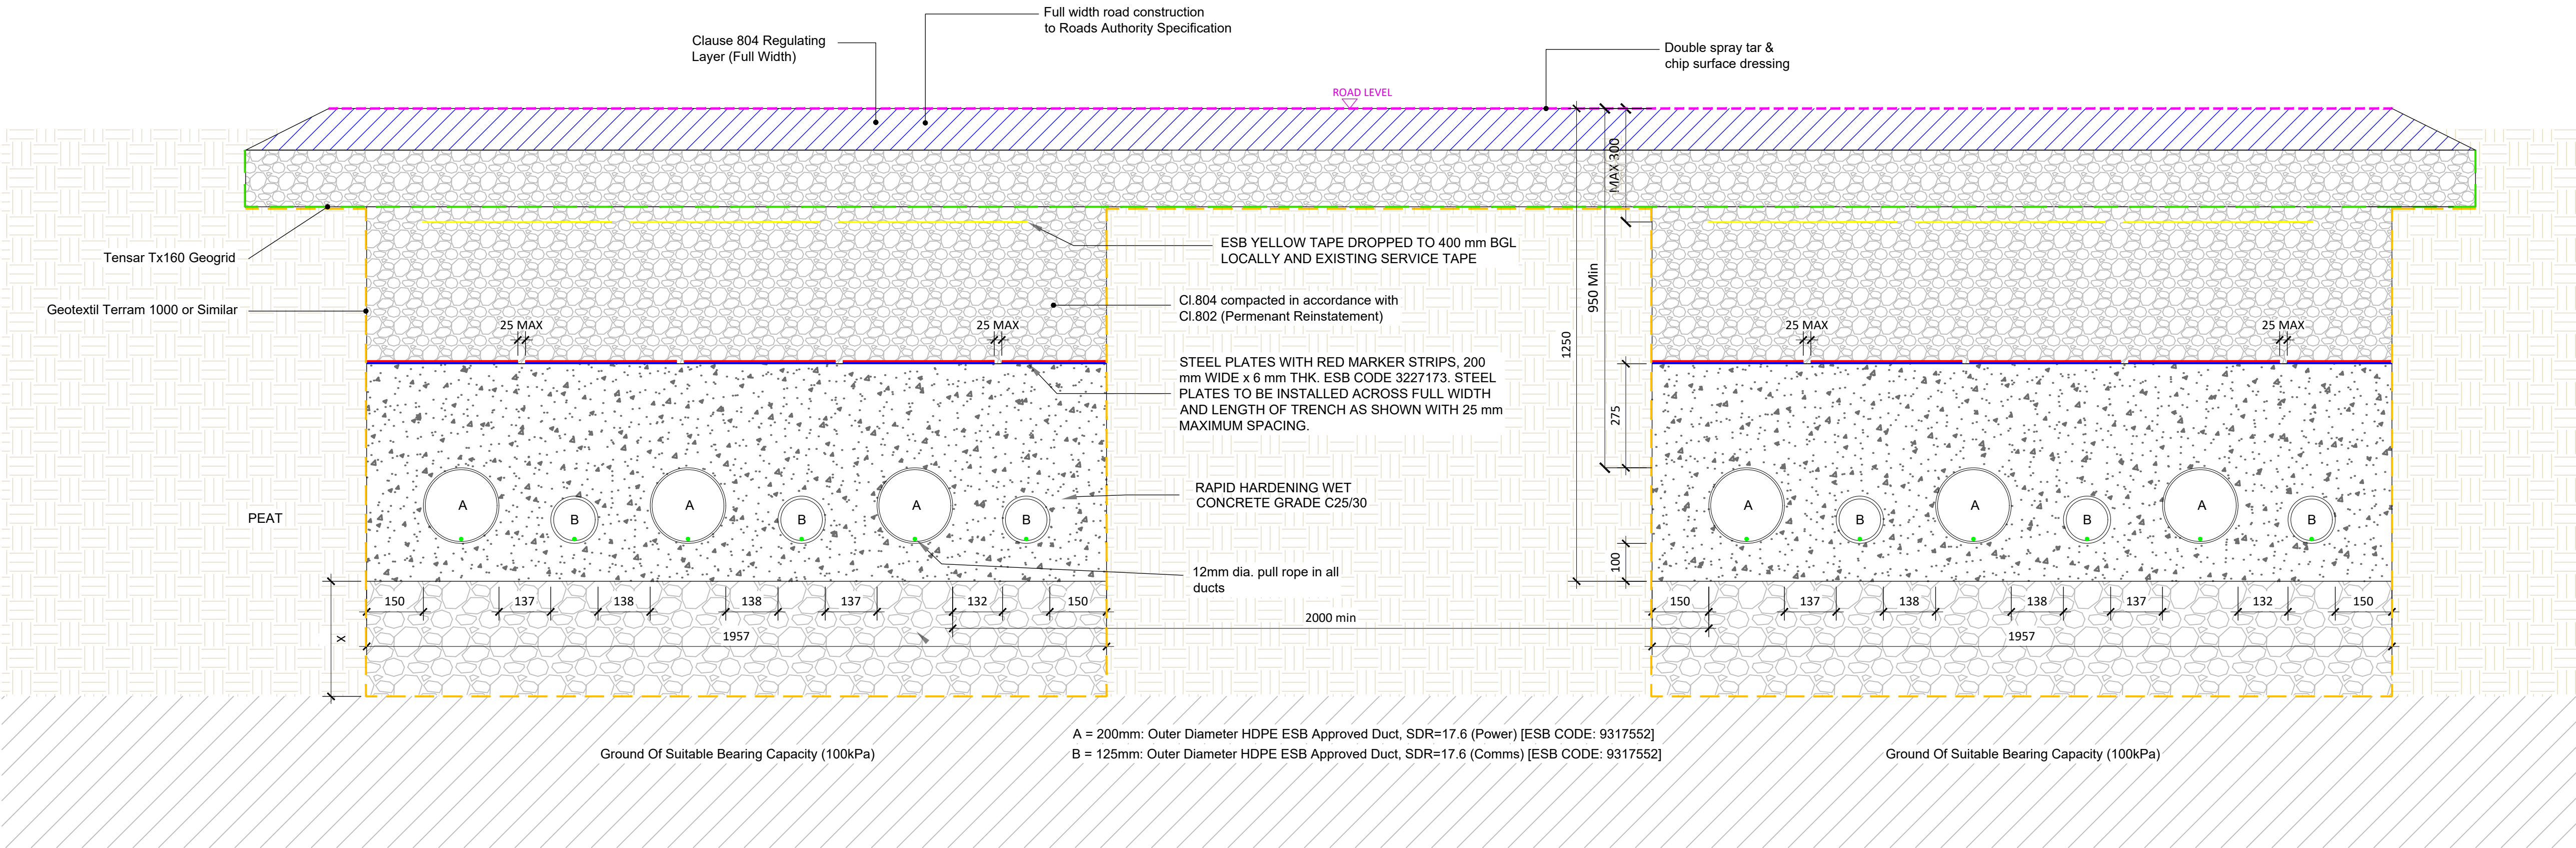
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Project Management Initials: Designer: JF Checked: AC Approved: RG



Ducting Through Road Cross Section

Scale : 1:50

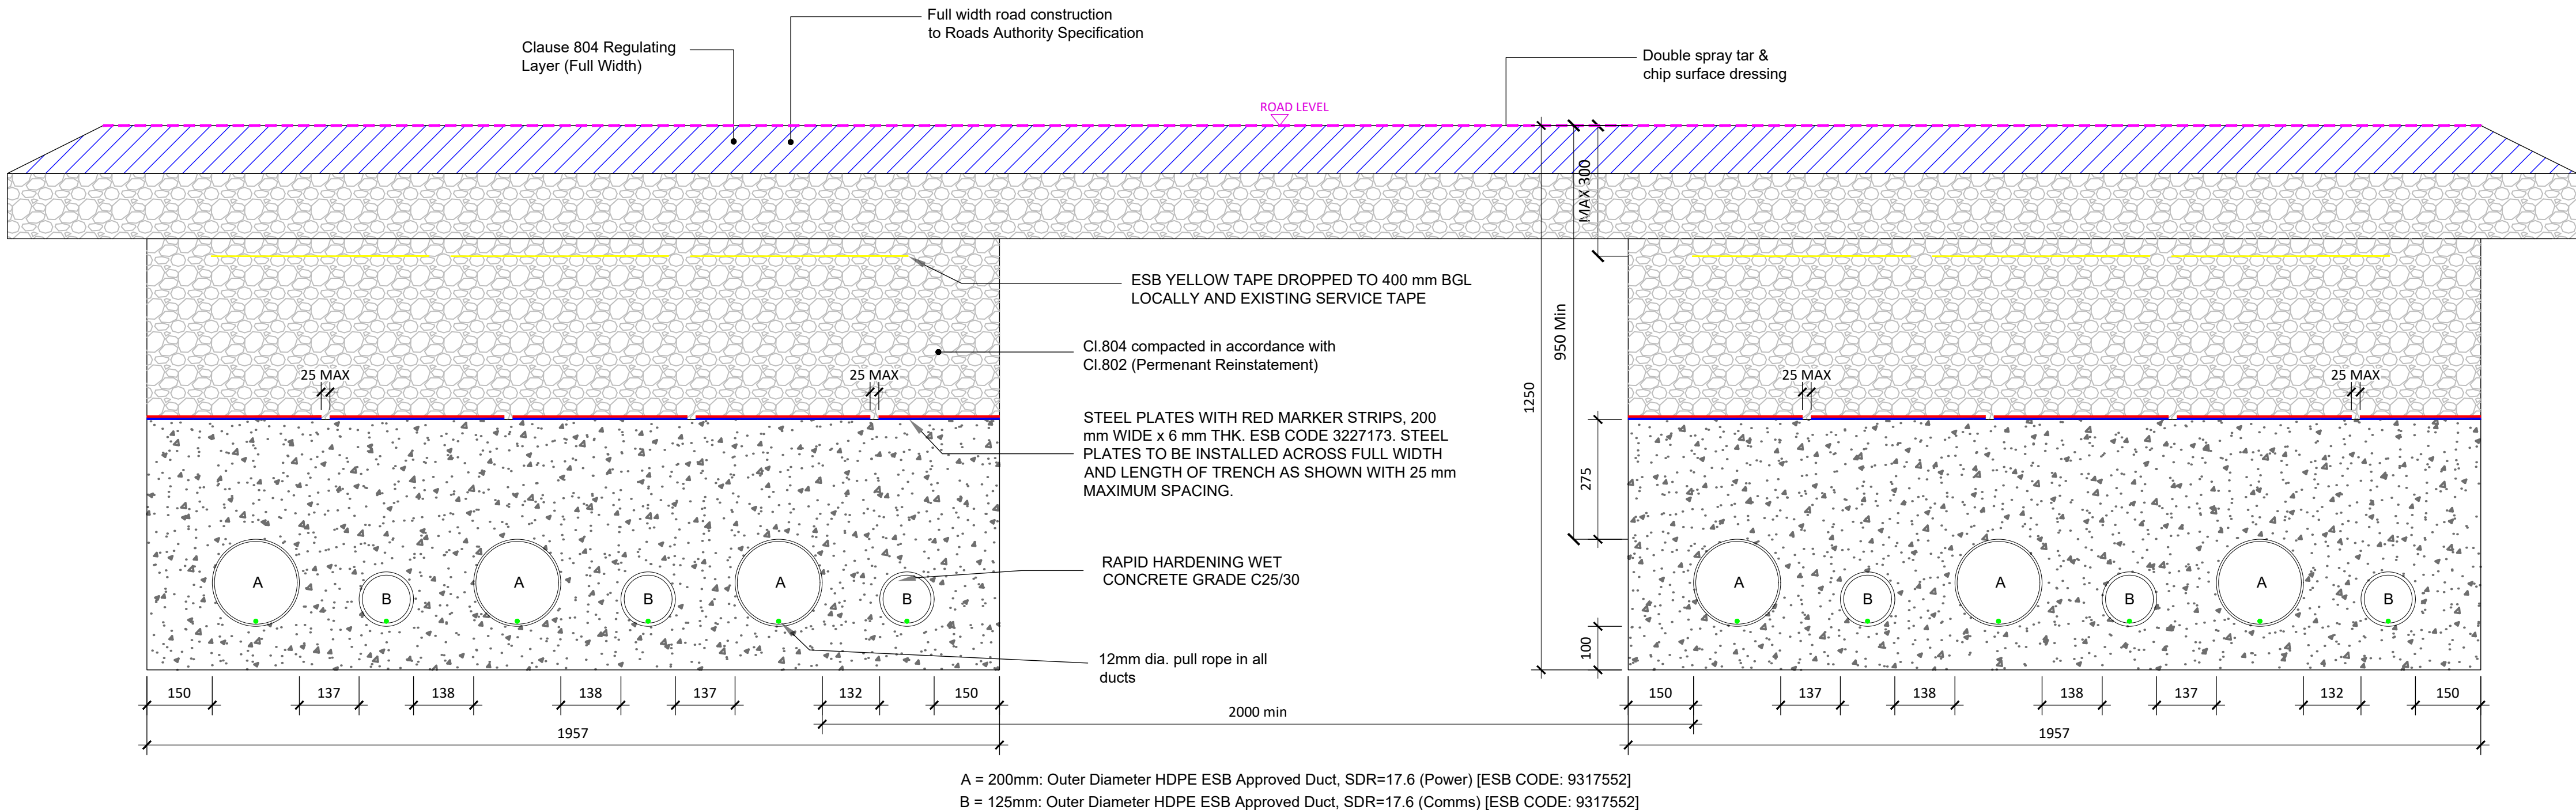

Ducting Through Road (Shallow Peat)

Scale : 1:50

ALL REINSTATEMENT WORKS ARE TO BE IN ACCORDANCE WITH LANDOWNER REQUIREMENTS

Reinstatement details based on Guidelines for Managing Openings in Public Roads - SD14

Note:

- This drawing is to be read in conjunction with relevant drawings, specifications and reports
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PROJECT

Clonberne Wind Farm  
220kV Grid Connection

CLIENT

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CONSULTANTS

Planning and Environmental Consultants

NOTES: -

LEGEND: -

ISSUE/REVISION		
P1	04.06.24	Issued for Planning
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SHEET TITLE

Ducting Through Public Road  
With and Without Peat


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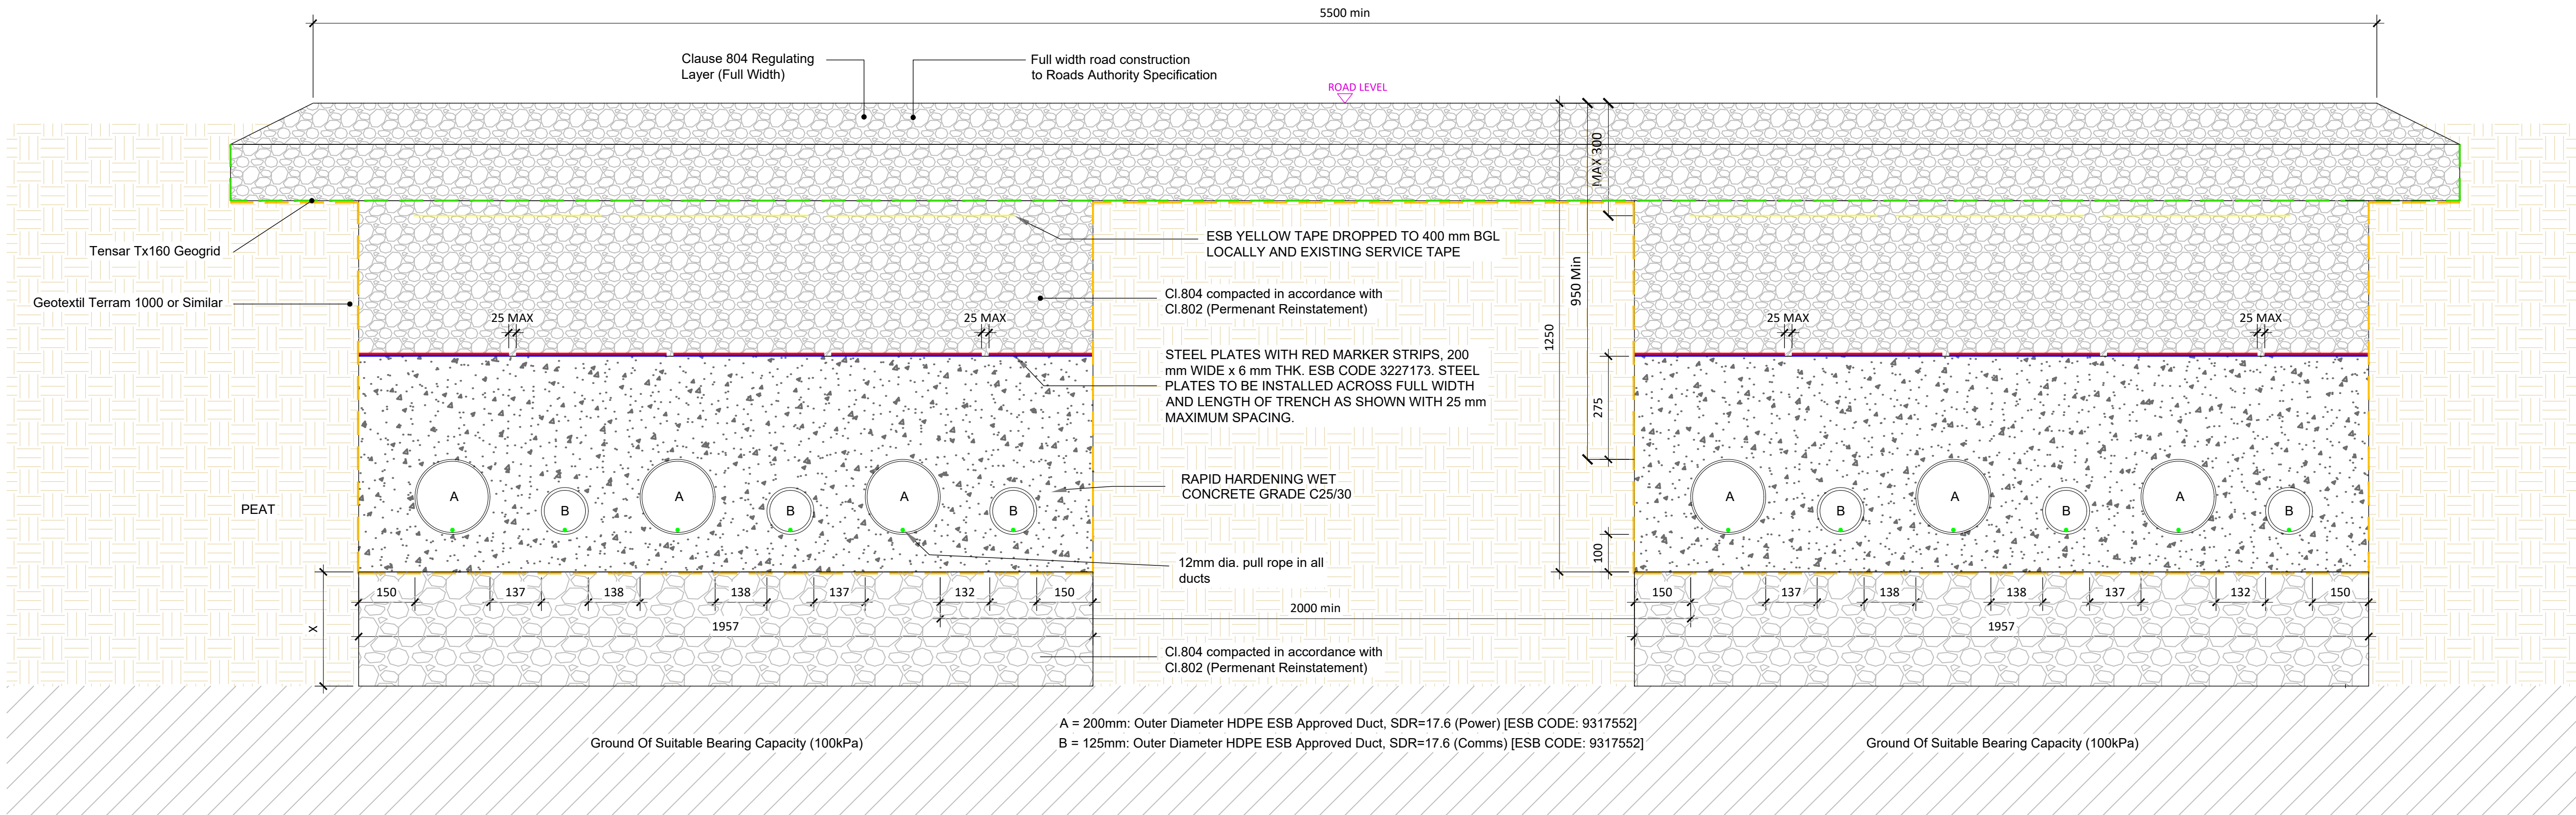
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Project Management Initials: Designer: JF Checked: AC Approved: RG



Ducting Through Access Road Cross Section

Scale : 1:50

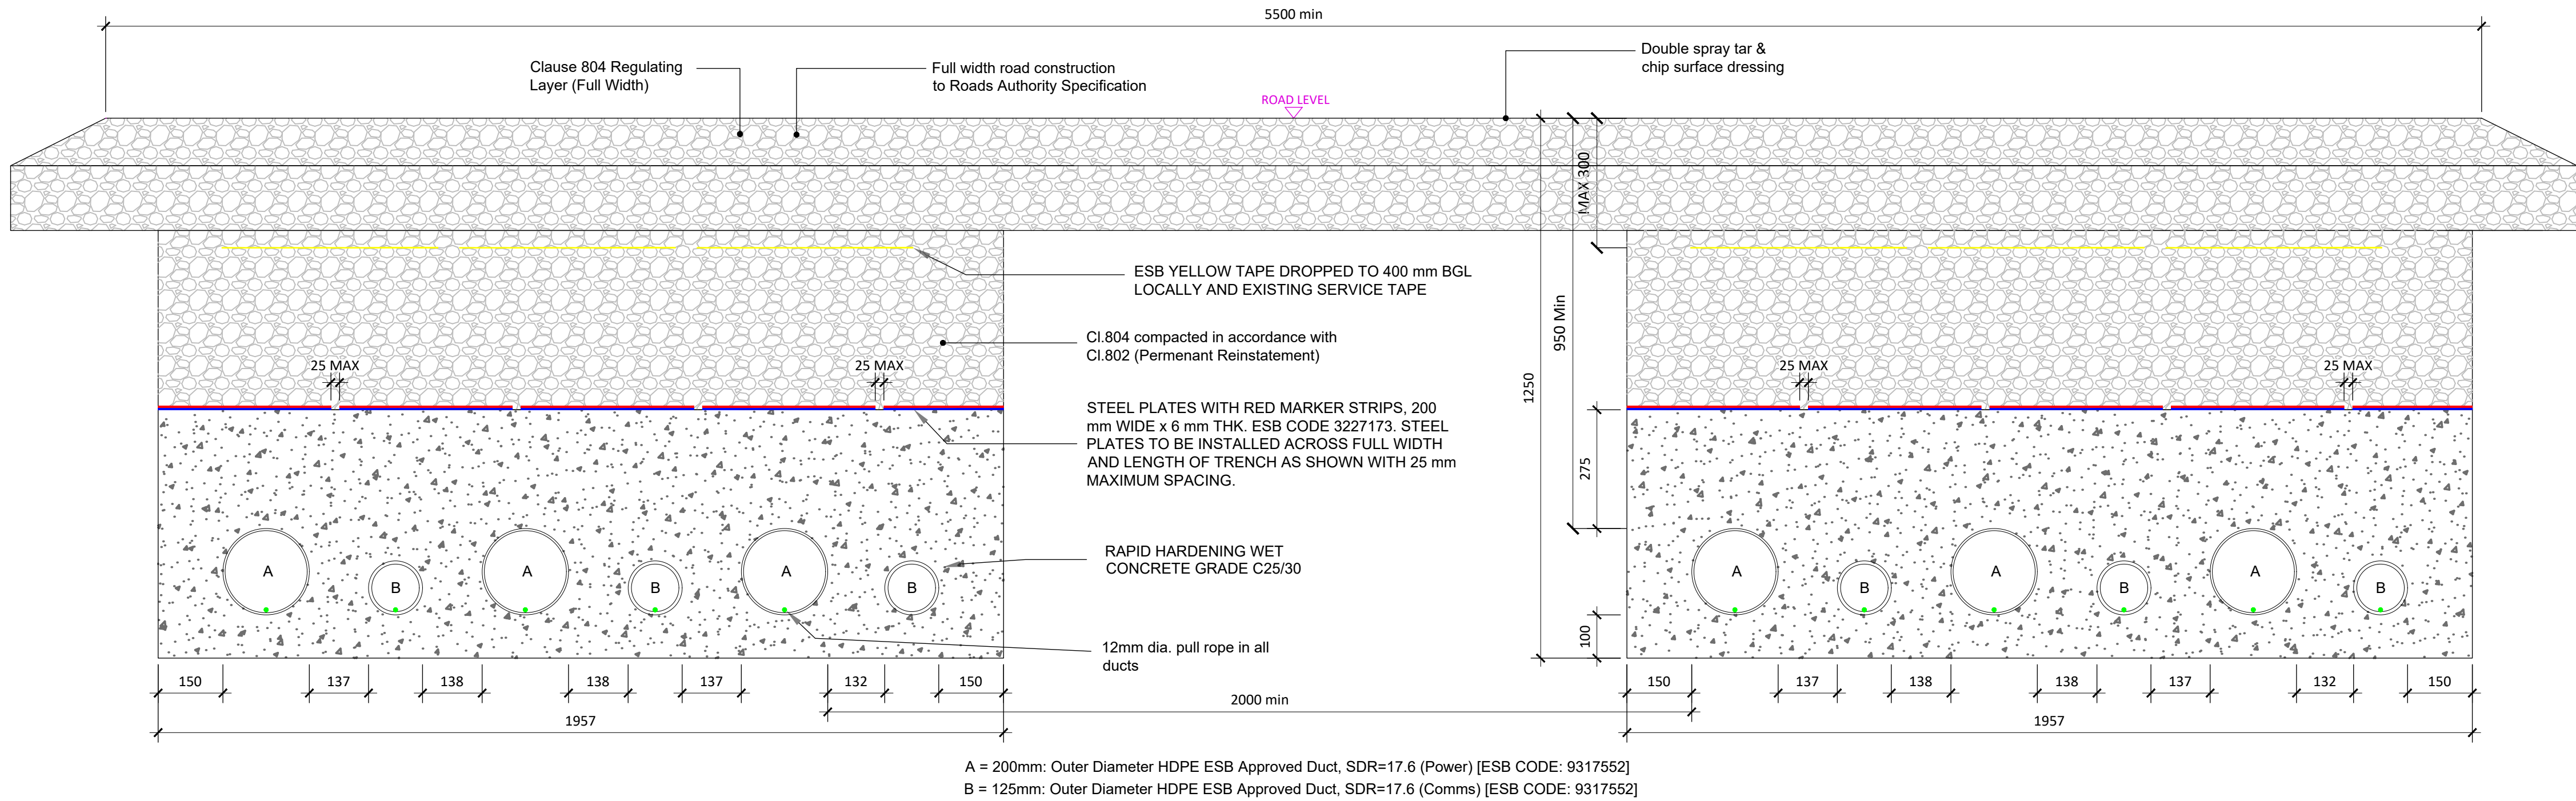

Ducting Through Access Road (Shallow Peat)

Scale : 1:50

ALL REINSTATEMENT WORKS ARE TO BE IN ACCORDANCE WITH LANDOWNER REQUIREMENTS

Reinstatement details based on Guidelines for Managing Openings in Public Roads - SD14

Note:

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PROJECT

Clonberne Wind Farm  
220kV Grid Connection

CLIENT

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CONSULTANTS

Planning and  
Environmental  
Consultants

NOTES: -

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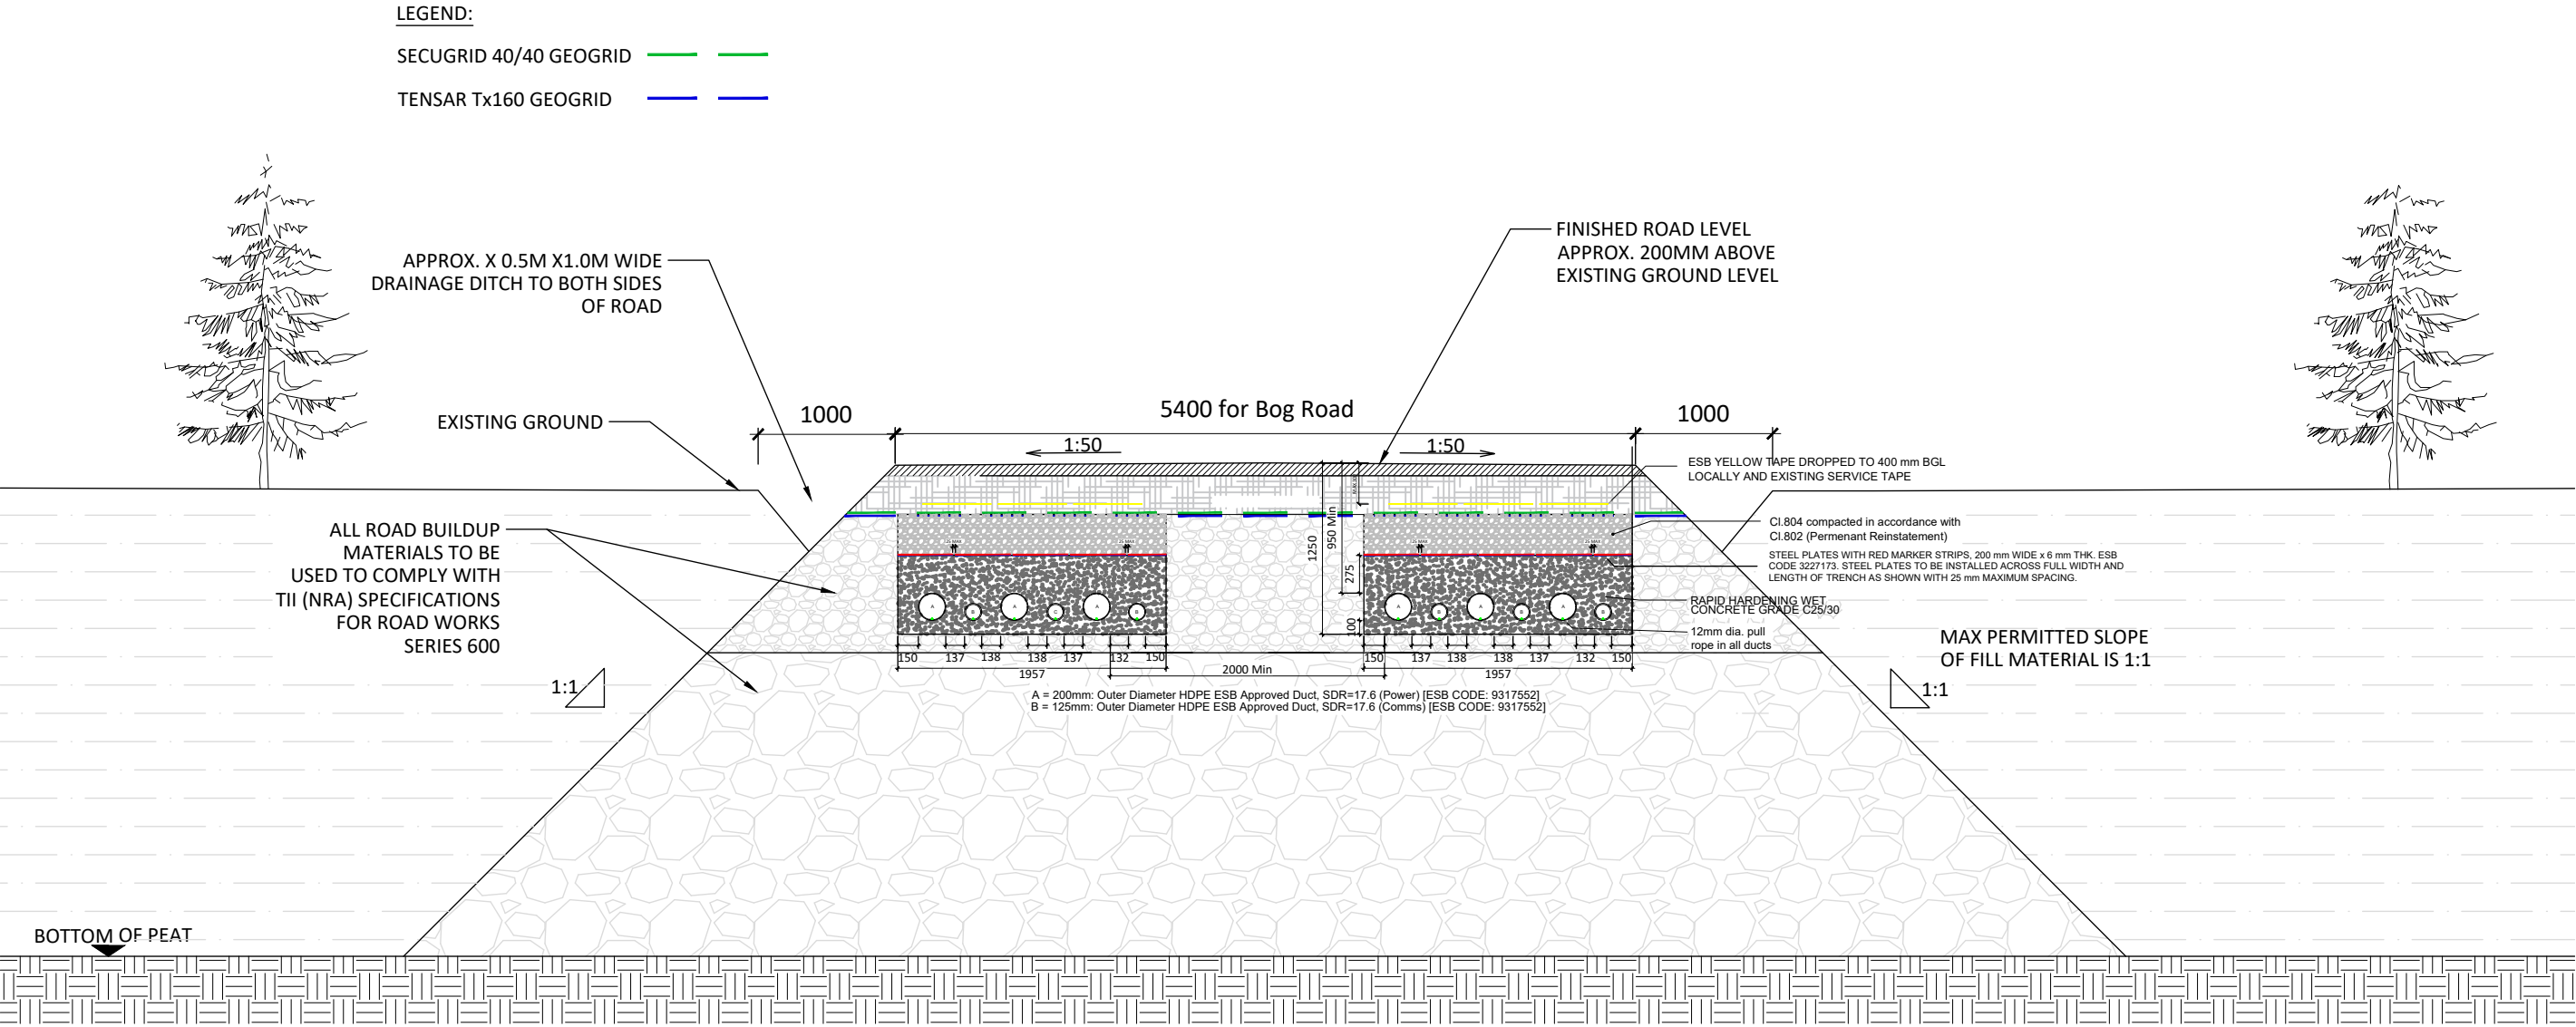
ISSUE/REVISION		
P1	04.06.24	Issued for Planning
I/R	DATE	DESCRIPTION

PROJECT NUMBER	
05-990	

SHEET TITLE	
Ducting Through Access Road With and Without Peat	

SHEET NUMBER	
05990-DR-124	





Cables in Bog Road Cross Section

Scale : 1:50

- Note:**
- 2. This drawing is subject to planning approval and should not be used for construction.
  - 3. This drawing is to be read in conjunction with relevant drawings, specifications and reports.
  - 4. Dimensions are in millimeters, unless noted otherwise.
  - 5. Drawings are not to be scaled use figured dimensions only.
  - 6. Underground cable circuit spacing to be determined during detailed design, road layout may change during detailed design with site investigation results.



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PROJECT  
Clonberne Wind Farm  
220kV Grid Connection



PROJECT NUMBER  
05-990

SHEET NUMBER  
05990-DR-125

SHEET TITLE  
Ducting in Bog Road  
Peat Depth < 2.5m  
DRAWING STATUS  
For Information

ISSUE/REVISION		
P1	04.06.24	Issued for Planning
I/R	DATE	DESCRIPTION



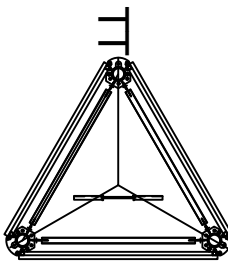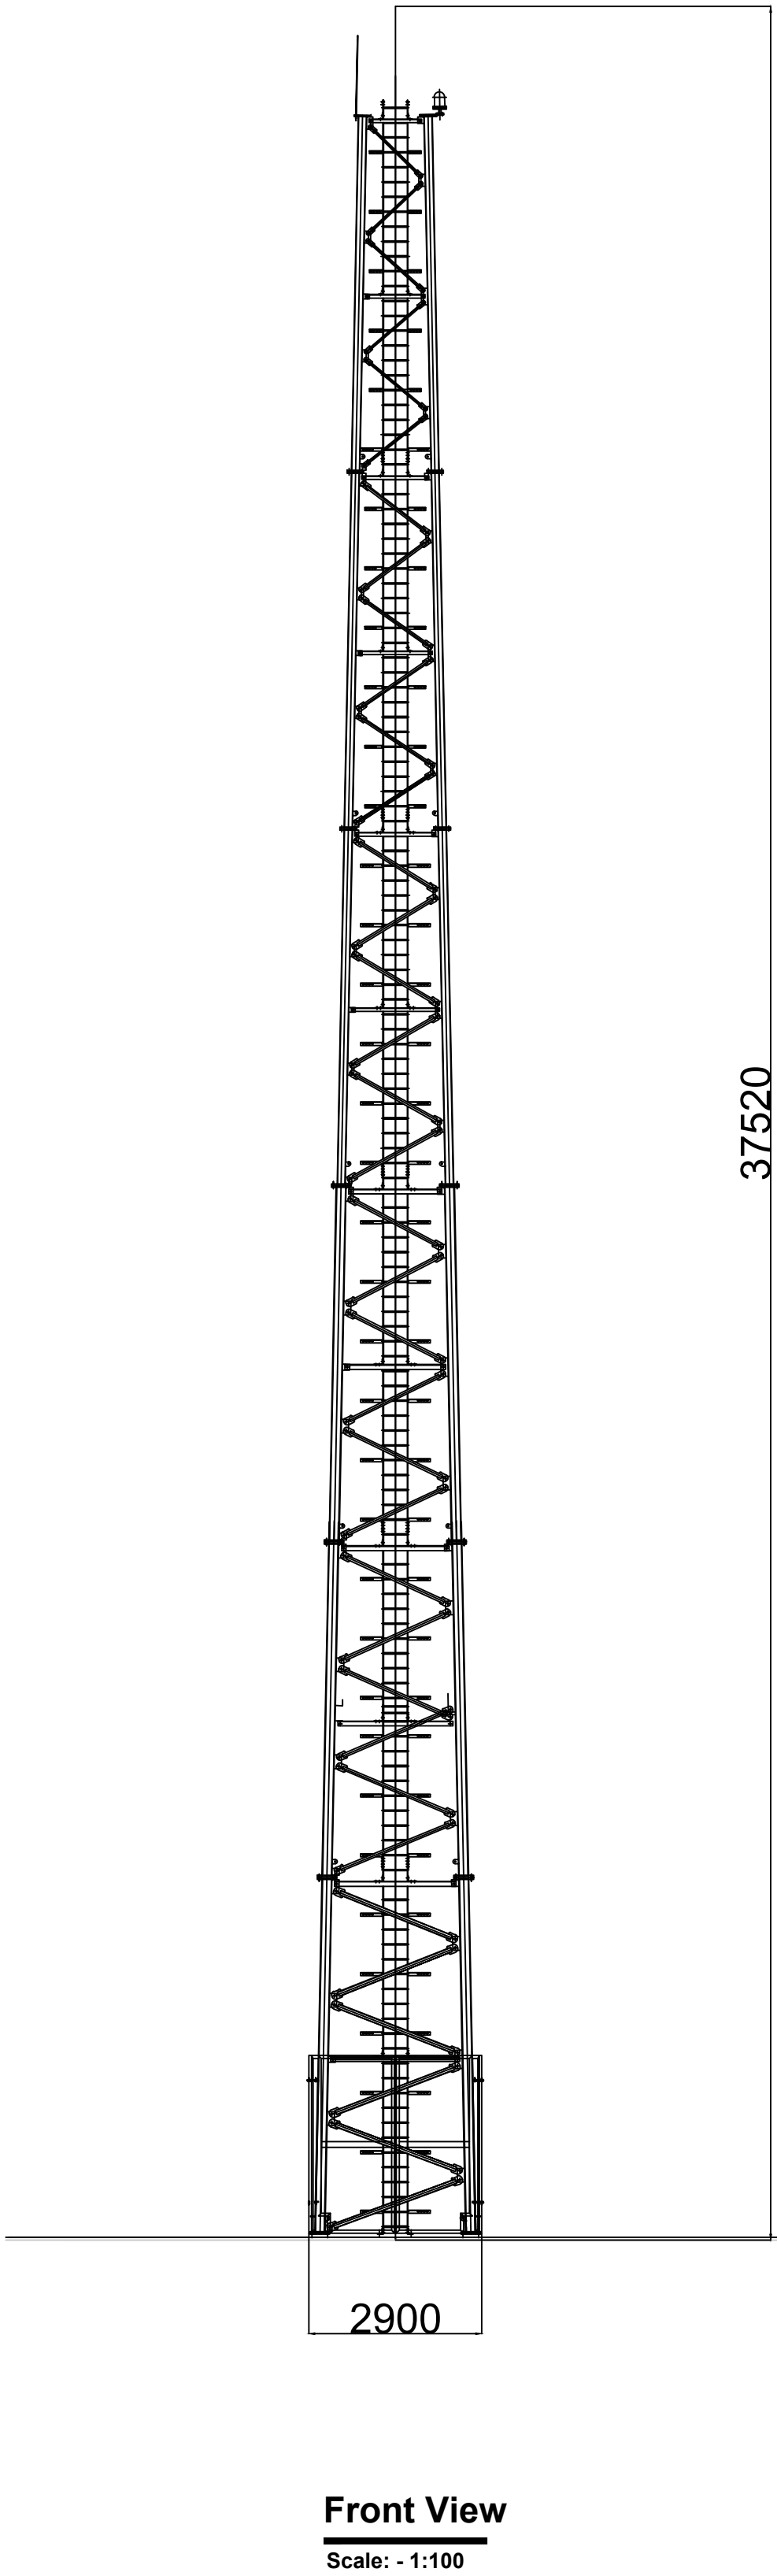

**Plan View**  
Scale: - 1:100



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PROJECT

Clonberne Wind Farm  
220kV Grid Connection

CLIENT

Clonberne Windfarm Limited

CONSULTANTS

NOTES: -

1. All dimensions noted are in mm  
2. Drawing is for planning purposes only  
3. Equipment/Structure details are indicative only and will be finalised during detailed design stage is  
4. Detailed design shall be carried out in line with system operator and asset owner specifications.

LEGEND: -

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P1	04.06.24	Issued for Planning
I/R	DATE	DESCRIPTION

PROJECT NUMBER

05-990

SHEET TITLE

Telecom Tower


SHEET NUMBER

05990-DR-126



ISO A1 594mm x 841mm

Project Management Initials: Designer: JF Checked: AC Approved: RG

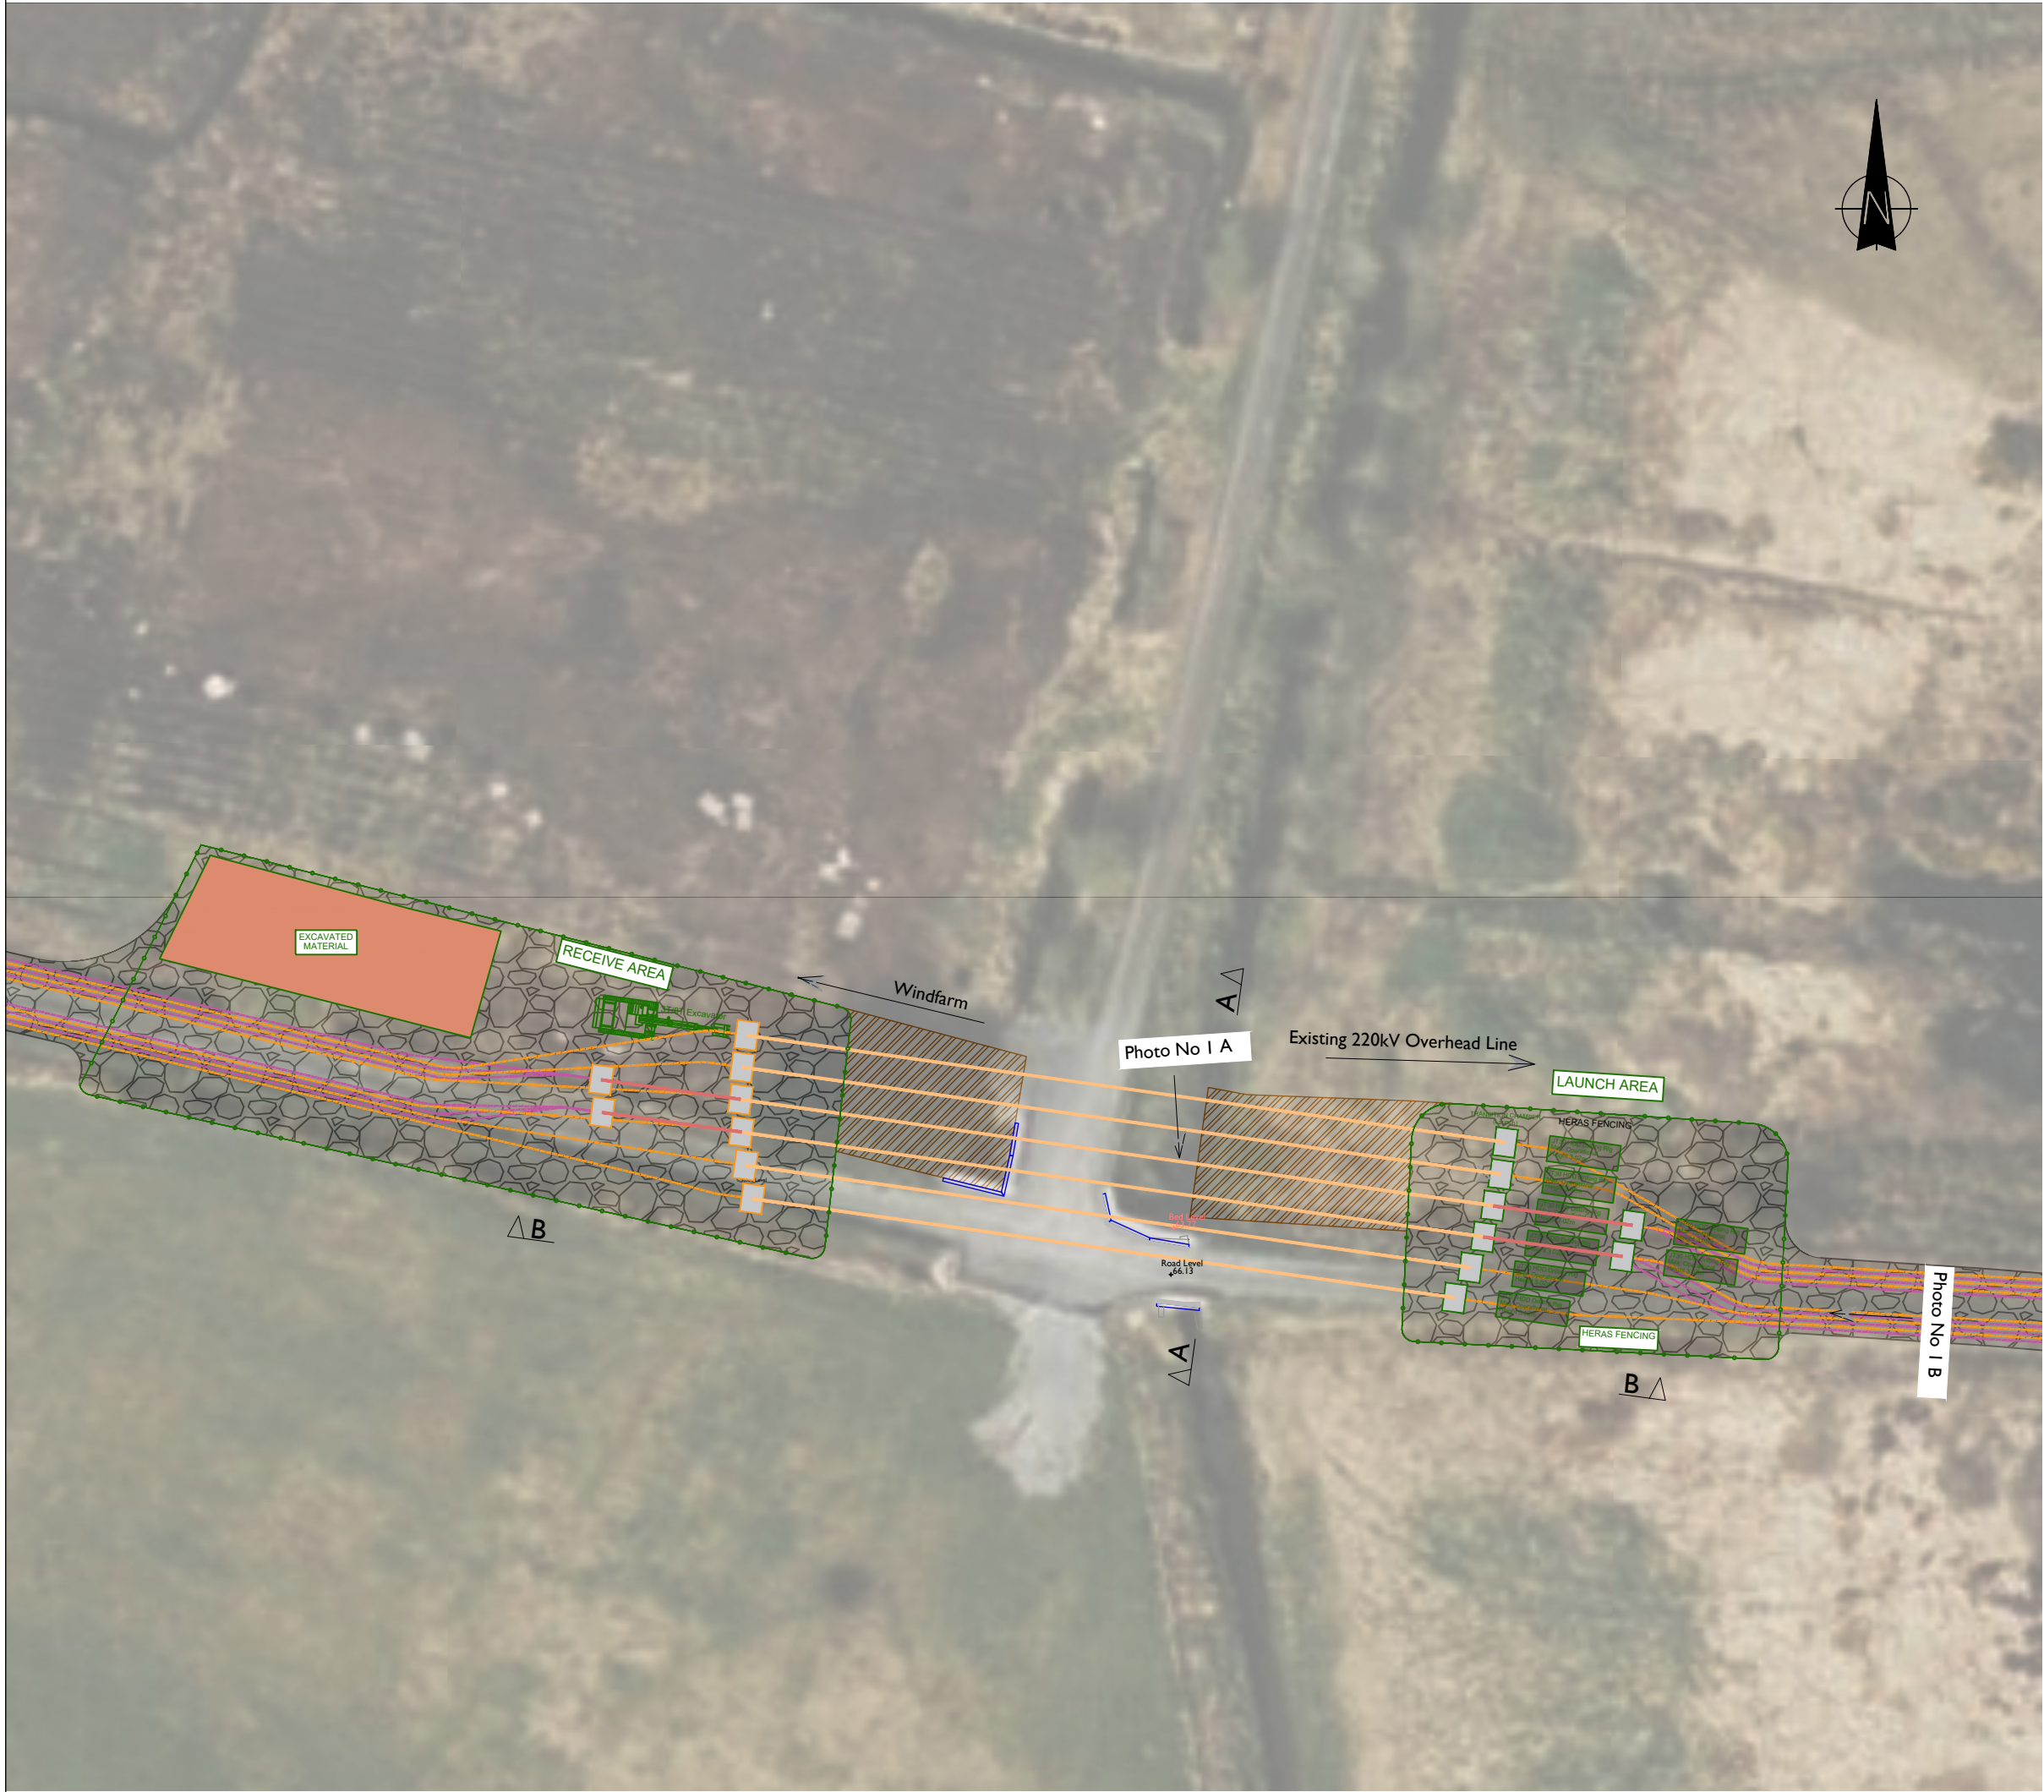


Plan View Bridge No I  
Scale : 1:250





Photo No I A



Photo No I B

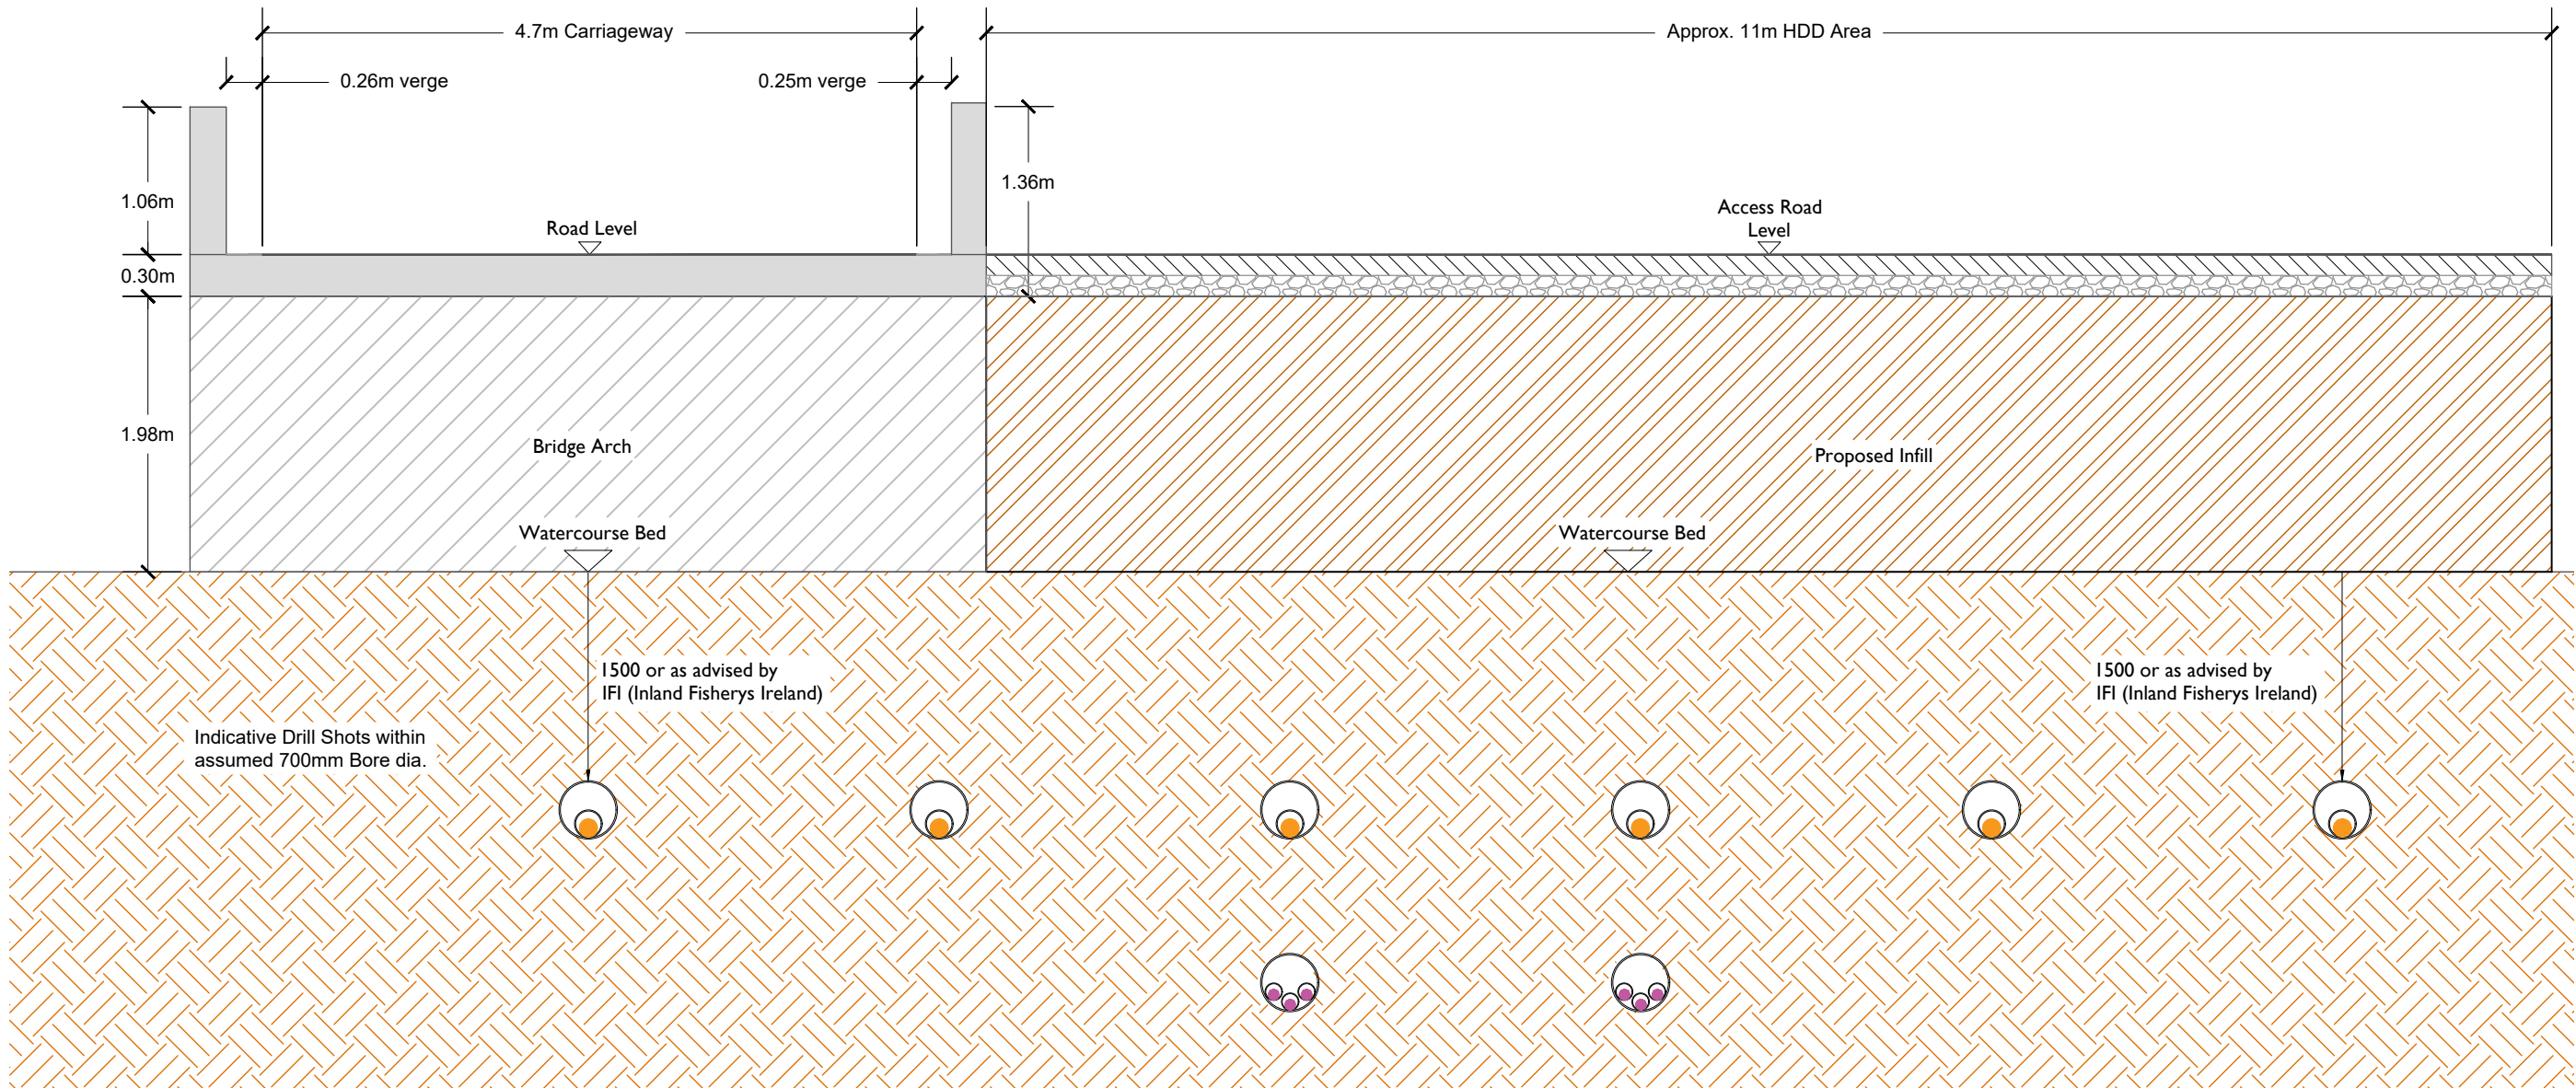

Section A-A  
Scale : 1:50

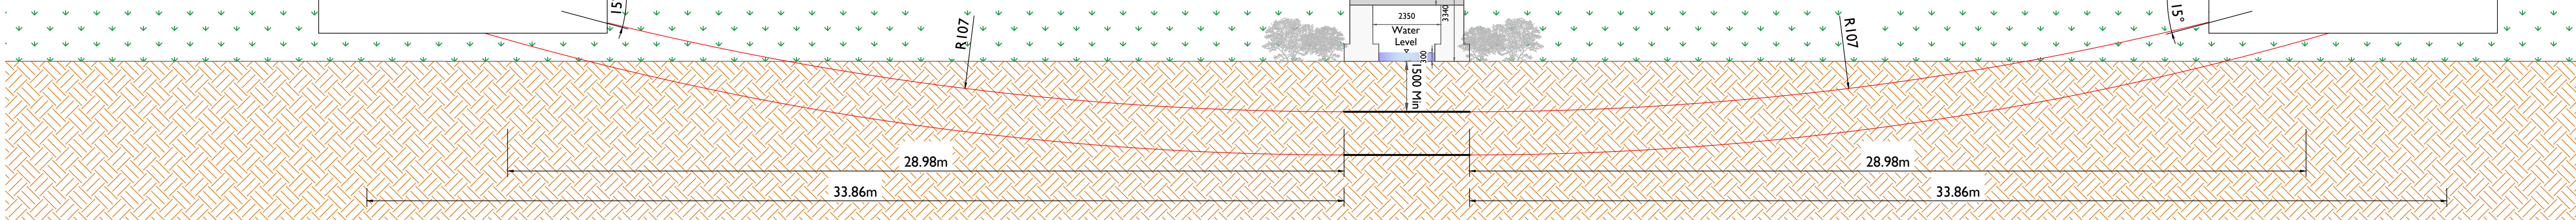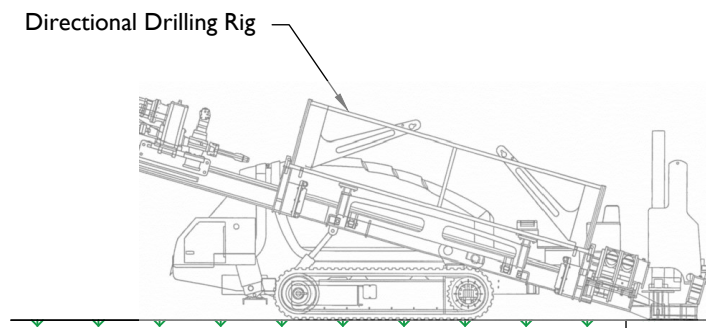

Section B-B  
Scale : 1:75



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PROJECT

Clonberne Windfarm  
220kV Grid Connection

CLIENT

Clonberne Windfarm Limited

CONSULTANTS

- NOTES: -
- Bridge crossing designs will be submitted to Galway Co. Council for review.
  - Drawings are in compliance with ESNB specification requirements for shallow formation, bridge crossings, etc.
  - HDD launch and reception pits locations to be determined following site investigations.
  - Single or multi bore to be confirmed following site investigation and confirmed at detail design
  - Bridge Crossing design requires ESB/EirGrid approval and may be subject to change.

LEGEND: -

Proposed 220kV Cable ————

Communications and ECC Cable ————

ISSUE/REVISION		
P1	04.06.24	Issued for Planning
I/R	DATE	DESCRIPTION

PROJECT NUMBER

05-990

SHEET TITLE

Bridge I - Proposed Crossing Details


SHEET NUMBER

05990-DR-127




ISO A1 594mm x 841mm

Project Management Initials: Designer: JC Checked: POS Approved: GH

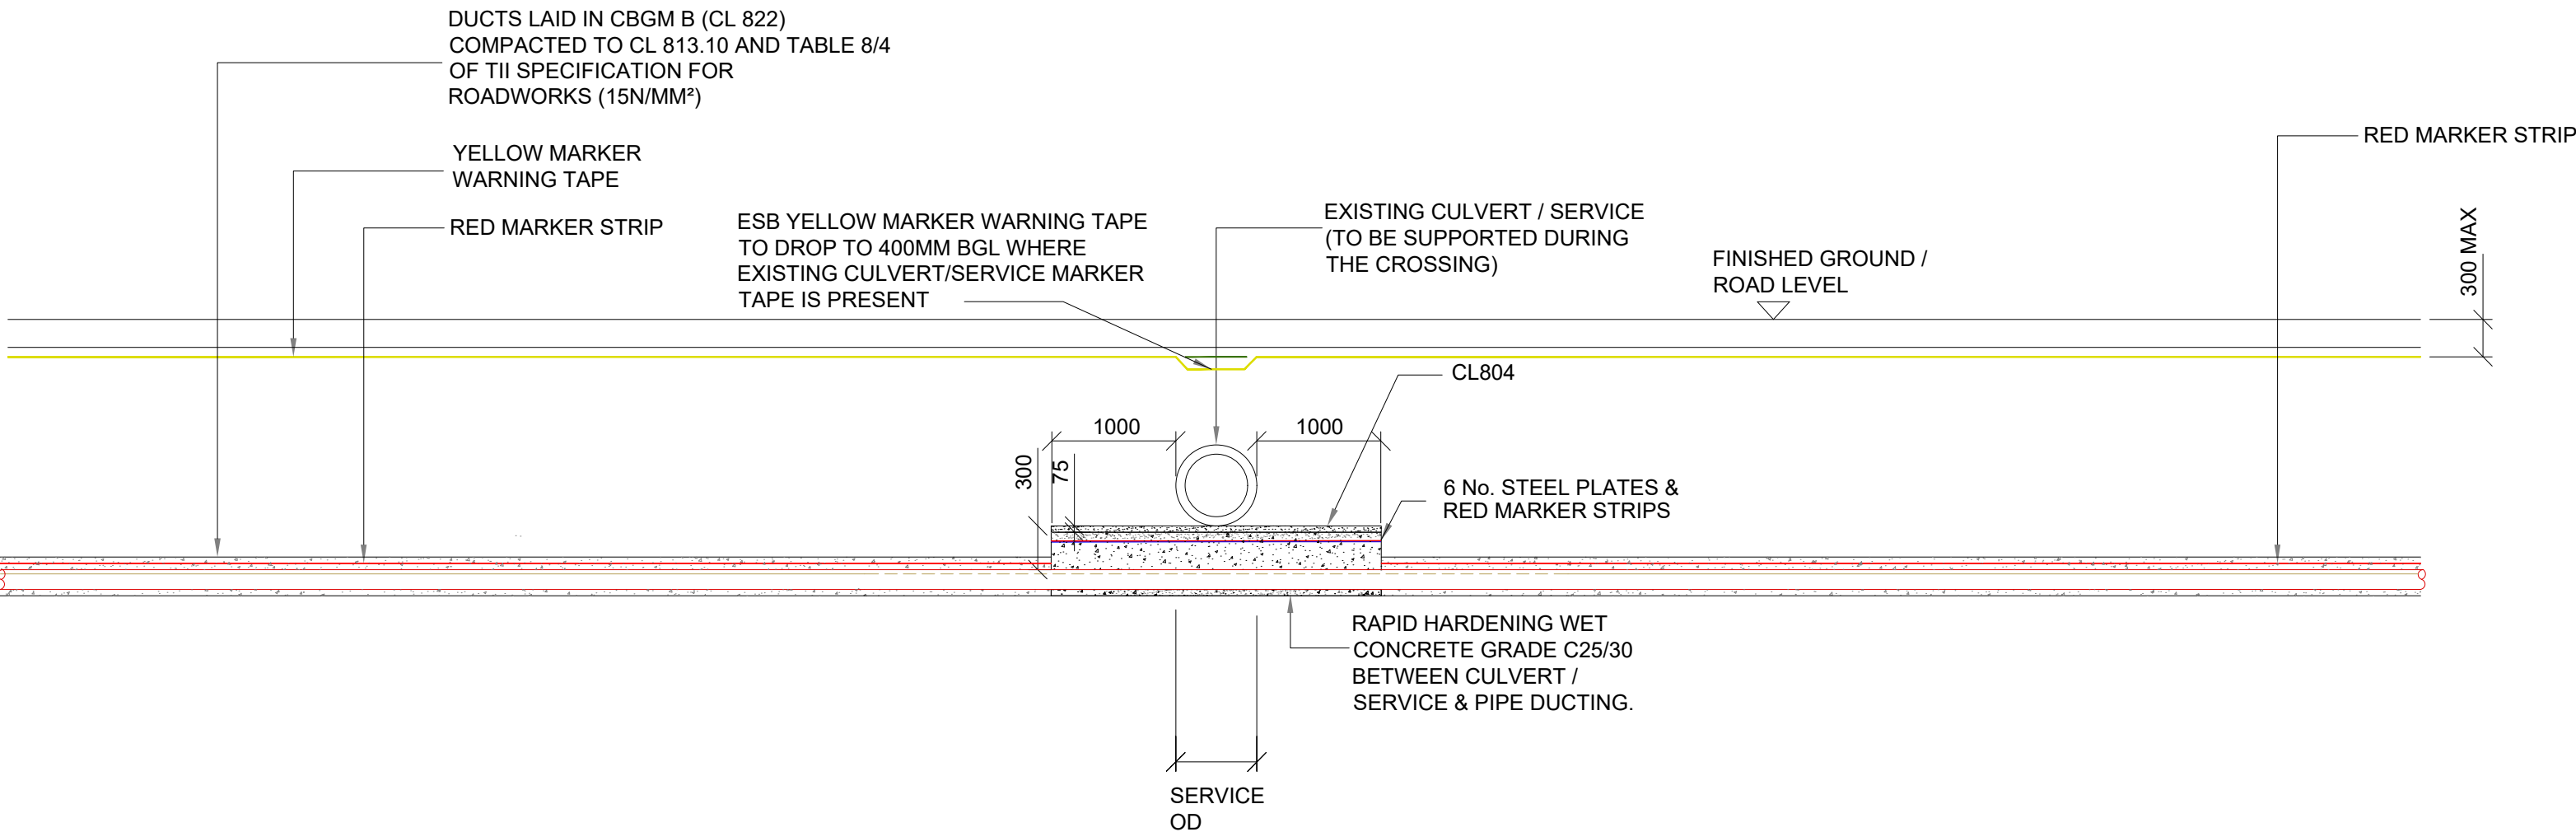


**SECTION A-A**  
SCALE 1:50

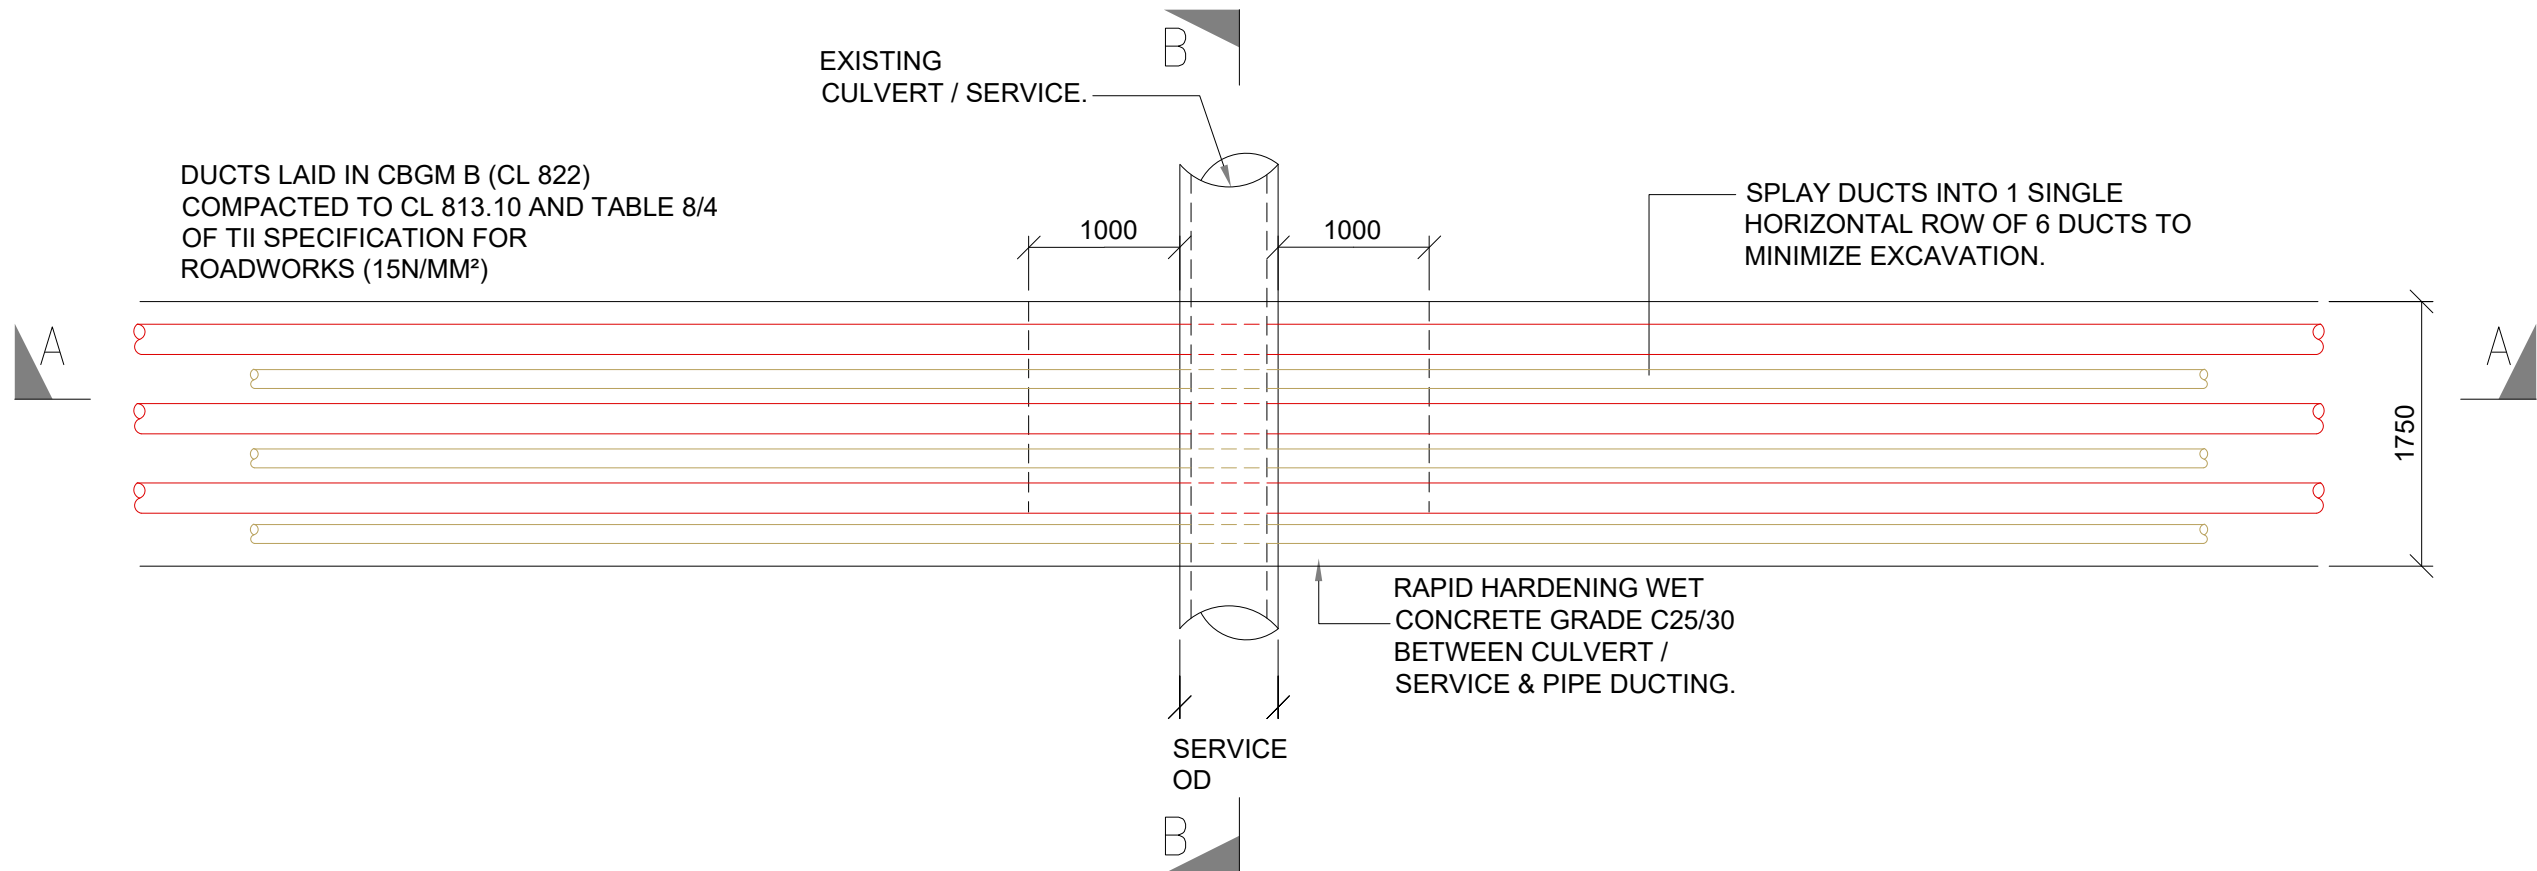


**PLAN VIEW**  
SCALE 1:50

**SERVICE UNDERCROSSING**

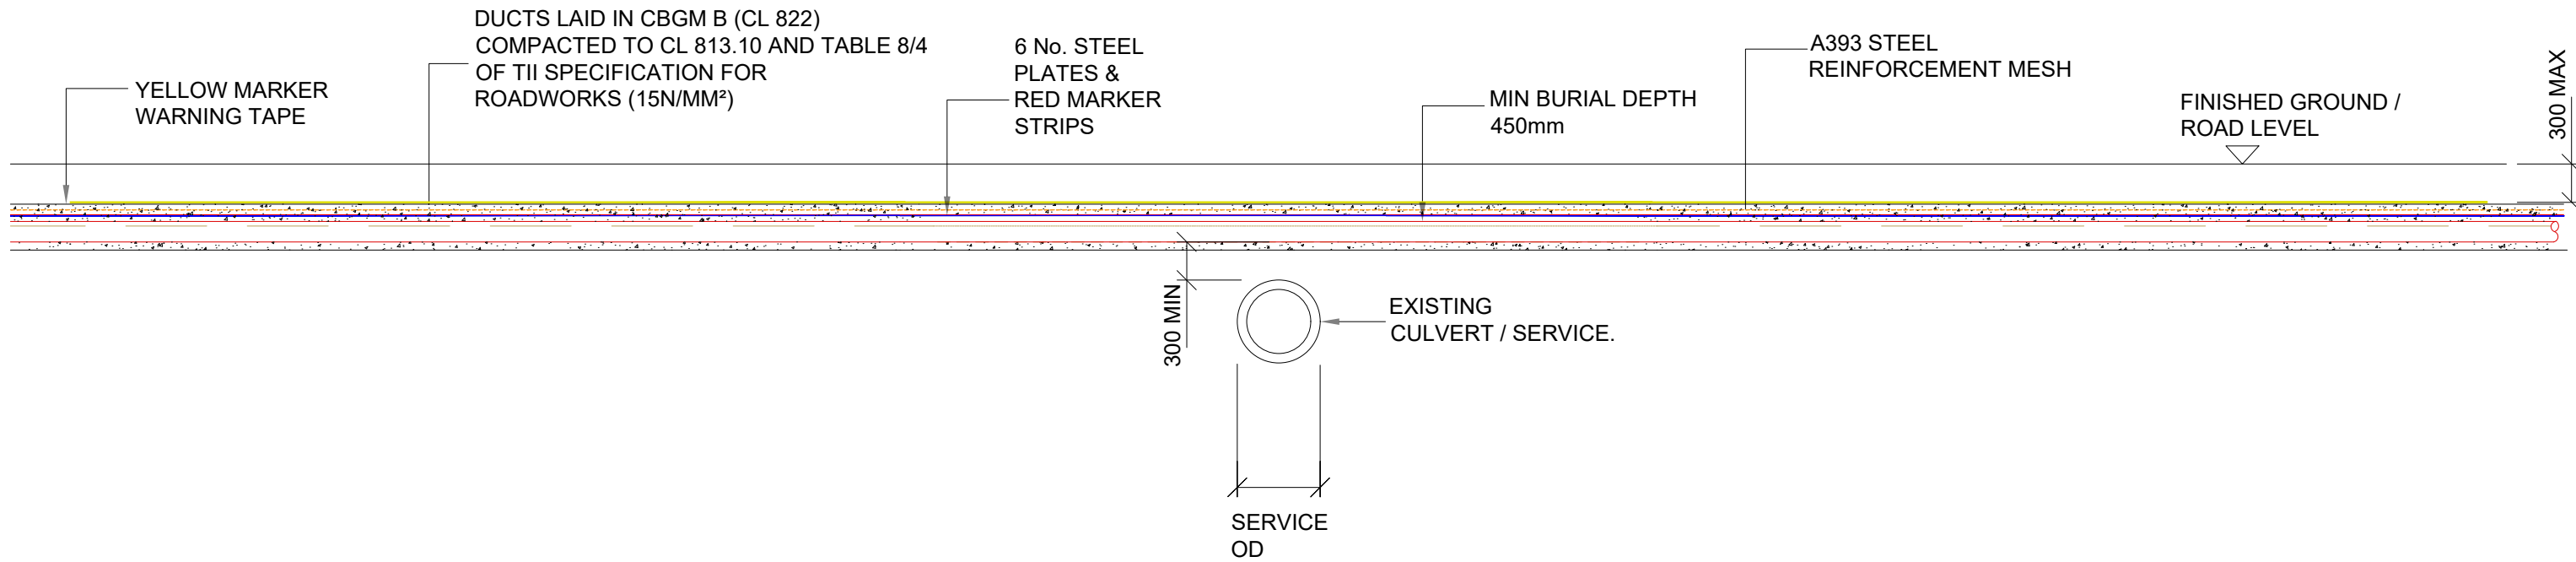

**SECTION C-C**  
SCALE 1:50

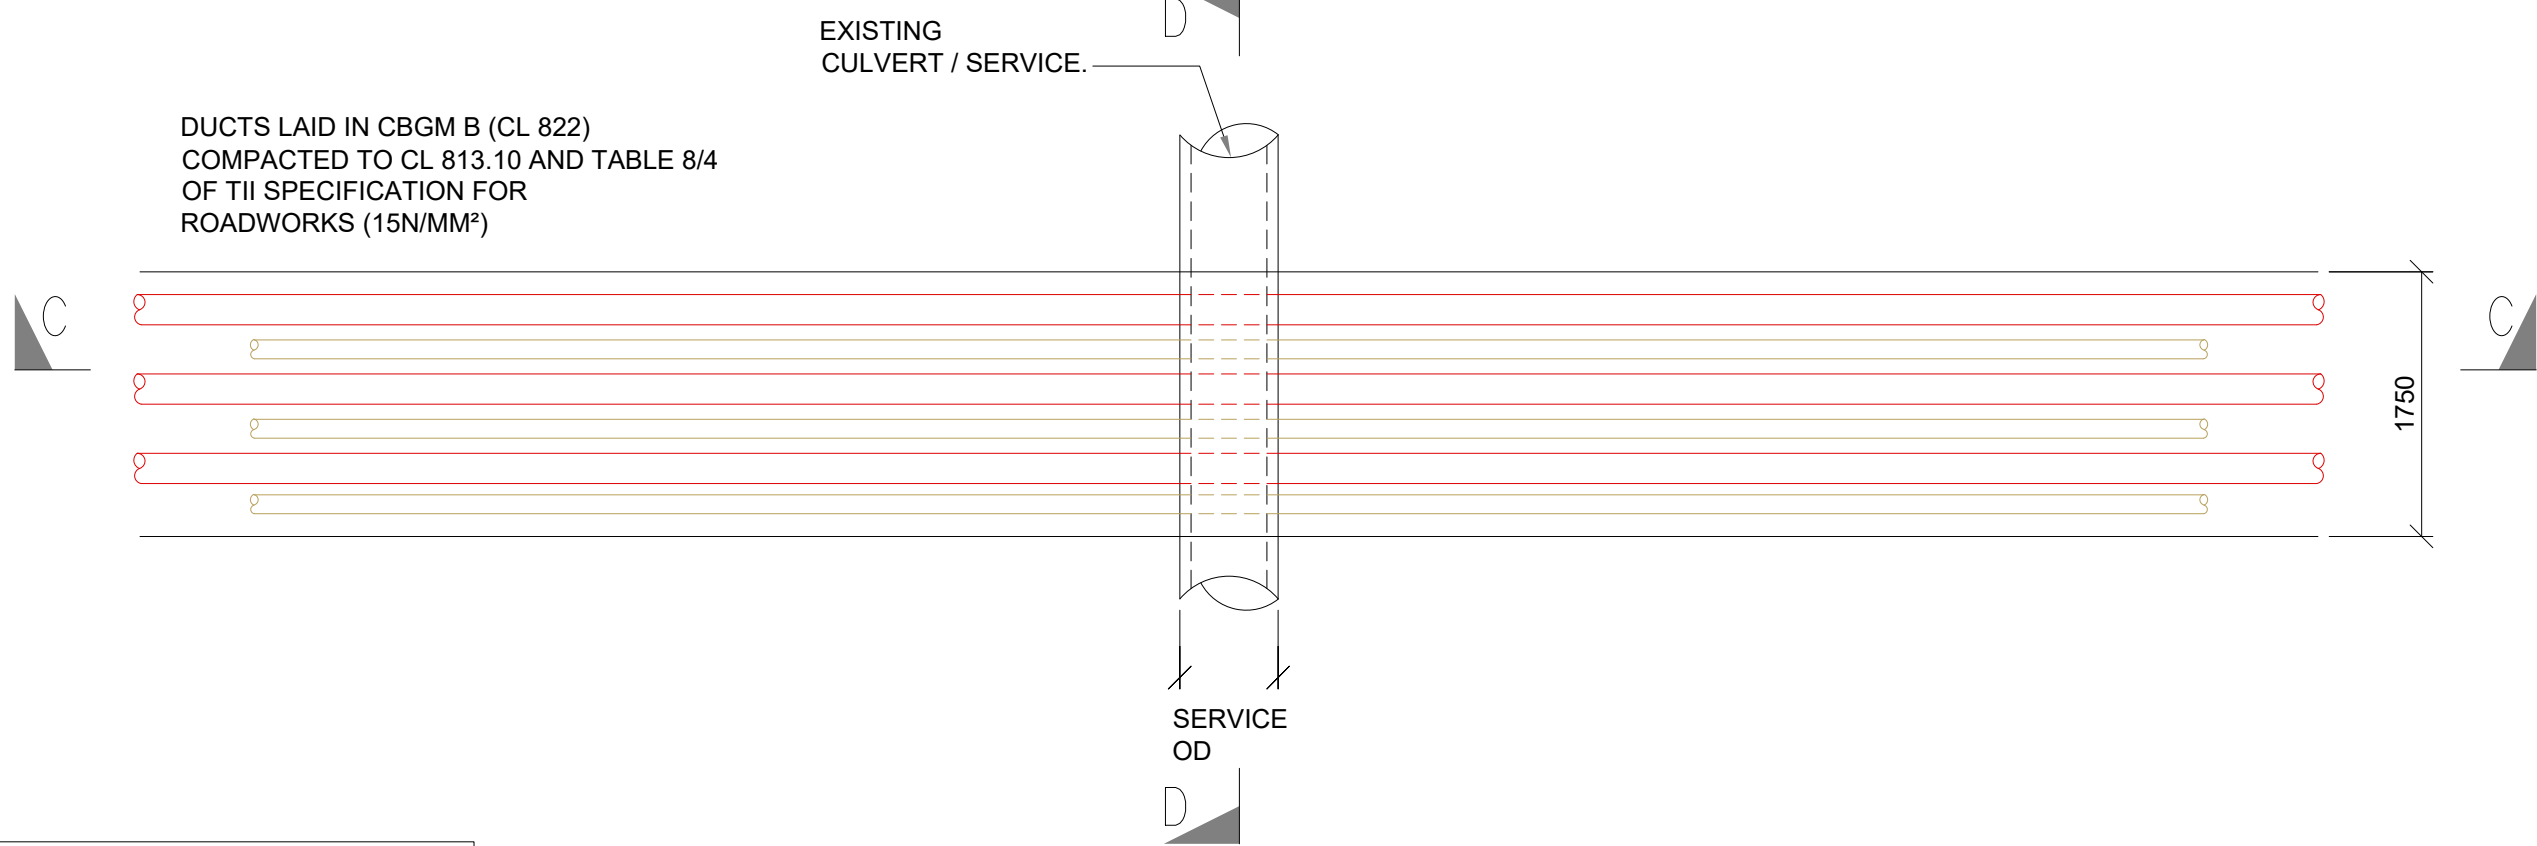


**PLAN VIEW**  
SCALE 1:50


**SERVICE OVERCROSSING**

**GENERAL NOTES**

1. This drawing is to be read in conjunction with all other relevant documentation.
2. Do not scale from this drawing use only printed dimensions.
3. All dimensions are in millimetres, all chainages, levels and co-ordinates are in metres unless defined otherwise.
4. This drawing is to be read in conjunction with the project Health & Safety file for any identified potential risks.
5. No excavation shall commence until the contractor has consulted up to date services drawings and carried out an Electromagnetic Locator (EML) Scan.
6. Hand dig only within 500mm of existing services.
7. If compacting CBGM B could cause damage to the culvert / service below, use rapid hardening cement grade C25/30 following engineers prior approval.
8. For standard trench cross section drawings and minimum horizontal separation to existing services, see 05990-DR-122(FLAT).
9. Where depths exceed 3000mm to the top of duct the contractor shall consult the cable system design engineer for phase spacing requirements.
10. For Watermain crossings, see 05990-DR-128
11. All Products and materials to be utilised during construction to comply with Eirgrid functional specification for road works and all relevant Irish (European) and British standards
12. 300mm minimum vertical and horizontal clearances to be observed between cable ducts and third party services (e.g. gas pipes, water mains, culverts etc.) In the case of high risk 3rd party services, greater clearances may be required. Designer to consult Eirgrid and 3rd party service owners for guidance
13. Steel plates must cover ducts. No overlap is required however standard dimensions may result in an overlap. Spacing of 10mm to be maintained between steel plates to prevent the transfer of stray current.
14. Templates are to be used at 5m intervals during duct installation in CBGM. Pre-made 75mm wide concrete spacers to be used during duct installation in wet concrete
15. If existing service marker tape is not present, the ESBN yellow marker tape should be installed at maximum 300mm below finished surface level

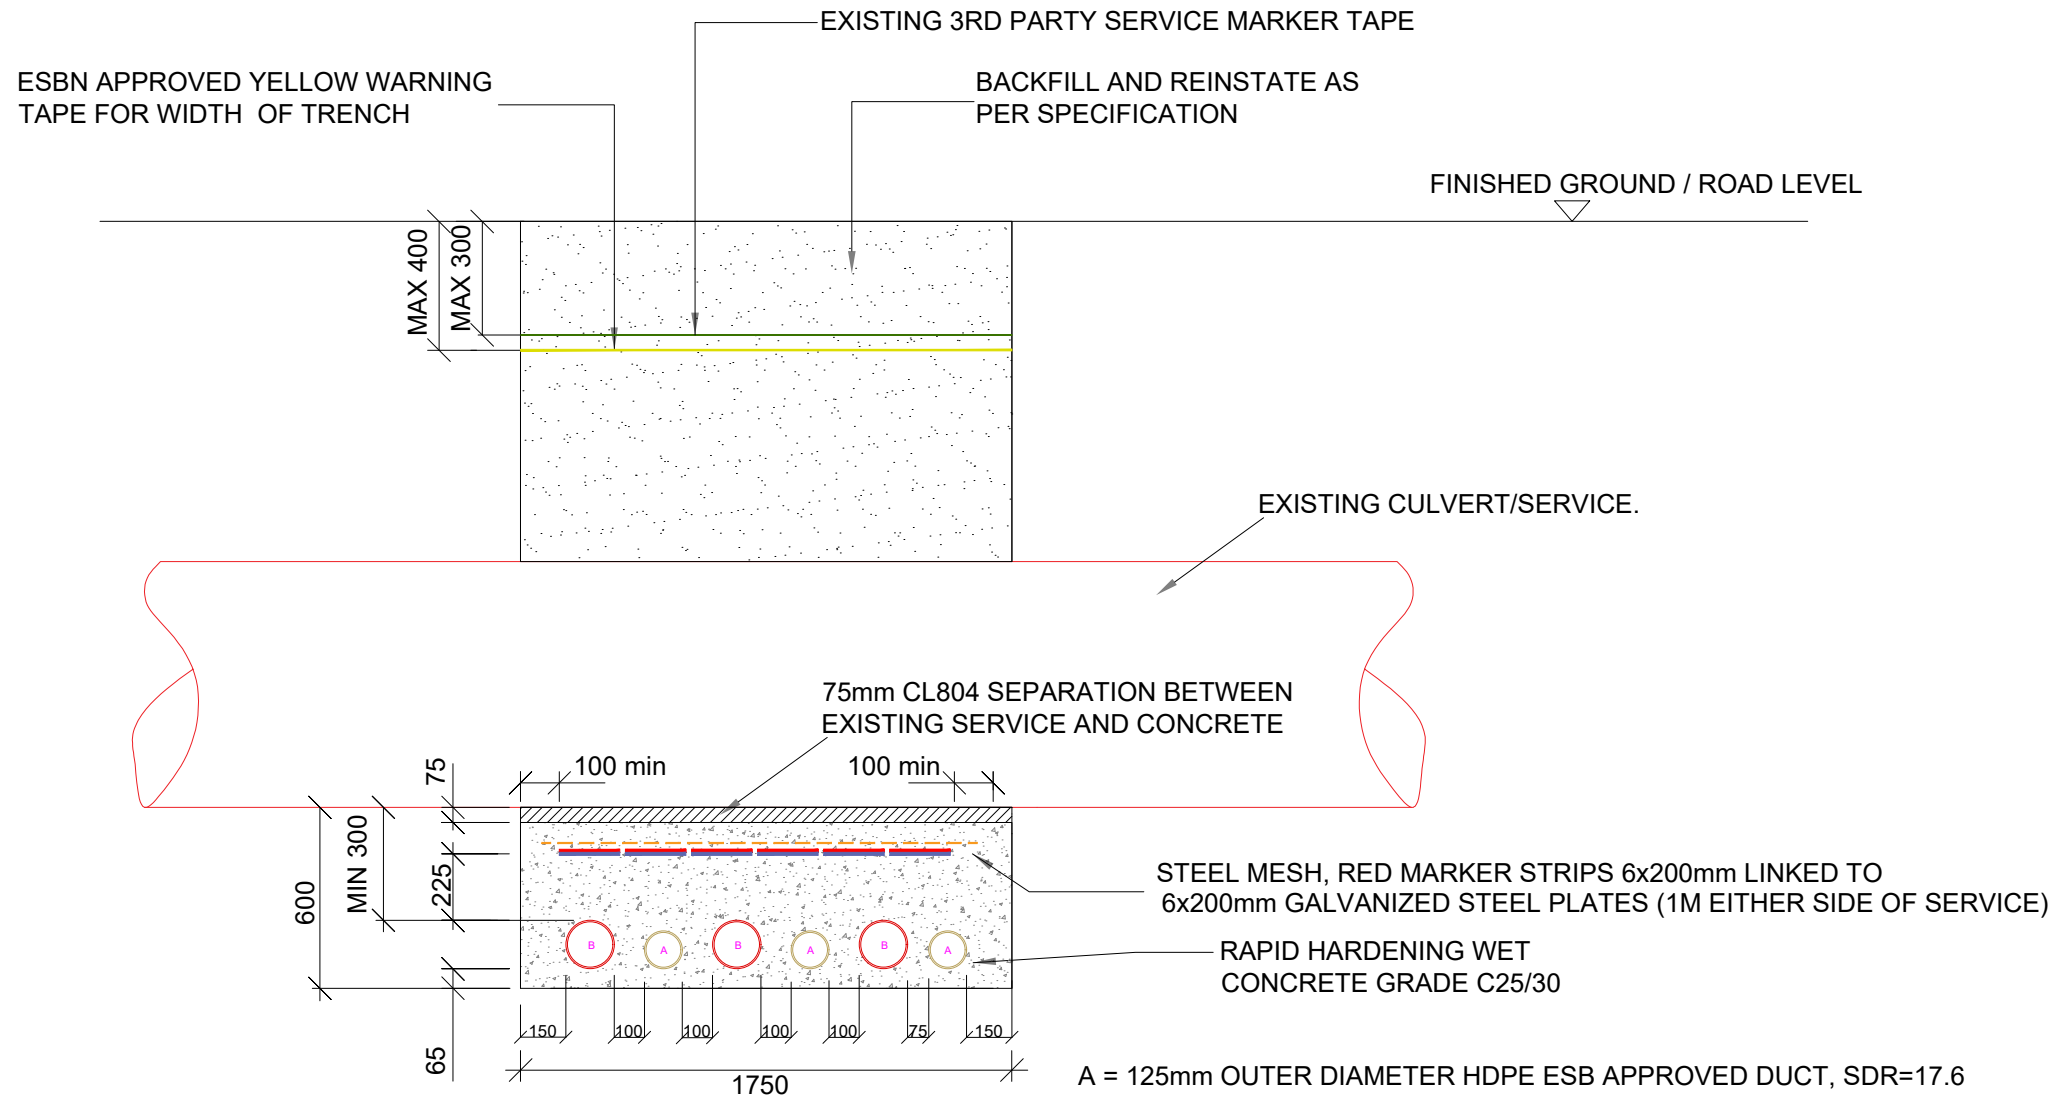

**SECTION B-B**  
SCALE: NTS

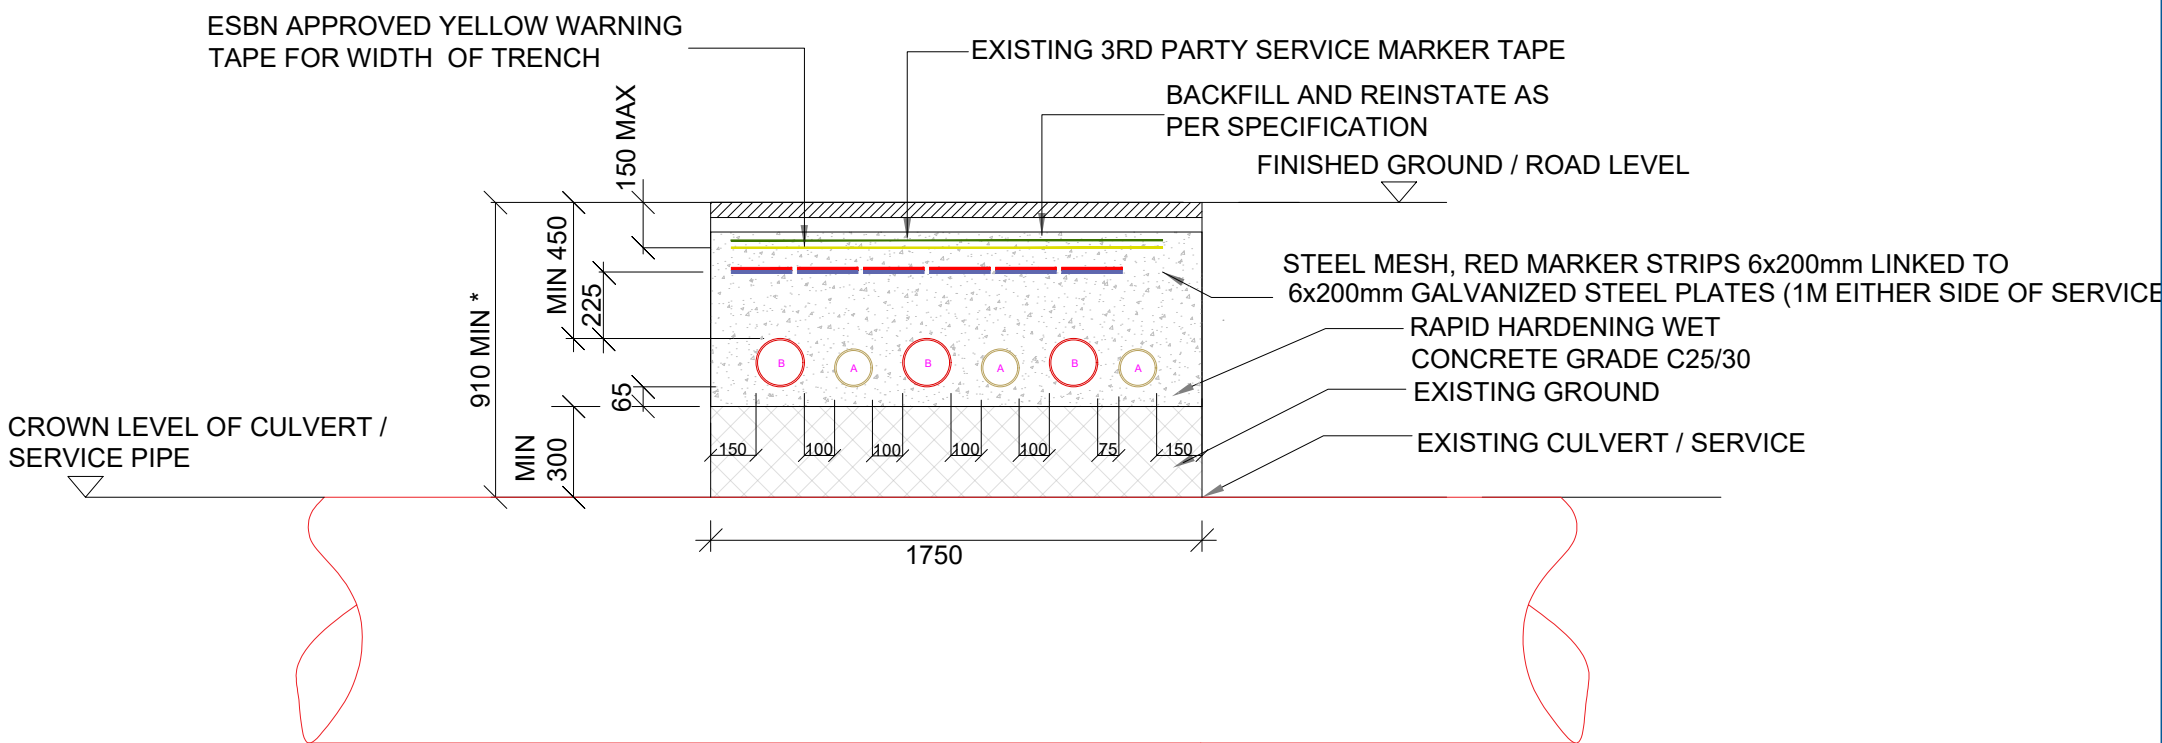

\* ALL EXISTING SERVICES WITH COVER LESS THAN MIN. DIMENSIONS ABOVE SHALL BE CROSSED BY UNDERCROSSING METHOD

**SECTION D-D**  
SCALE: NTS

**LEGEND**

- |  |  |  |                                  |
|--|--|--|----------------------------------|
|  | 160mm Ø HDPE POWER DUCT WITH 12mm DIAMETER PULL ROPE         |  | YELLOW MARKER WARNING TAPE       |
|  | 125mm Ø HDPE COMMUNICATION DUCT WITH 12mm DIAMETER PULL ROPE |  | A393 STEEL REINFORCEMNET MESH    |
|  |  |  | 6mm GALVANISED STEEL PLATE       |
|  |  |  | EXISTING 3RD PARTY MARKER TAPE   |
|  |  |  | RED MARKER STRIP OR STEEL PLATES |



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**PROJECT**

**Clonberne Windfarm  
220kV Grid Connection**

**CLIENT**

Clonberne Windfarm Limited

**CONSULTANTS**

**NOTES:-**

See General Notes

**LEGEND:-**

**ISSUE/REVISION**

P1	04.06.24	Issued for Planning
I/R	DATE	DESCRIPTION

**PROJECT NUMBER**

05-990

**SHEET TITLE**

Trench Sections for  
Crossing Existing Culverts/Services

**SHEET NUMBER**

05990-DR-128





**SECTION C-C**  
SCALE 1:50



11. Backfill as per guidelines for the opening, backfilling and reinstatement of openings in public roads (2015)
12. As per W15 4-08-02 & IGN 4-08-01 granular material shall be 14mm to 5mm graded aggregate or 10mm single sized aggregate
13. All Products and materials to be utilised during construction to comply with Eirgrid functional specification for road works and all relevant Irish (European) and British standards
14. 300mm minimum vertical and horizontal clearances to be observed between cable ducts and third party services (e.g. gas pipes, water mains, culverts etc.) In the case of high risk 3rd party services, greater clearances must be required. Designers to consult Eirgrid and 3rd party service owners for guidance
15. Steel plates must cover ducts. No overlap is required however standard dimensions may result in an overlap. Spacing of 10mm to be maintained between steel plates to prevent the transfer of stray current.
16. Templates are to be used at 5m intervals during duct installation in CBGM. Pre-made 75mm wide concrete spacers are to be used during duct installation in wet concrete
17. If existing service marker tape is not present, the ESBN yellow marker tape should be installed at maximum 300mm below finished surface level



A = 125mm OUTER DIAMETER HDPE ESB APPROVED DUCT, SDR=17.6  
B = 200mm OUTER DIAMETER HDPE ESB APPROVED DUCT, SDR=21

THAN MIN. DIMENSIONS ABOVE SHALL BE  
CROSSED BY UNDERCROSSING METHOD



# Clonberne Windfarm 220kV Grid Connection

CLIENT

Clonberne Windfarm Limited

## CONSULTANTS

NOTES: -

See General Notes

LEGEND: -

**ISSUE/REVISION**

P1	04.06.24	Issued for Planning
I/R	DATE	DESCRIPTION

PROJECT NUMBER

05-990


SHEET TITLE

### Trench Sections for Crossing Watermain/Wastewater

SHEET NUMBER



05990-DR-129



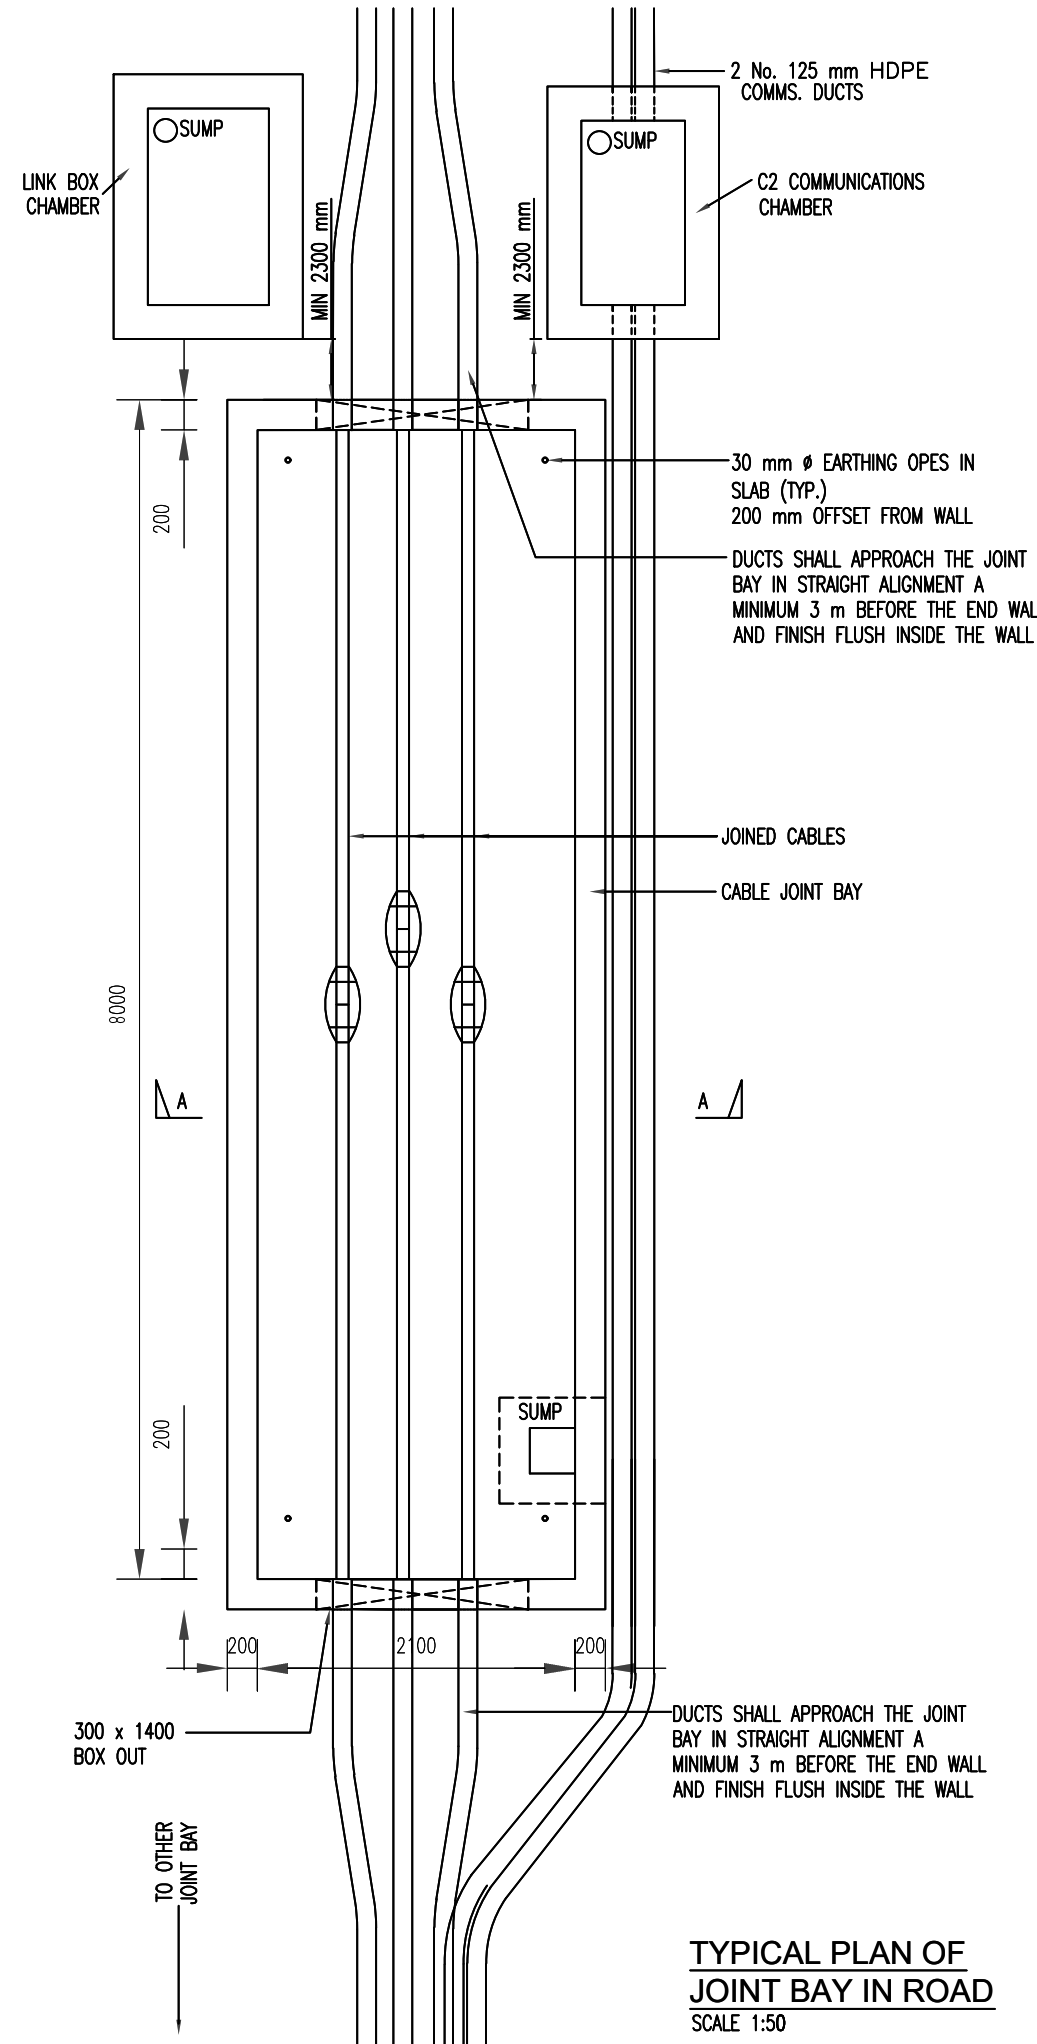

**Note:**

- This drawing is subject to ESB design approval and should not be used for construction.
- This drawing is to be read in conjunction with relevant drawings, specifications and reports.
- Dimensions are in millimeters, unless noted otherwise.
- Drawings are not to be scaled use figured dimensions only.
- The compaction of backfill material around the cables shall be carried out by hand.
- The Contractor shall provide test certificates confirming that the thermal resistivity of the thermal sand is maximum 1.K.m/W.

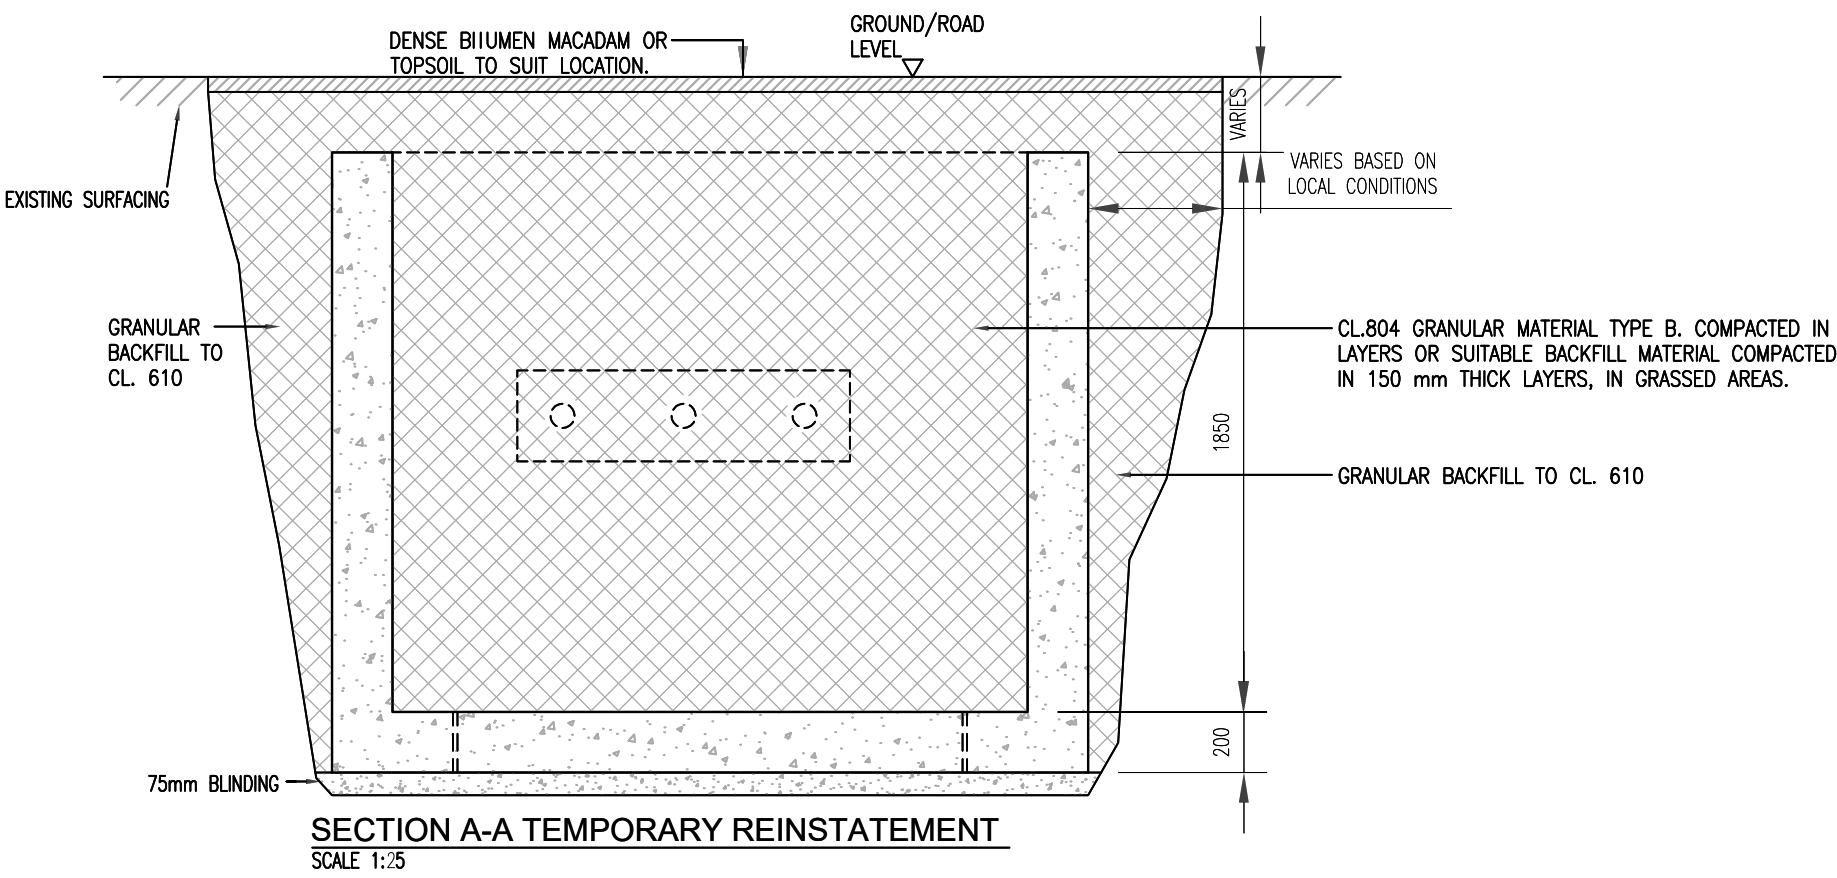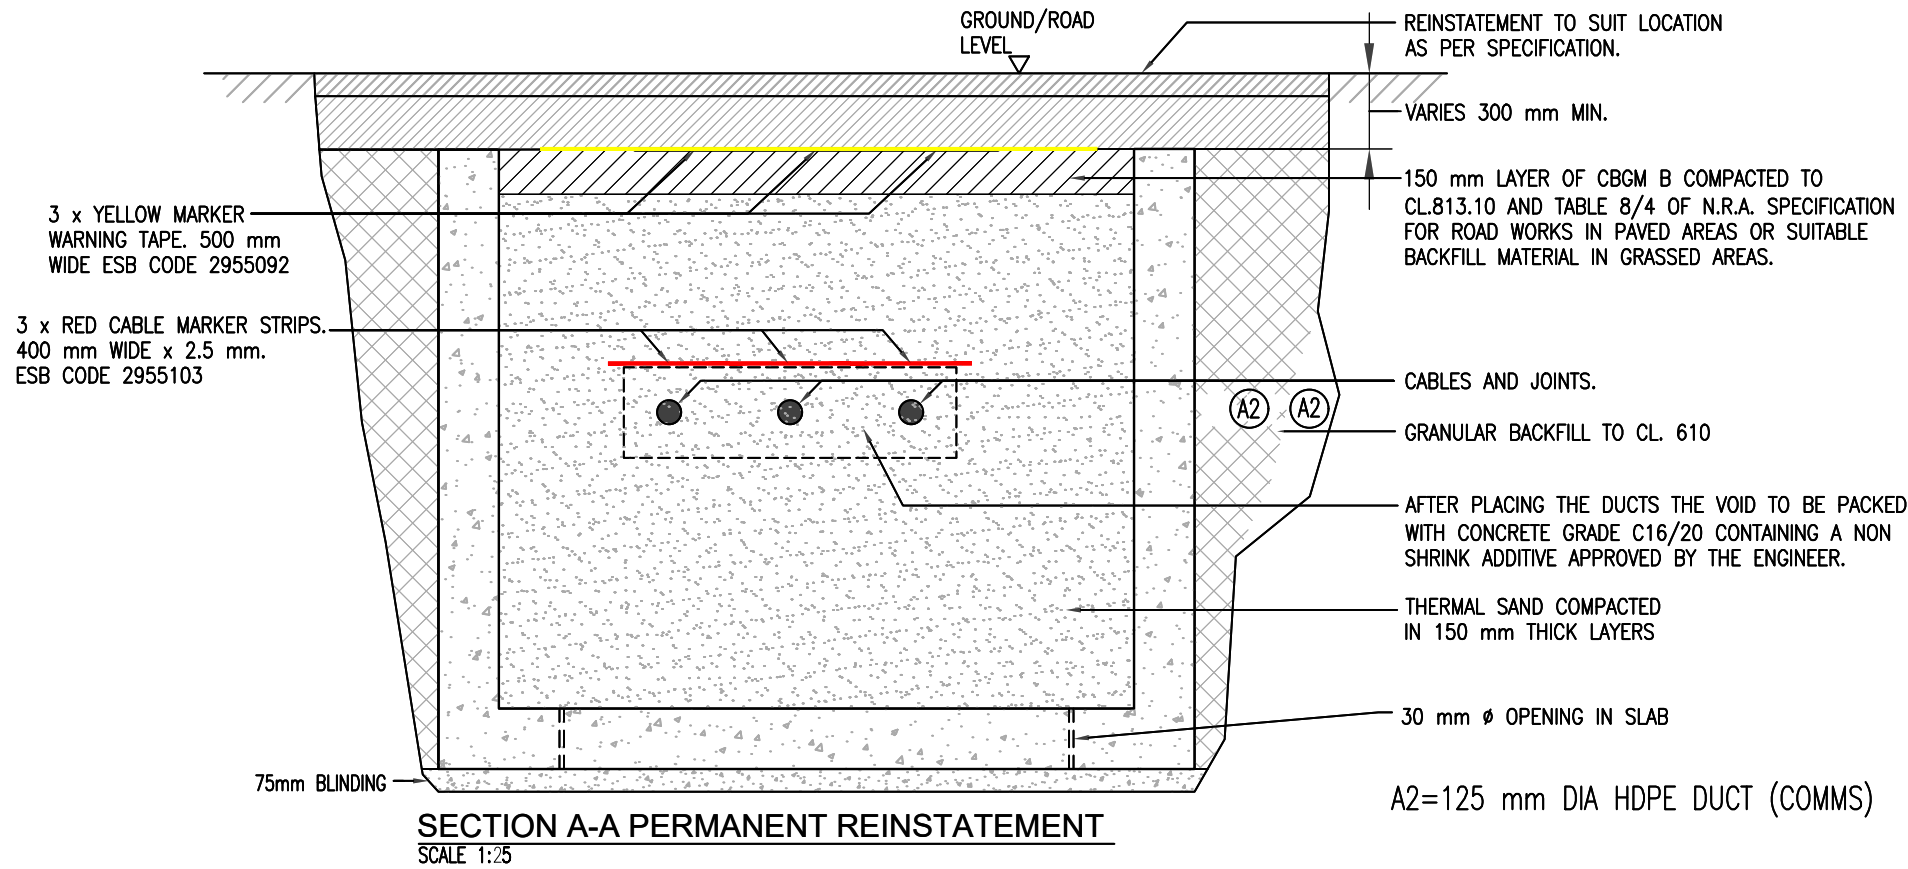

**ALL REINSTATEMENT WORKS ARE TO BE IN ACCORDANCE WITH LOCAL AREA ENGINEERS REQUIREMENTS AND GUIDELINES FOR MANAGING OPENINGS IN PUBLIC ROADS**

PROJECT

Clonberne Wind Farm  
220kV Grid Connection

CLIENT

Clonberne Windfarm Limited

CONSULTANTS

NOTES: -

See General Notes

LEGEND: -

ISSUE/REVISION		
P1	04.06.24	Issued for Planning
I/R	DATE	DESCRIPTION

PROJECT NUMBER

05-990

SHEET TITLE



220kV Joint Bay Section Details

SHEET NUMBER

05990-DR-130

ISO A1 594mm x 841mm

Project Management Initials: Designer: CH Checked: JF Approved: AC

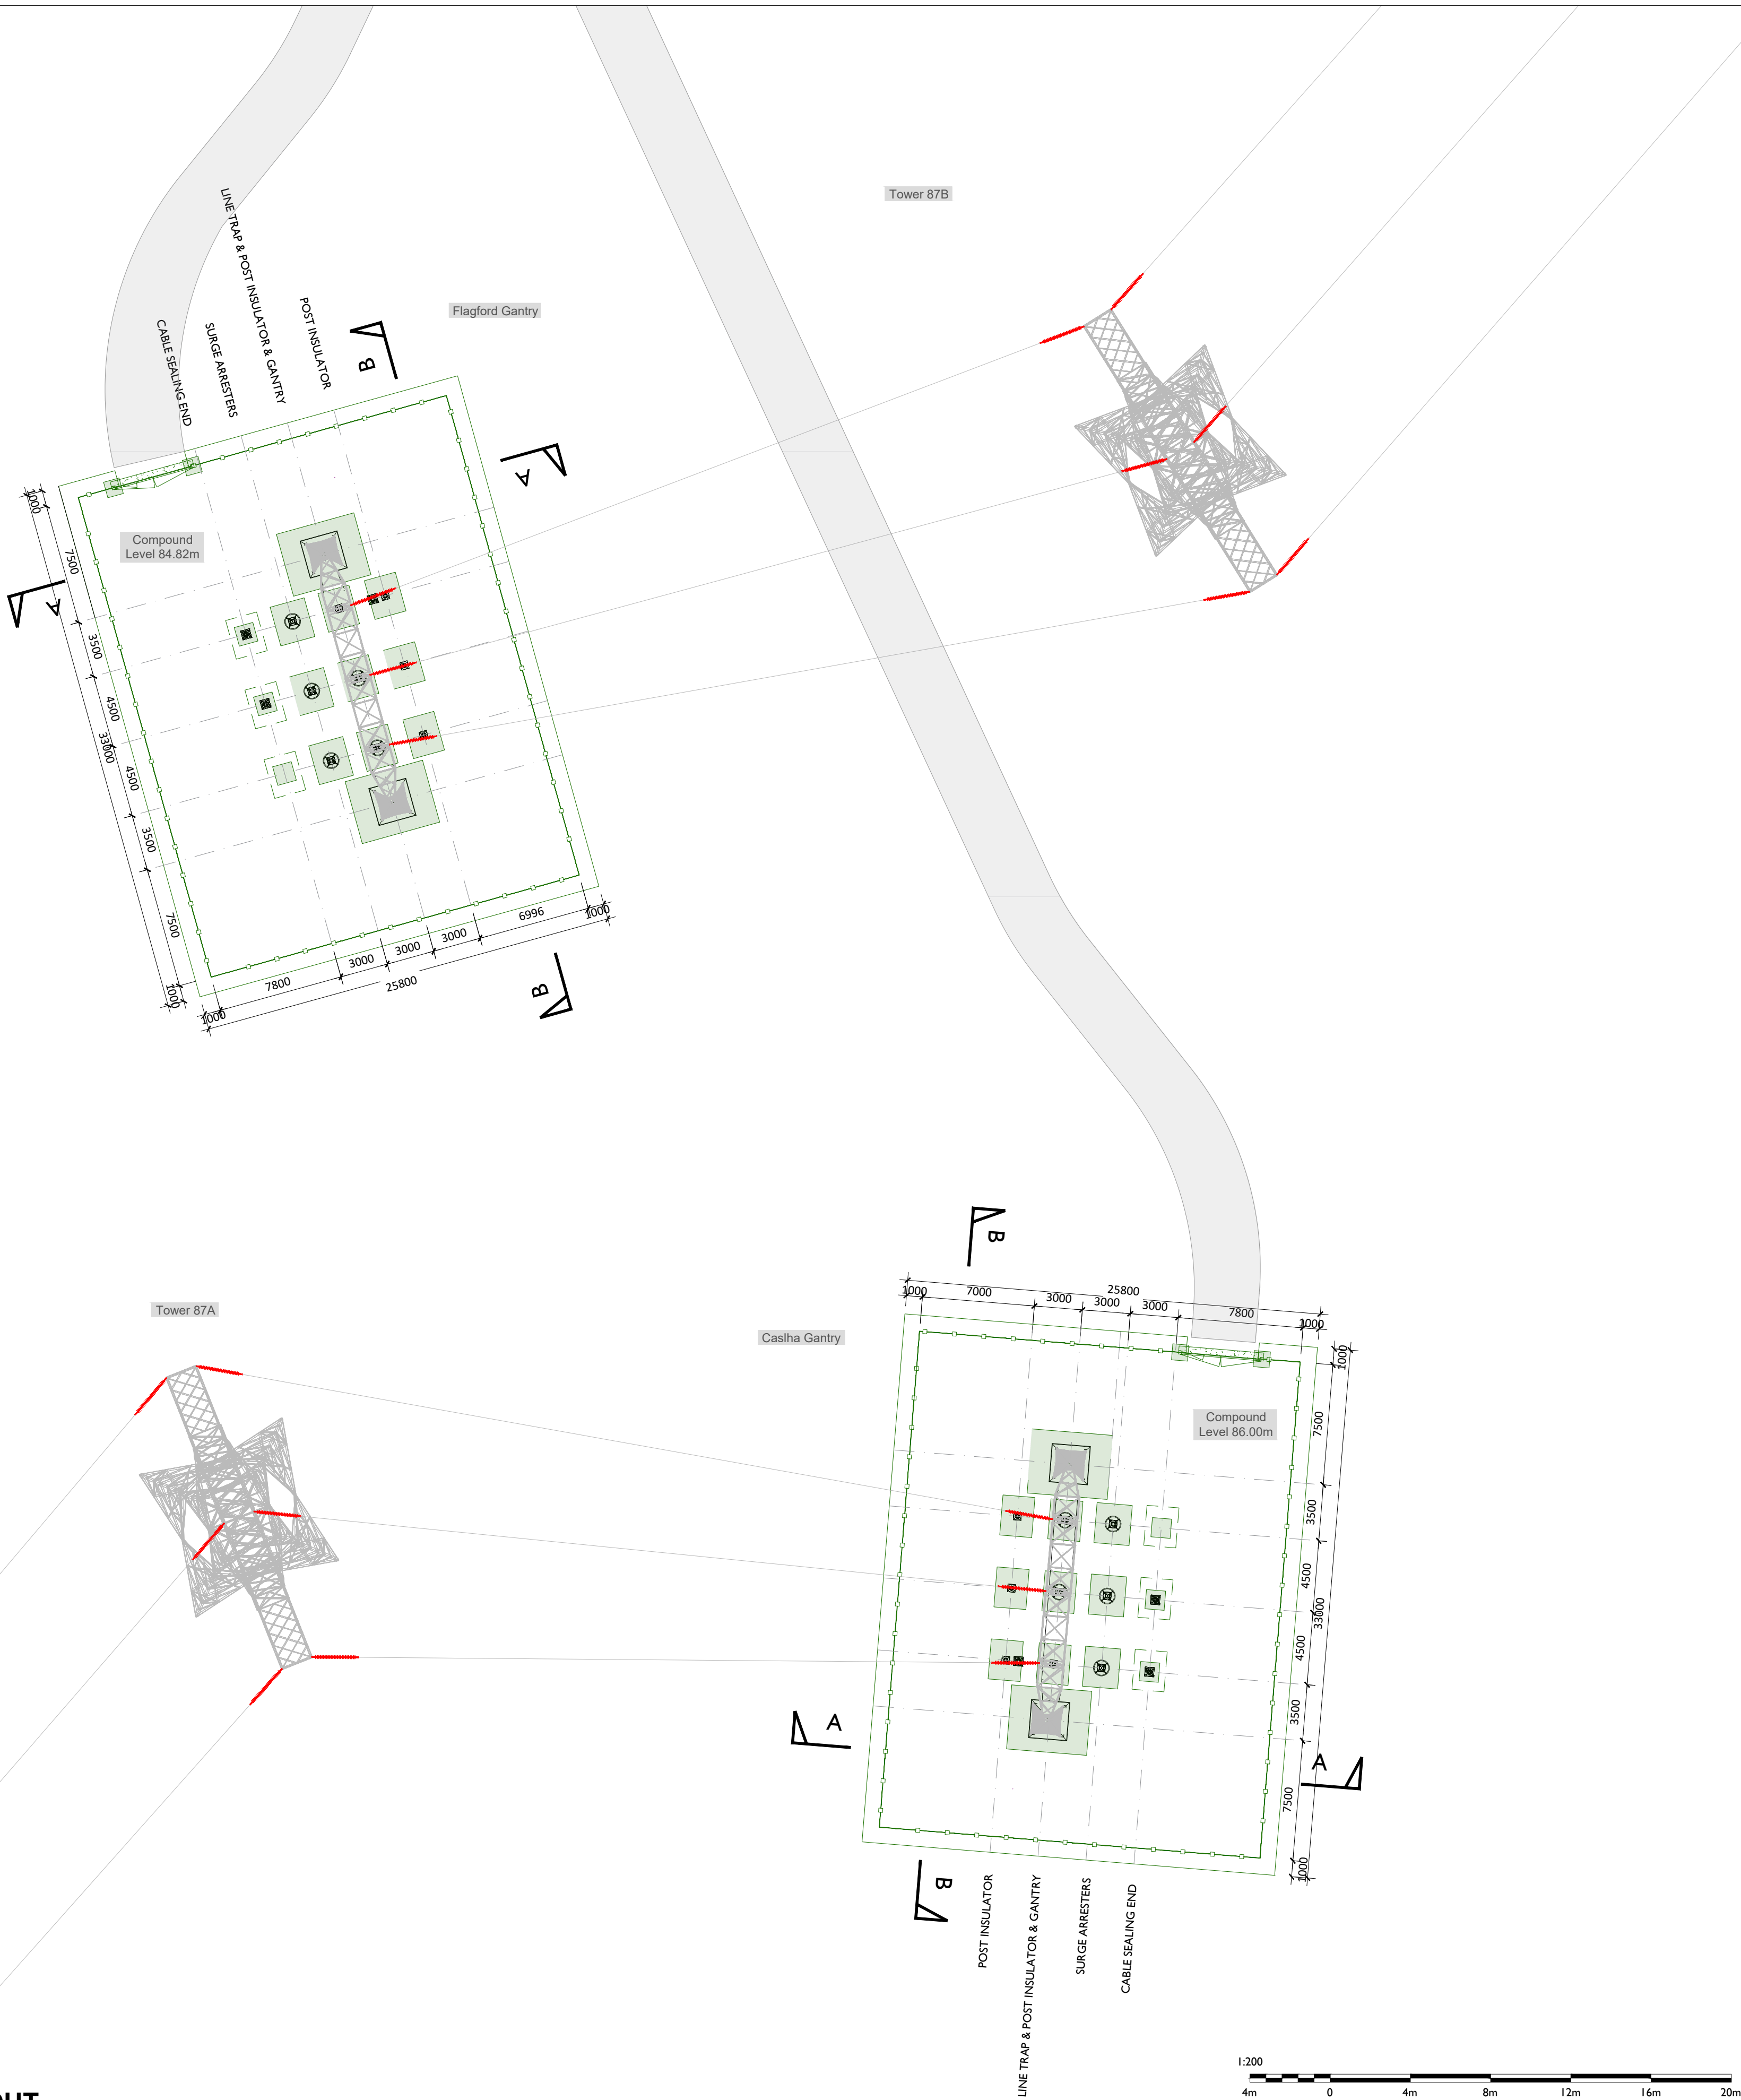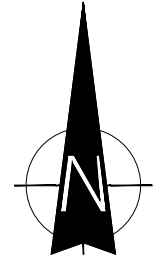

**CABLE COMPOUND - PLAN LAYOUT**

Scale : 1:200



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PROJECT

Clonberne Wind Farm  
220kV Grid Connection

CLIENT

Clonberne Windfarm Limited

CONSULTANTS

NOTES: -

- This drawing is to be read in conjunction with relevant engineering drawings, specifications and reports
- Dimensions are in millimeters, unless noted otherwise
- Drawings are not to be scaled use figured dimensions only

LEGEND: -

- Proposed works shown thus
- Proposed Palisade Fencing
- Proposed Access Road

ISSUE/REVISION

P1	04.06.24	Issued for Planning
I/R	DATE	DESCRIPTION

PROJECT NUMBER

05-990


SHEET TITLE

Cable Compound Layout Details


SHEET NUMBER

05990-DR-131




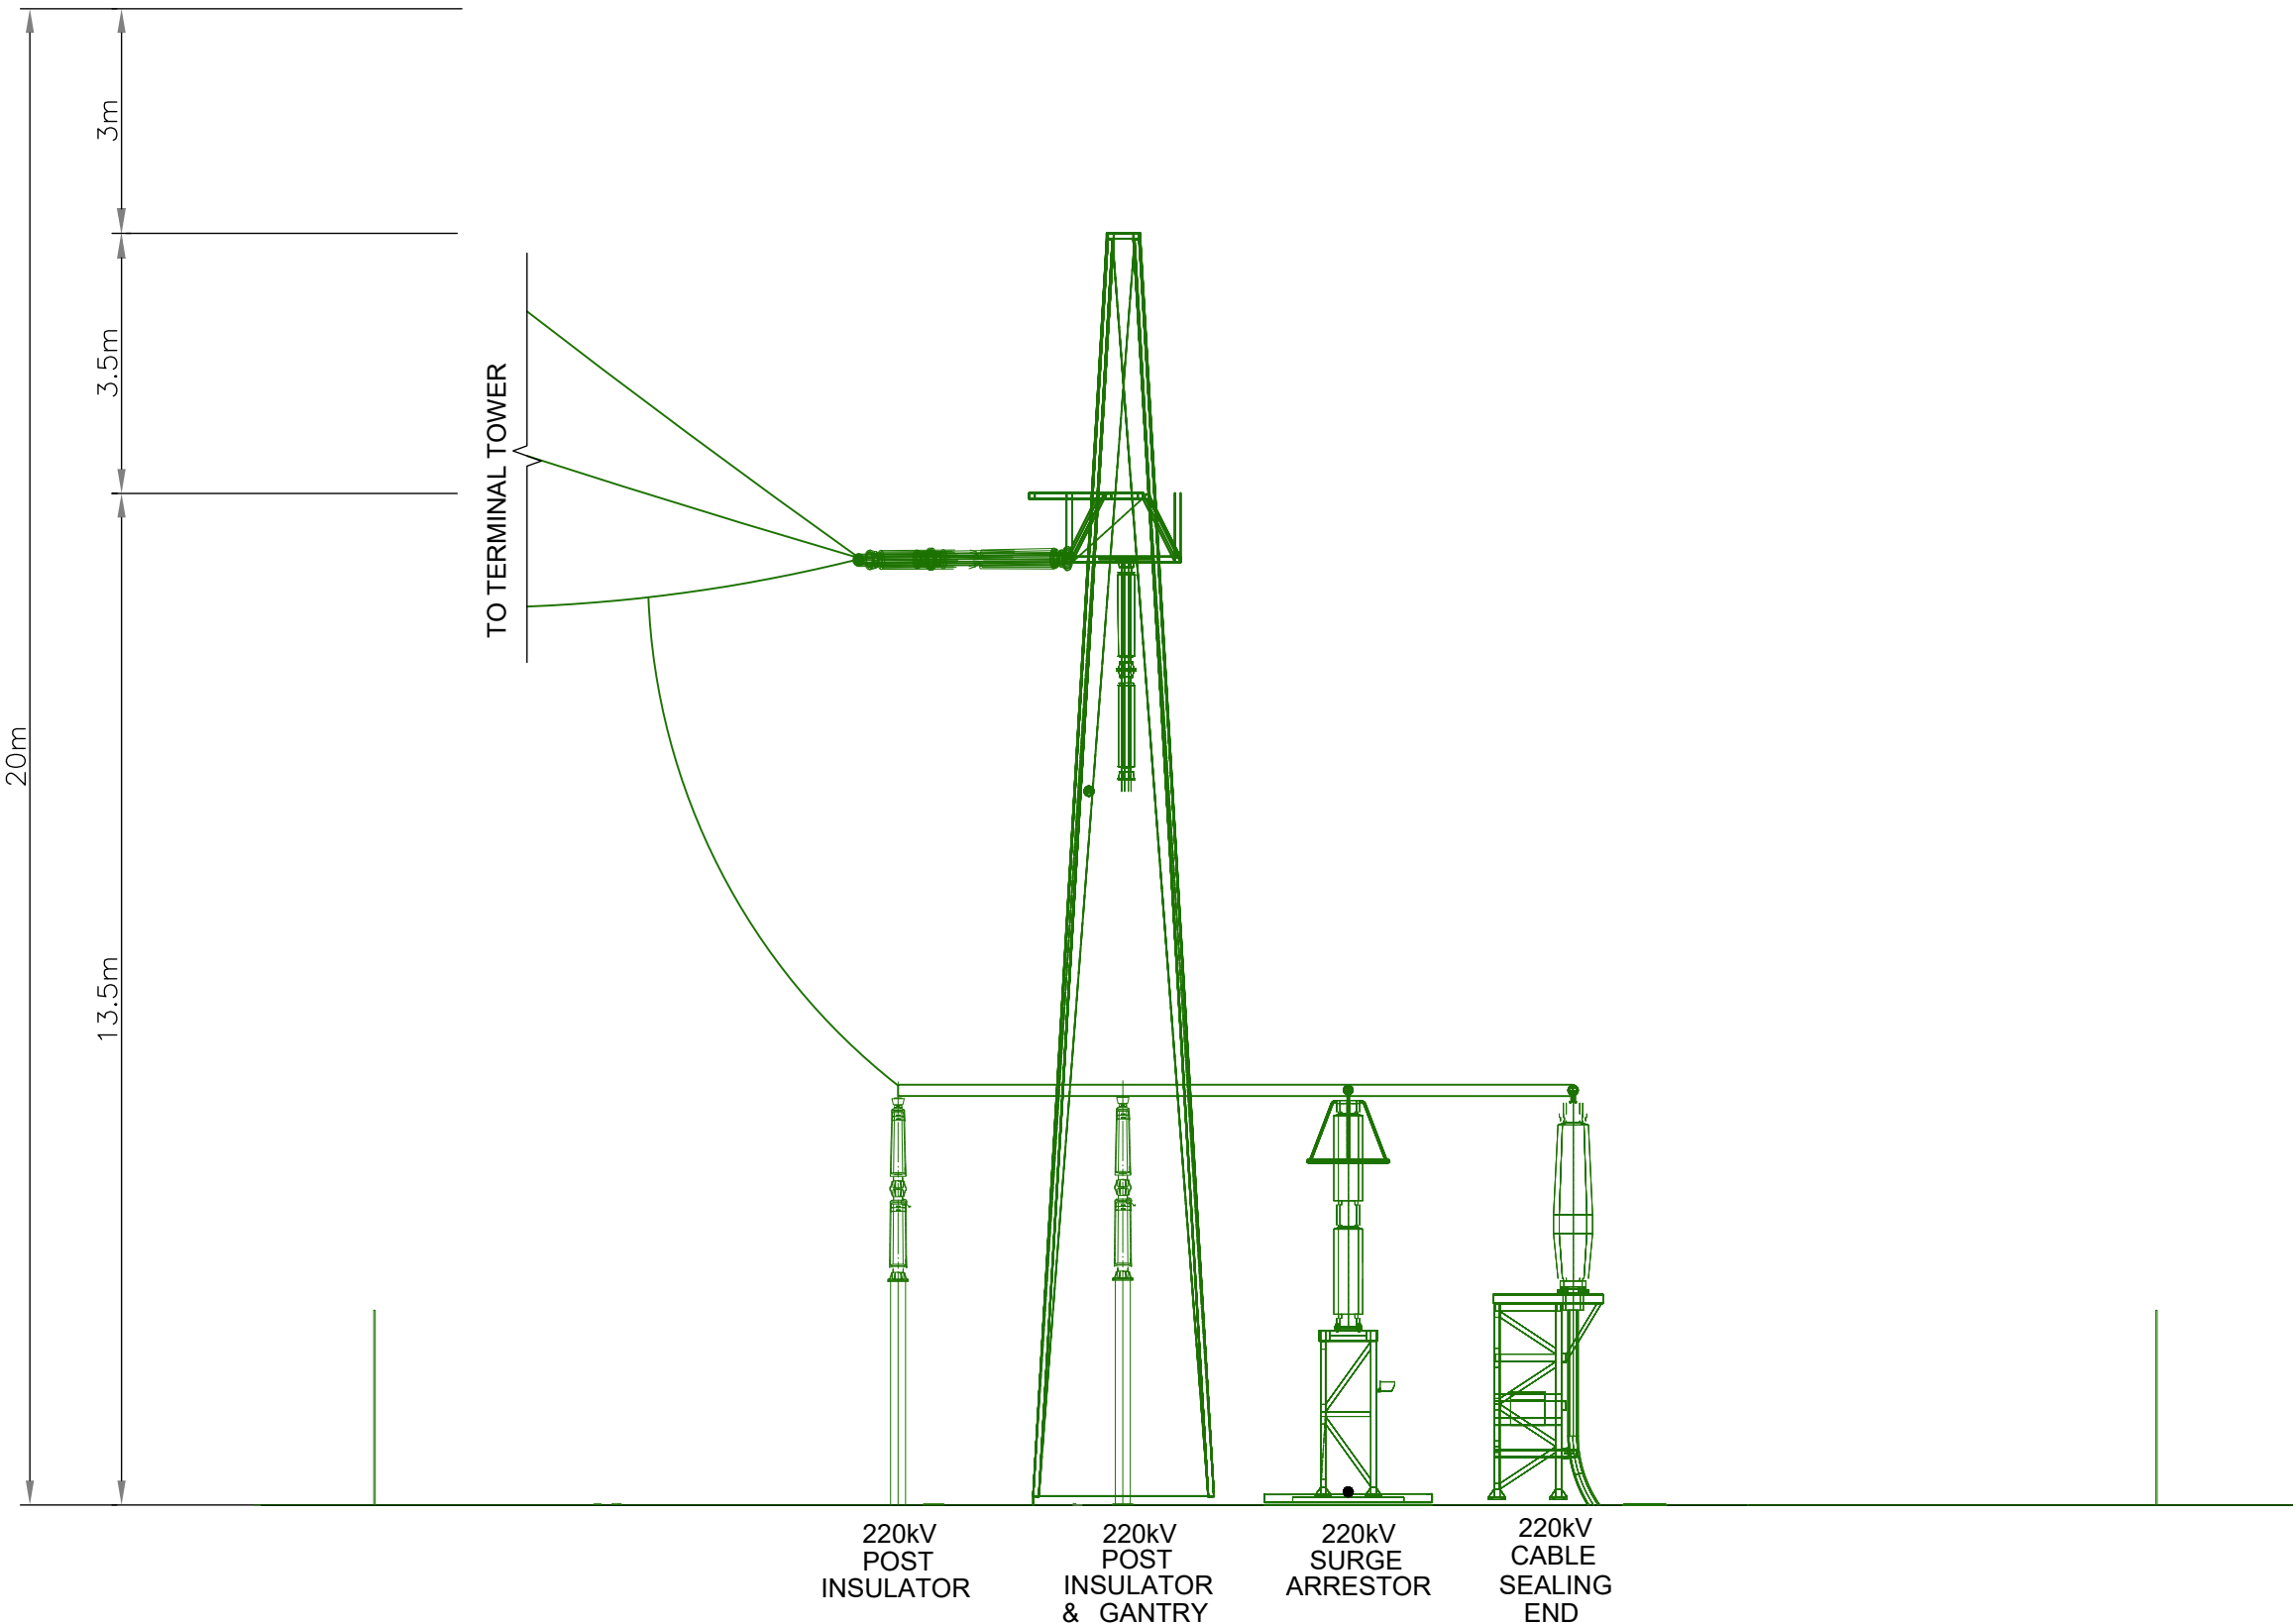

SECTION A-A  
Scale : 1:100

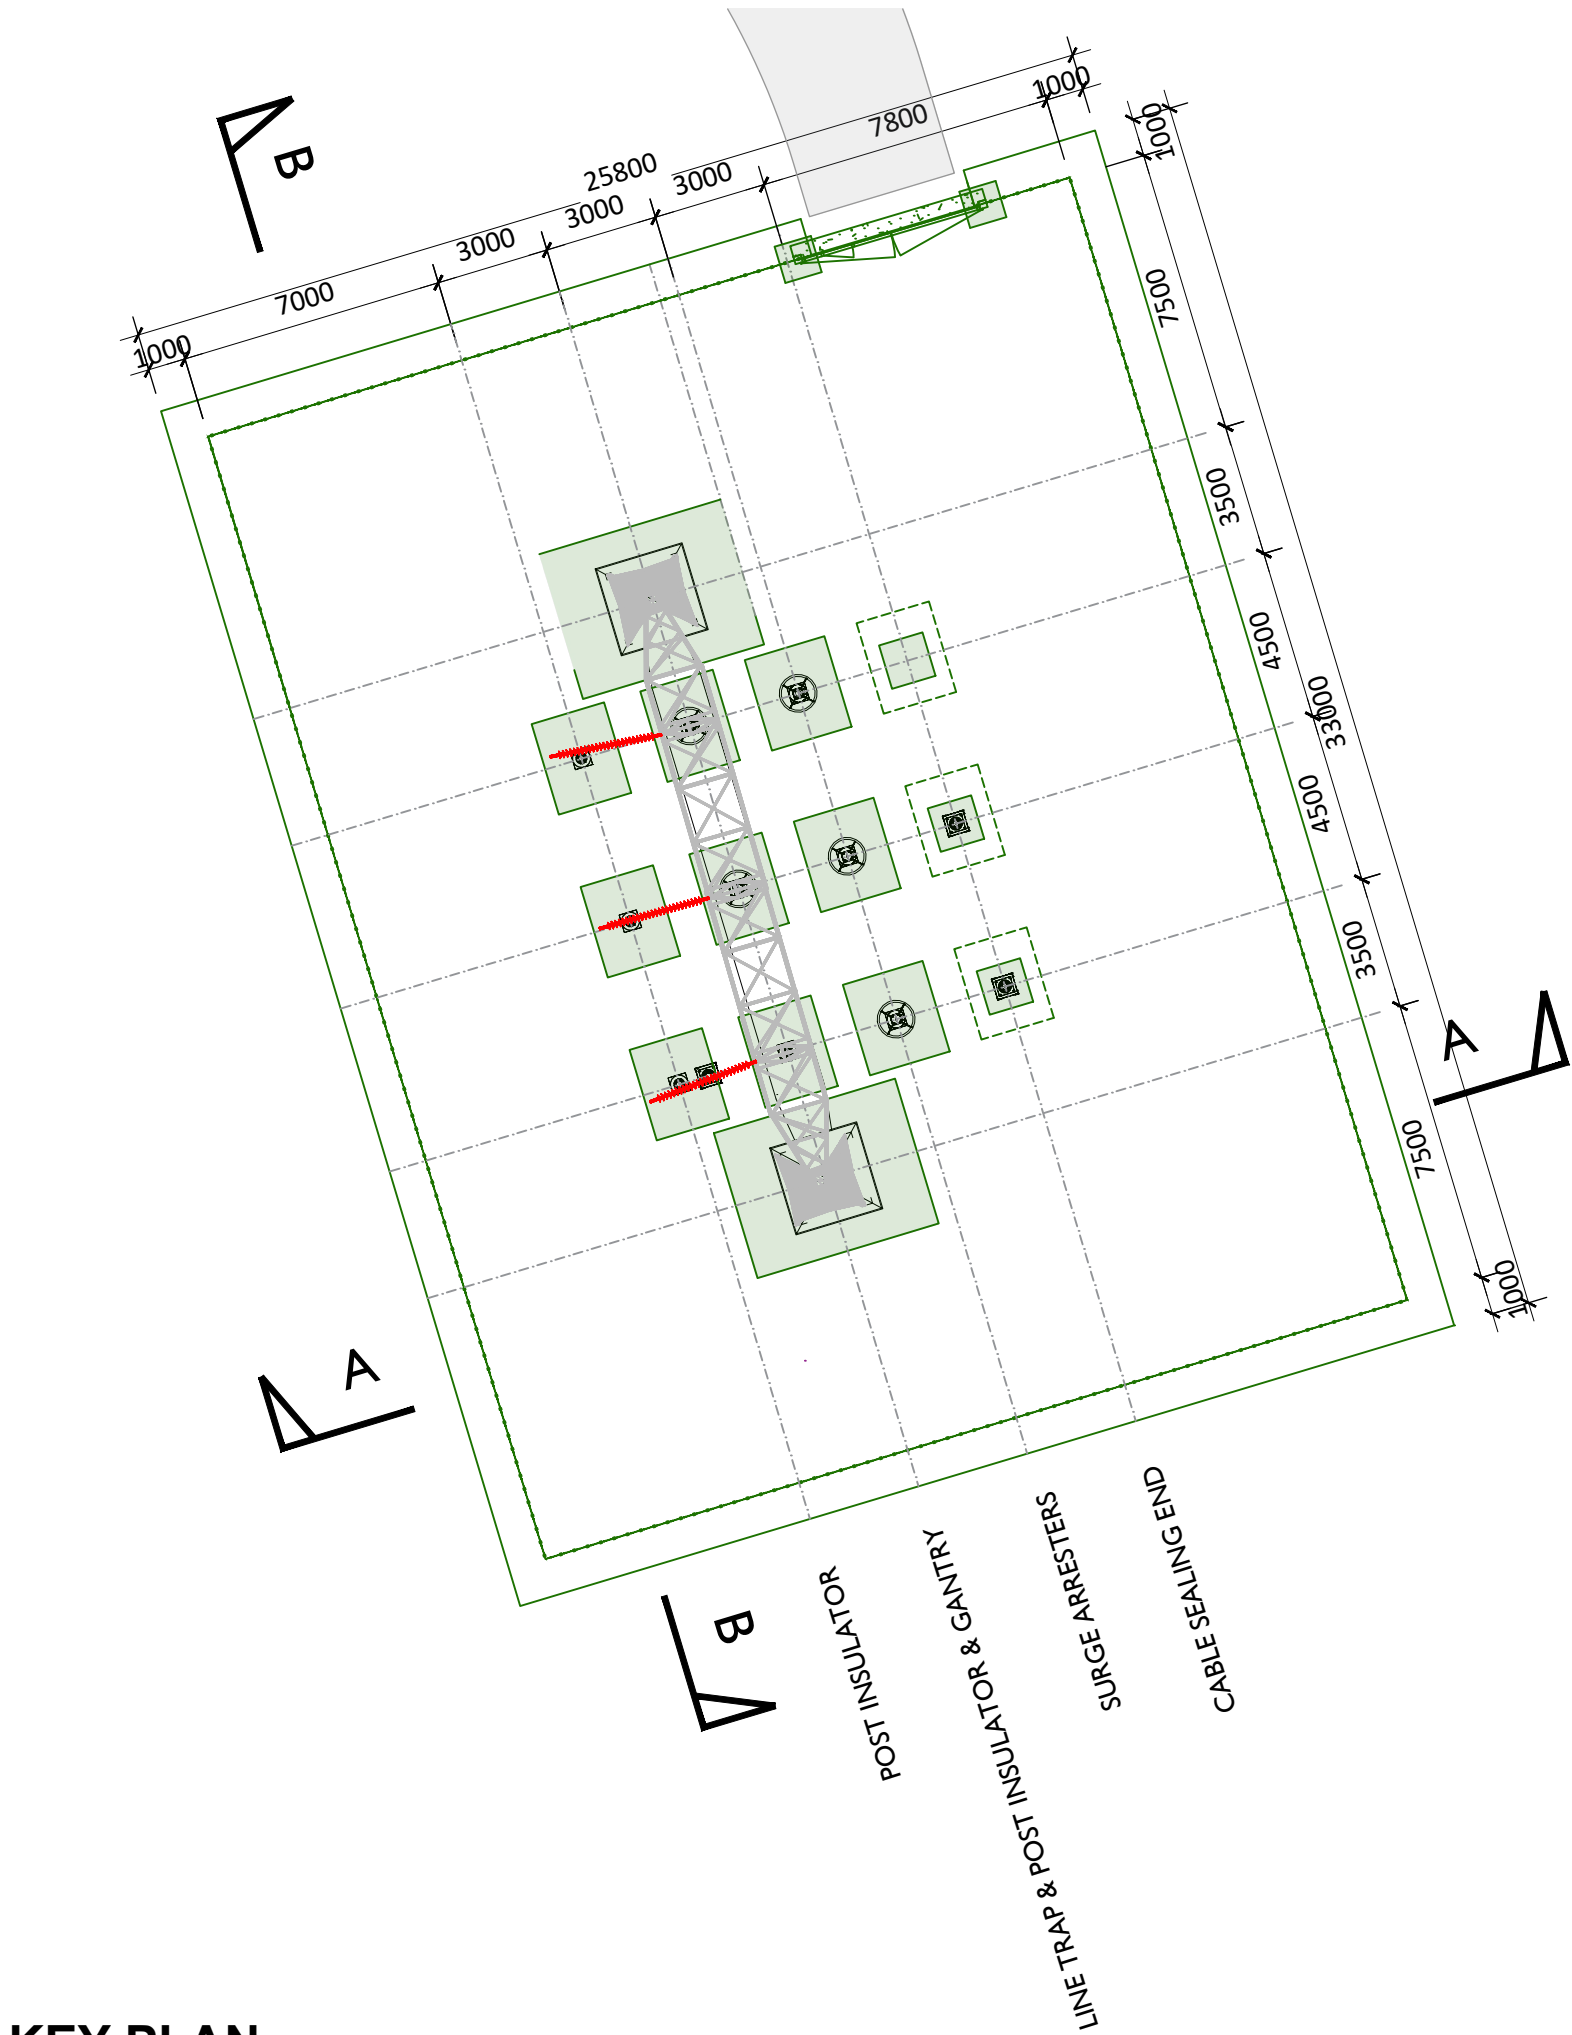

KEY PLAN  
Scale : 1:200

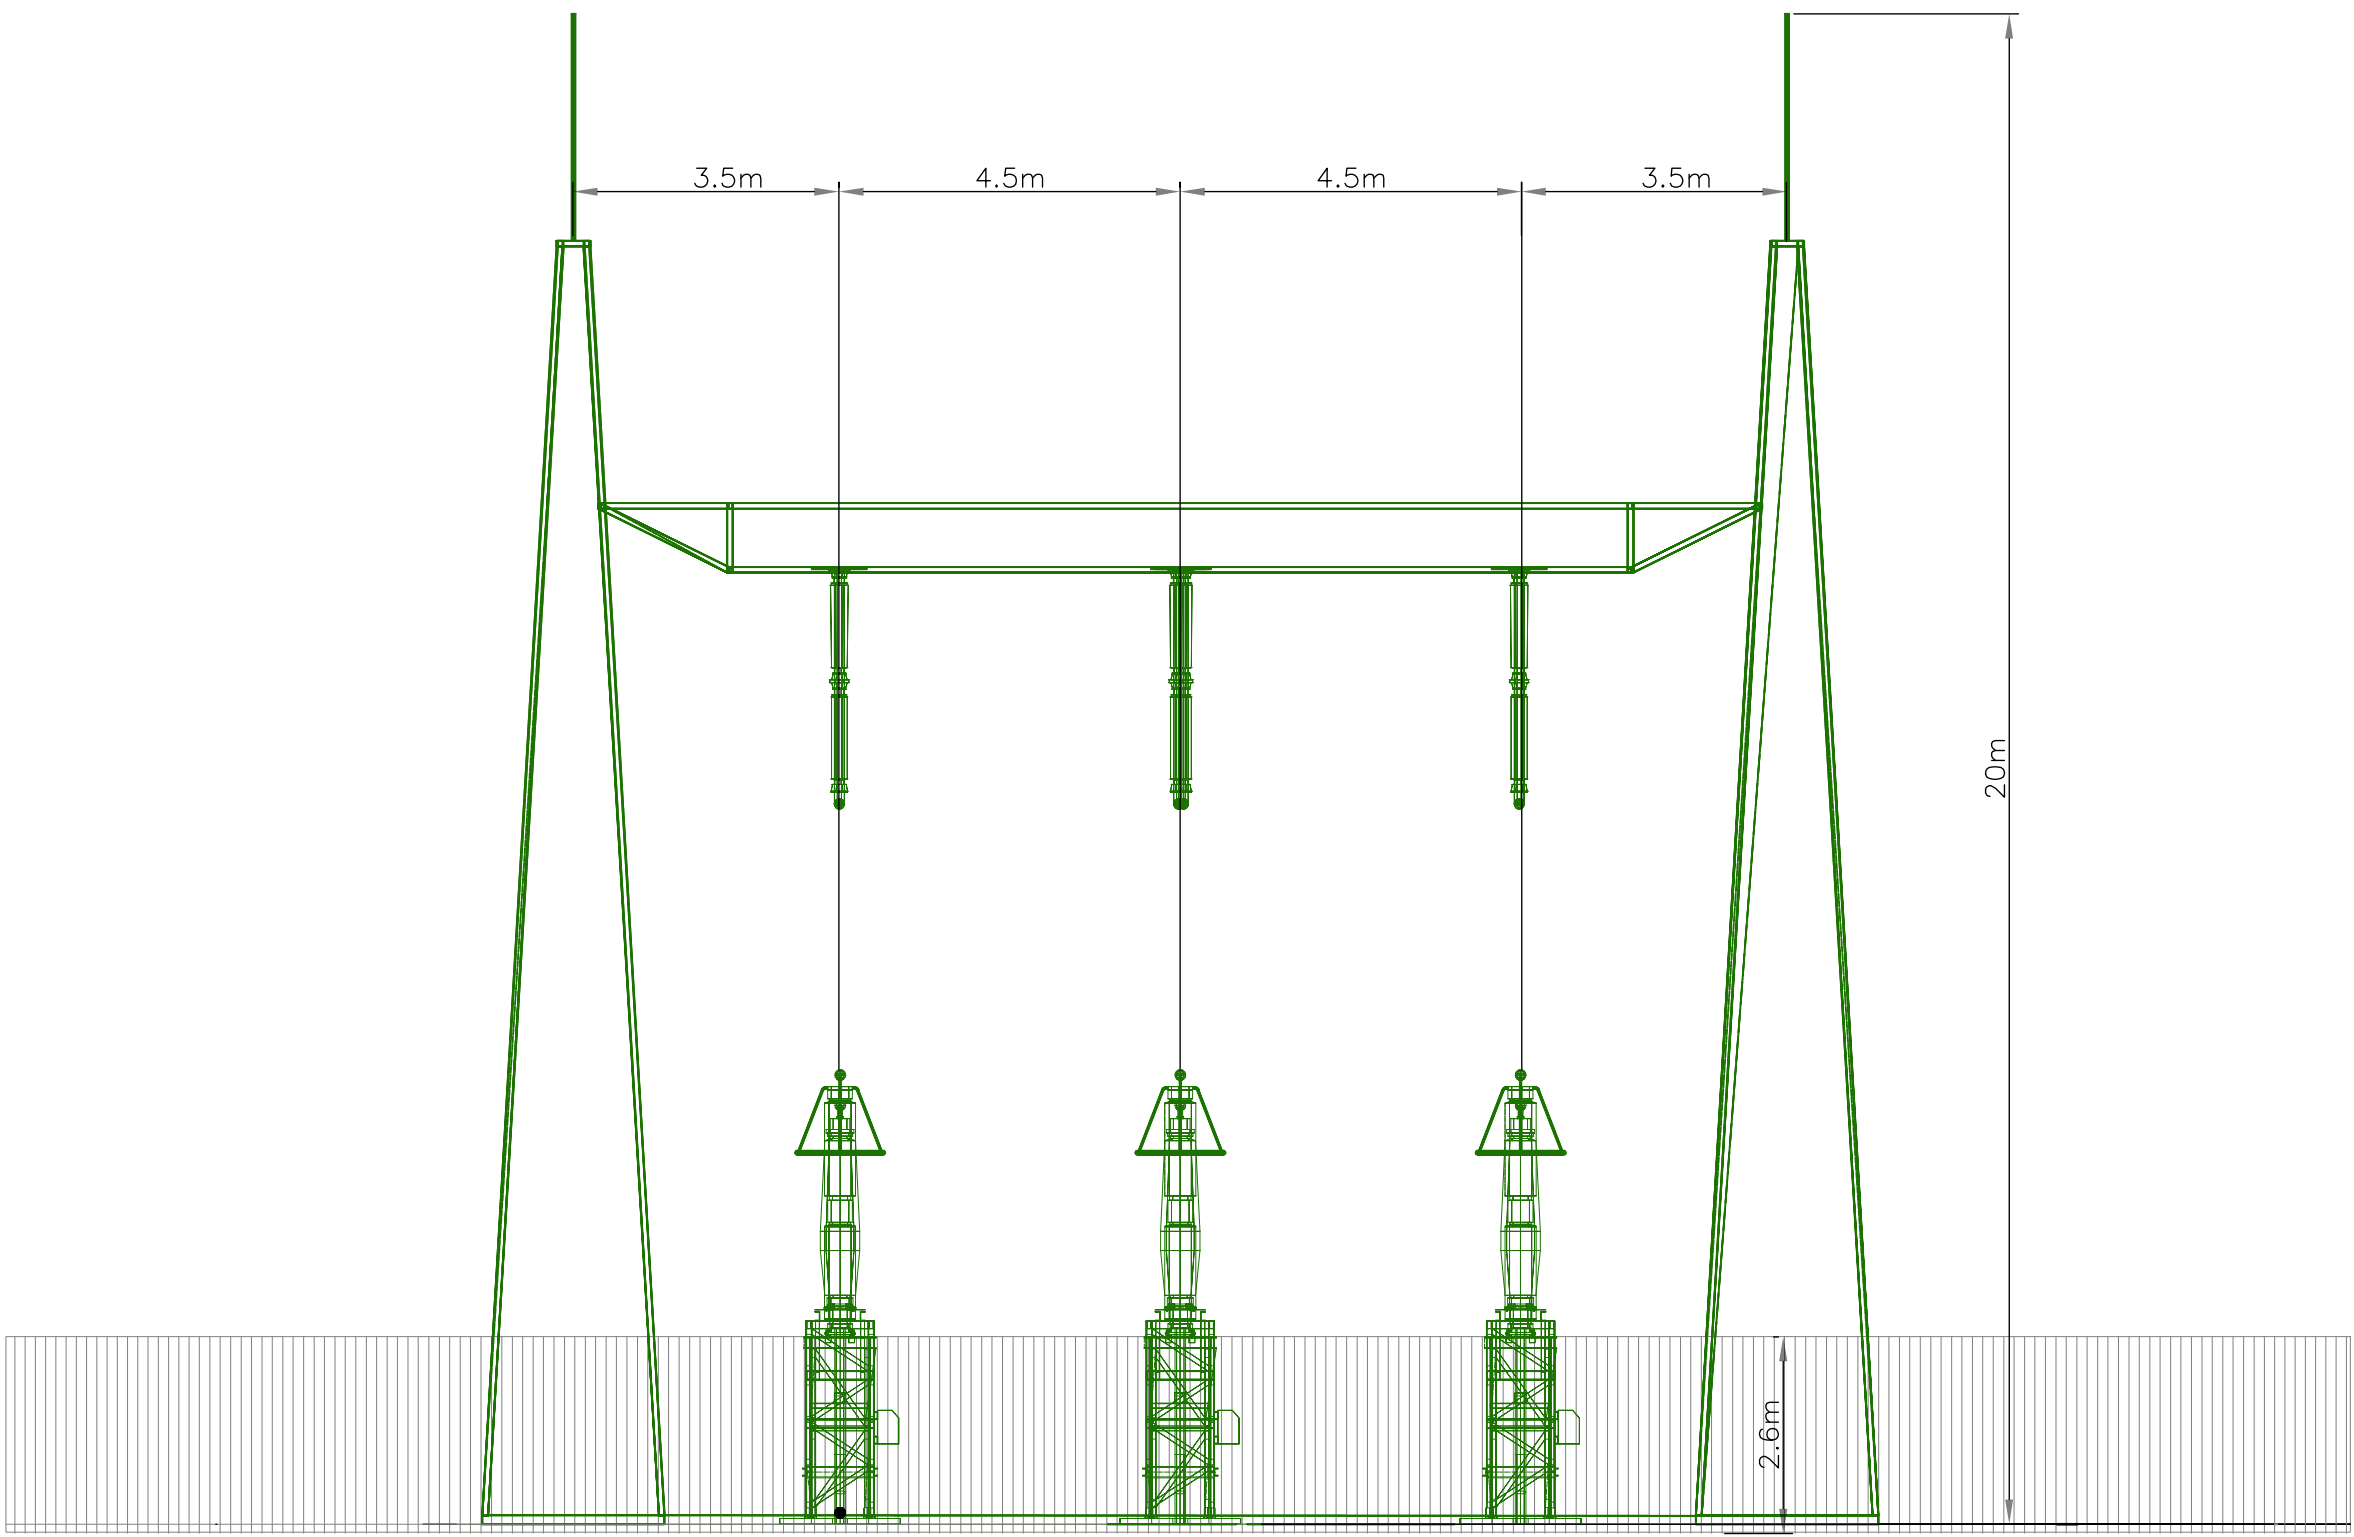

SECTION B-B  
Scale : 1:100

PROJECT

Clonberne Wind Farm  
220kV Grid Connection

CLIENT

Clonberne Windfarm Limited

CONSULTANTS

- NOTES: -
- This drawing is to be read in conjunction with relevant engineering drawings, specifications and reports
  - Dimensions are in millimeters, unless noted otherwise
  - Drawings are not to be scaled use figured dimensions only

LEGEND: -

Proposed works shown thus

ISSUE/REVISION		
P1	04.06.24	Issued for Planning
I/R	DATE	DESCRIPTION

PROJECT NUMBER

05-990

SHEET TITLE

Cable Compound Section



SHEET NUMBER

05990-DR-132



ISO A1 594mm x 841mm

Project Management Initials: Designer: CH Checked: JF Approved: AC

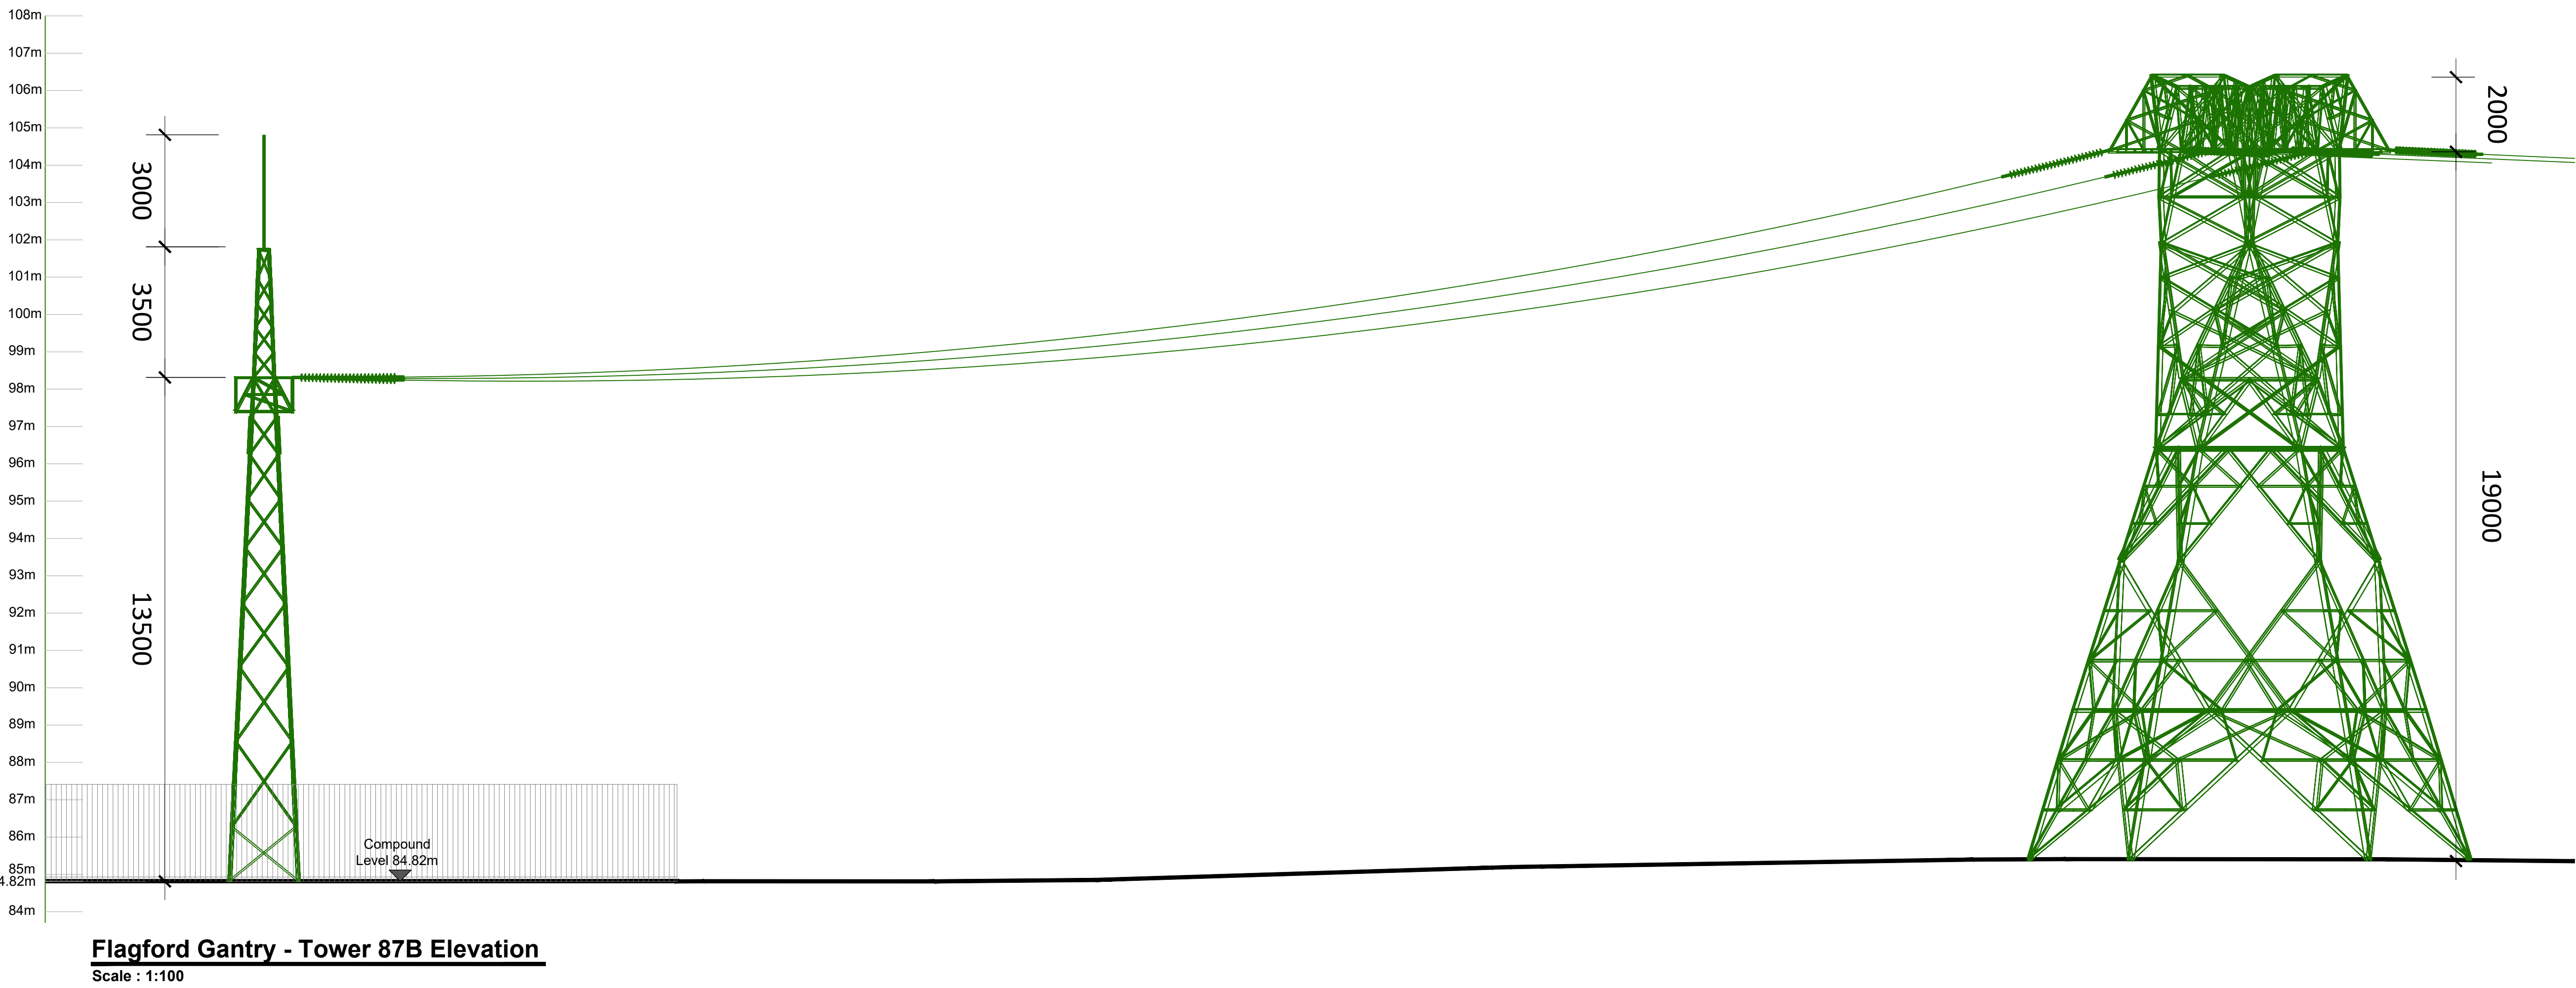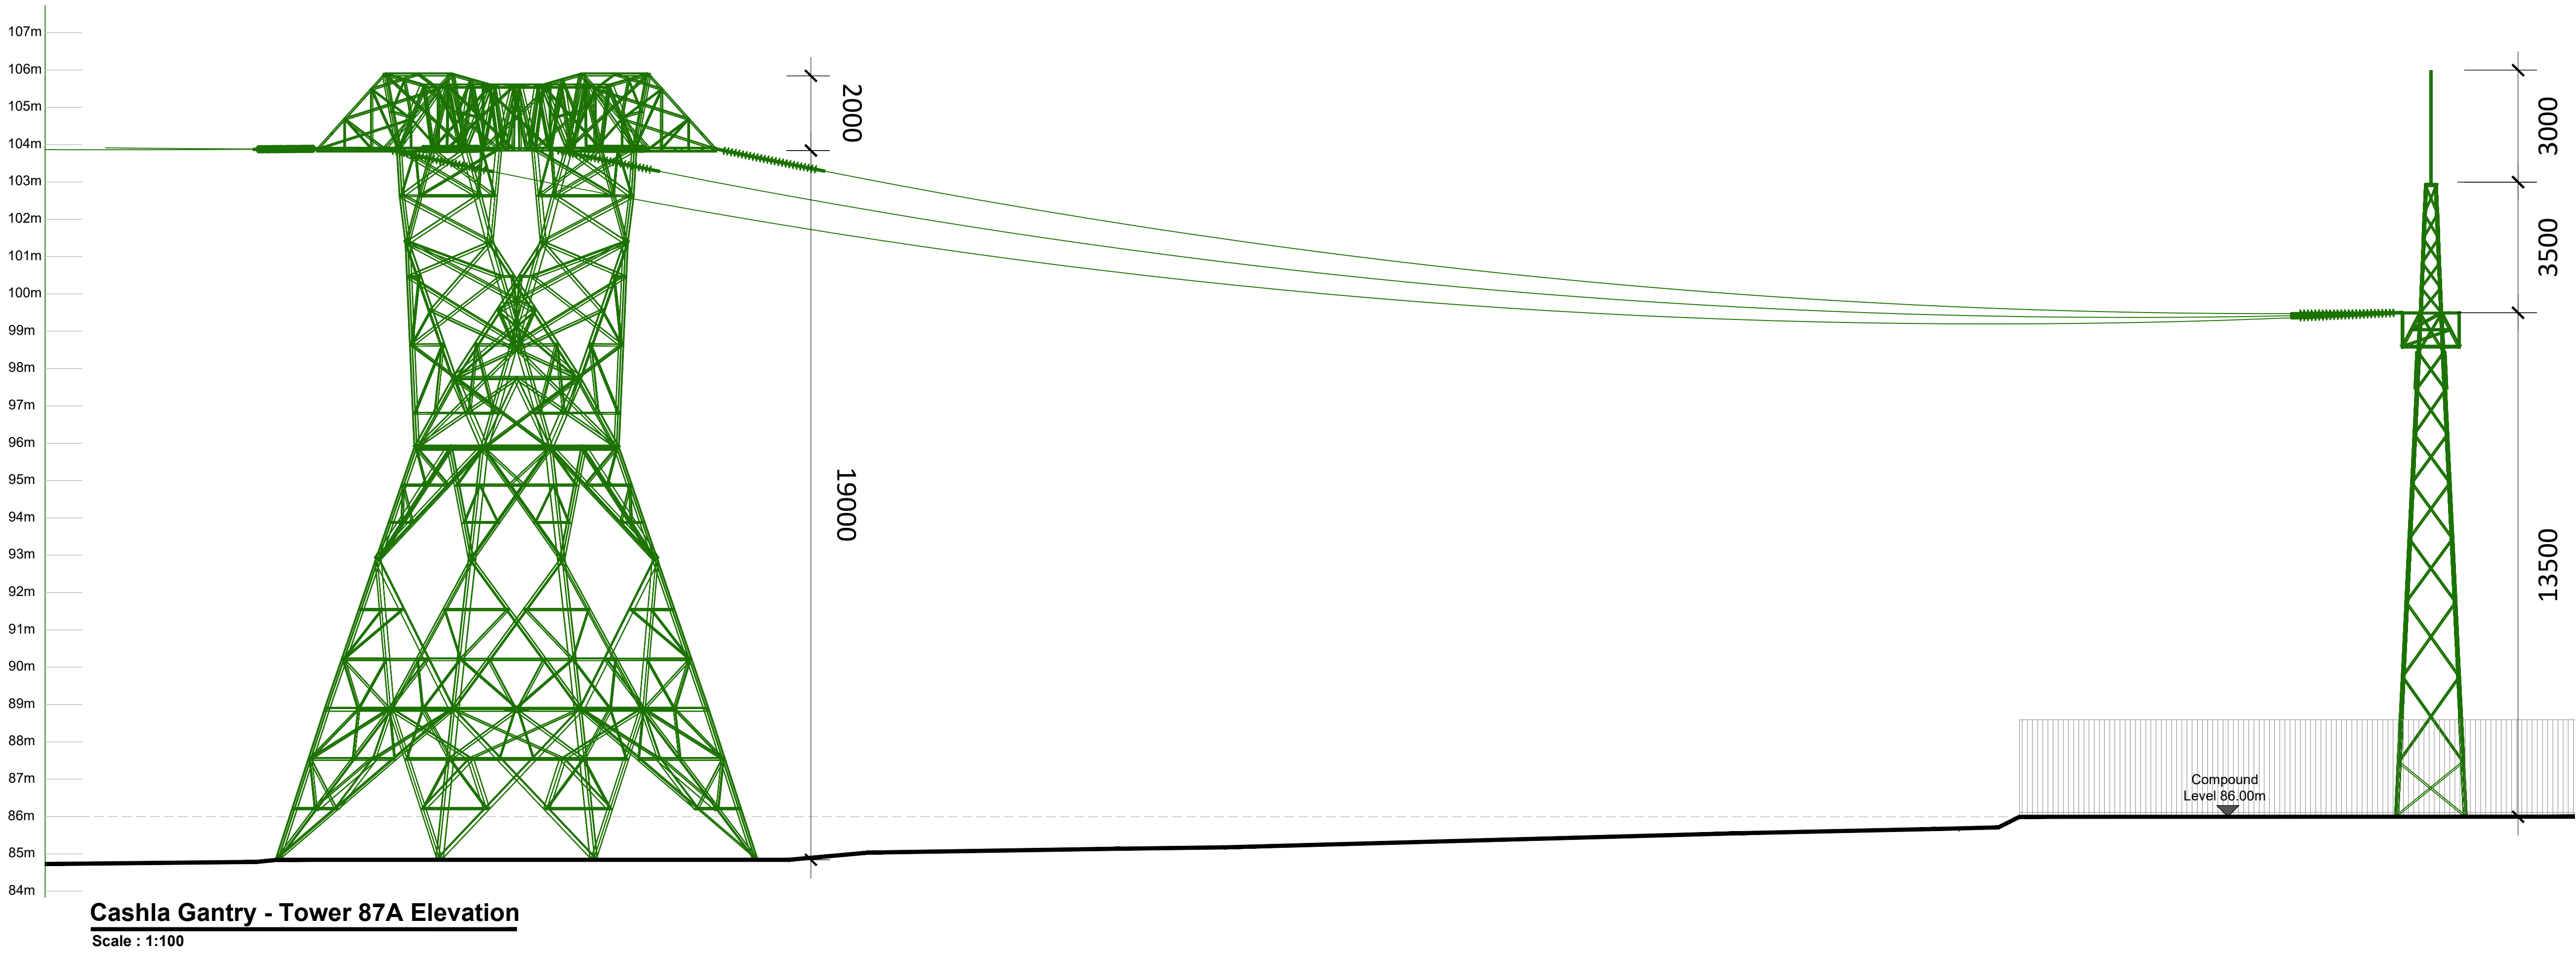



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PROJECT

Clonberne Wind Farm  
220kV Grid Connection


CLIENT

Clonberne Windfarm Limited

CONSULTANTS

- NOTES: -
- This drawing is to be read in conjunction with relevant engineering drawings, specifications and reports
  - Dimensions are in millimeters, unless noted otherwise
  - Drawings are not to be scaled use figured dimensions only

LEGEND: -

Proposed works shown thus 

ISSUE/REVISION		
P1	04.06.24	Issued for Planning
I/R	DATE	DESCRIPTION

PROJECT NUMBER


05-990

SHEET TITLE

Compound Gantry-Tower Elevations

SHEET NUMBER


05990-DR-133

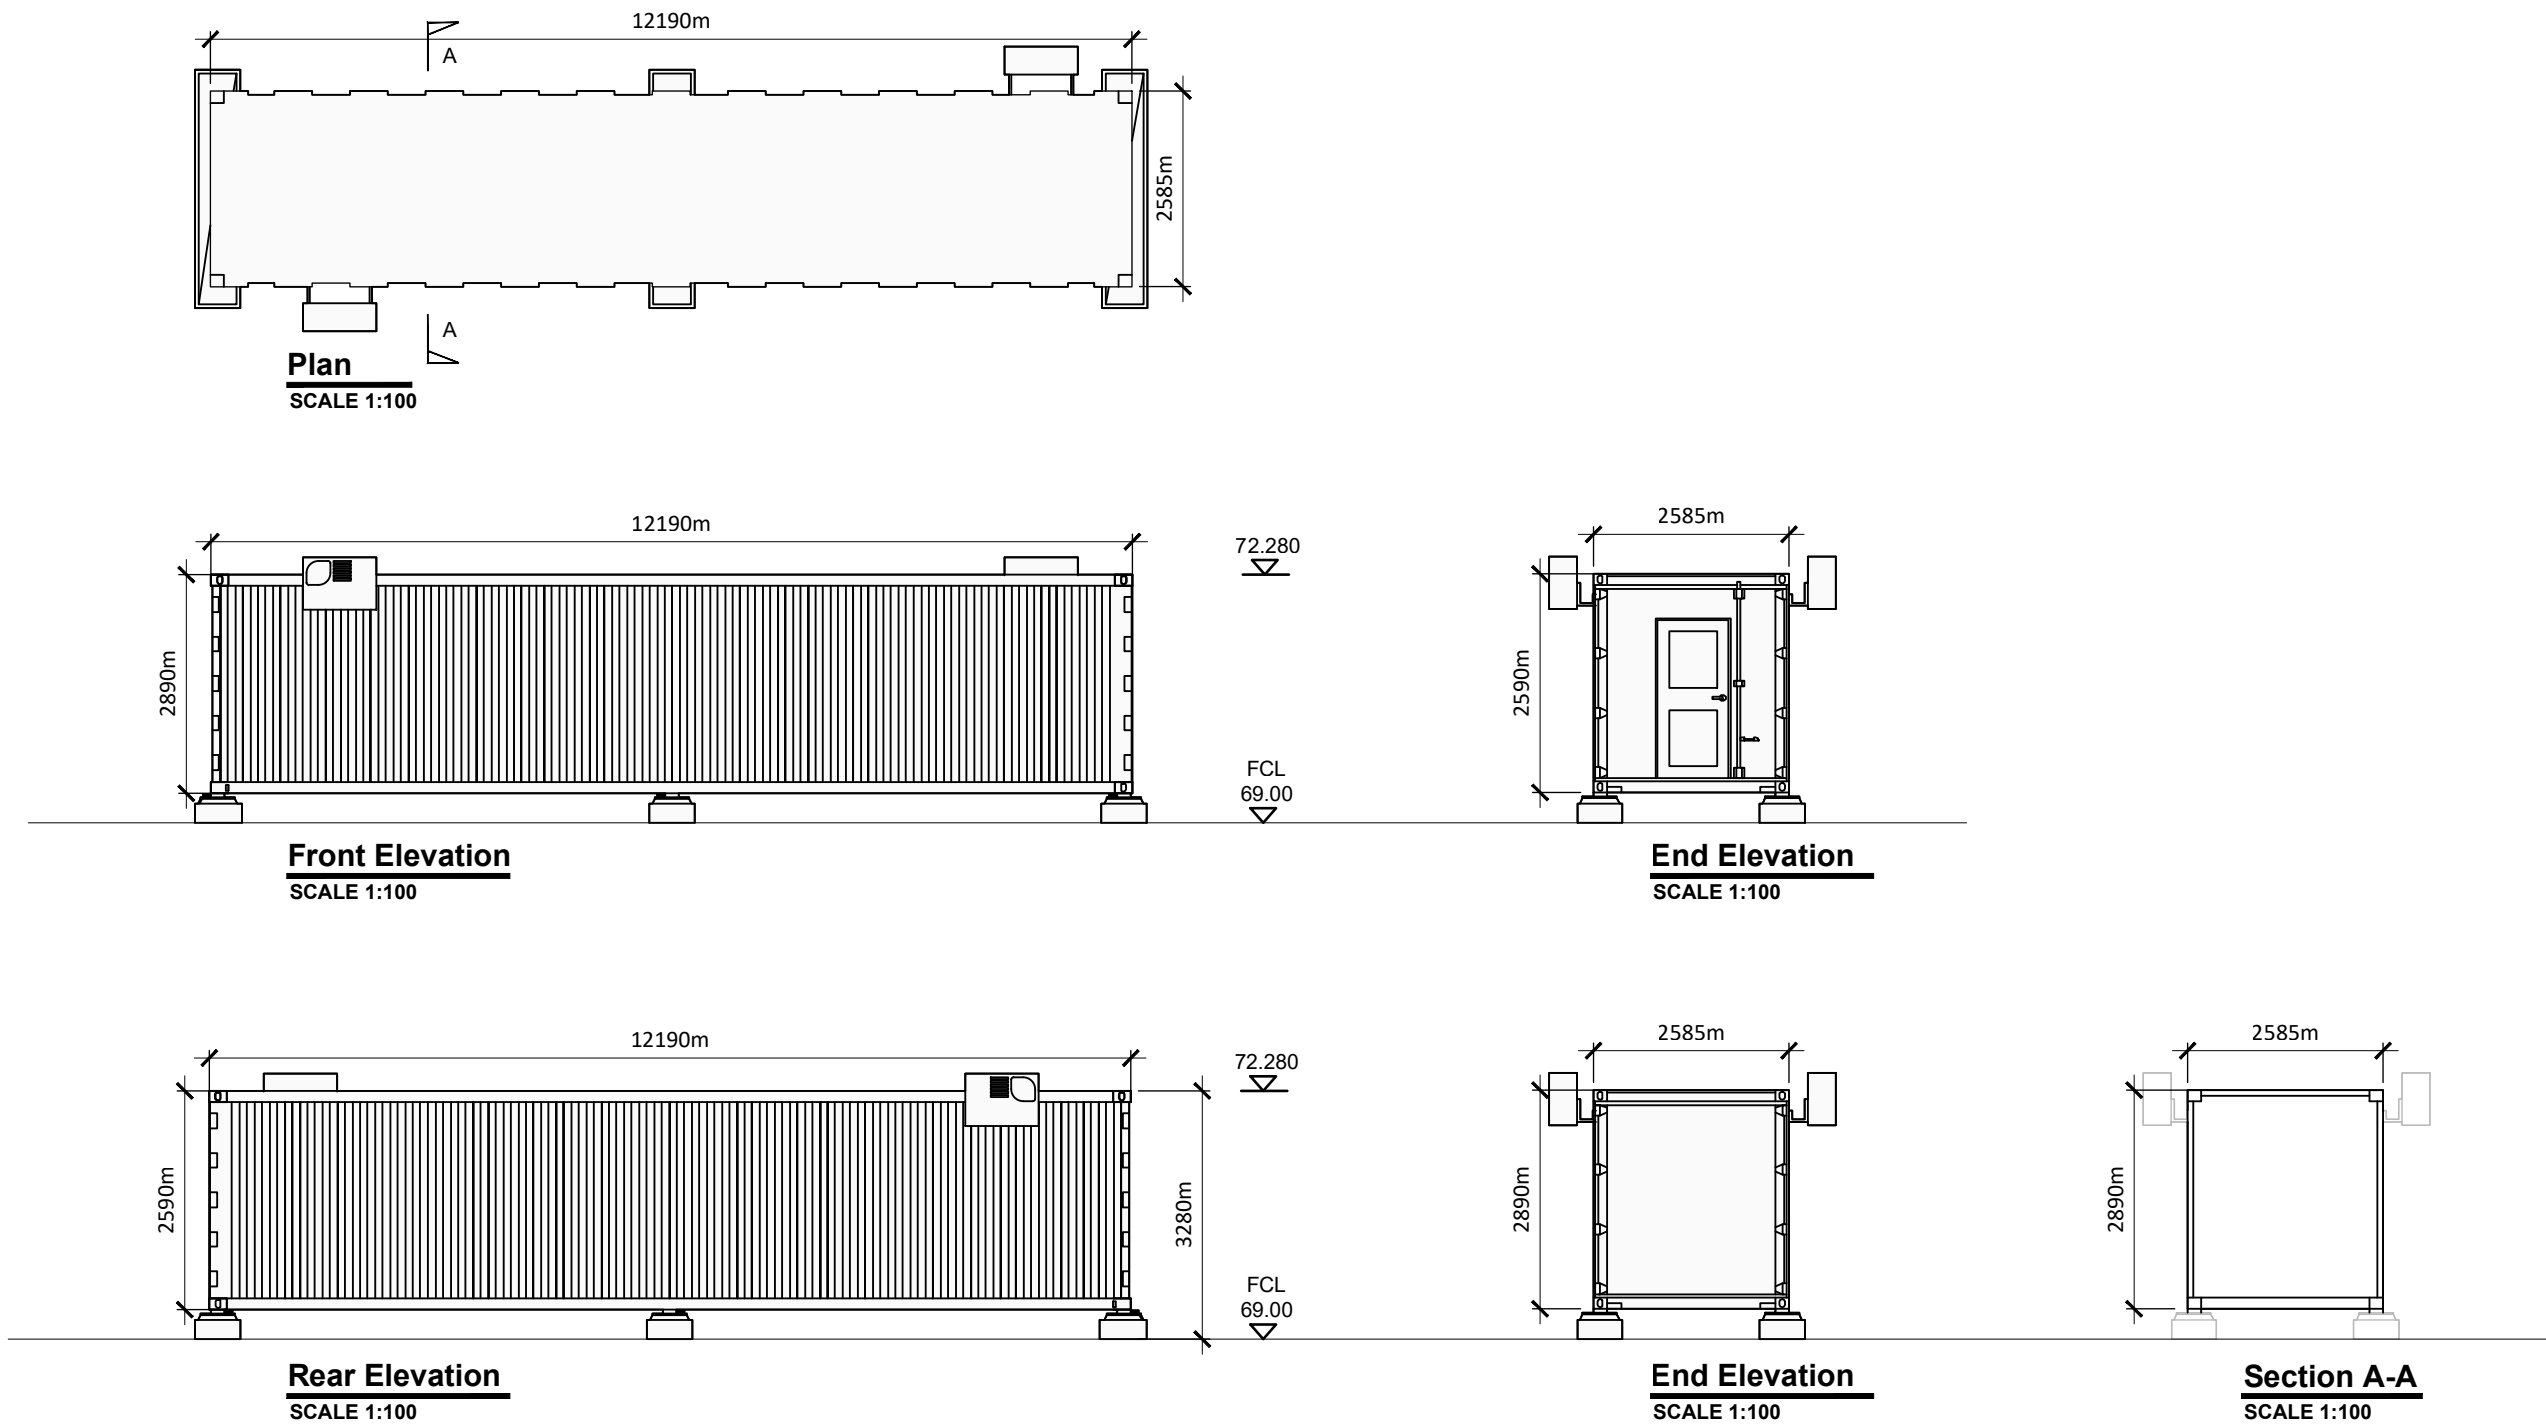

- Note:**
- Project contains 10 modules total.
  - Dimensions are in millimeters, unless noted otherwise.
  - Drawings are not to be scaled use figured dimensions only.
  - All Levels in Meters to Malin Head Datum

ISSUE/REVISION		
P1	04.06.24	Issued for Planning
I/R	DATE	DESCRIPTION




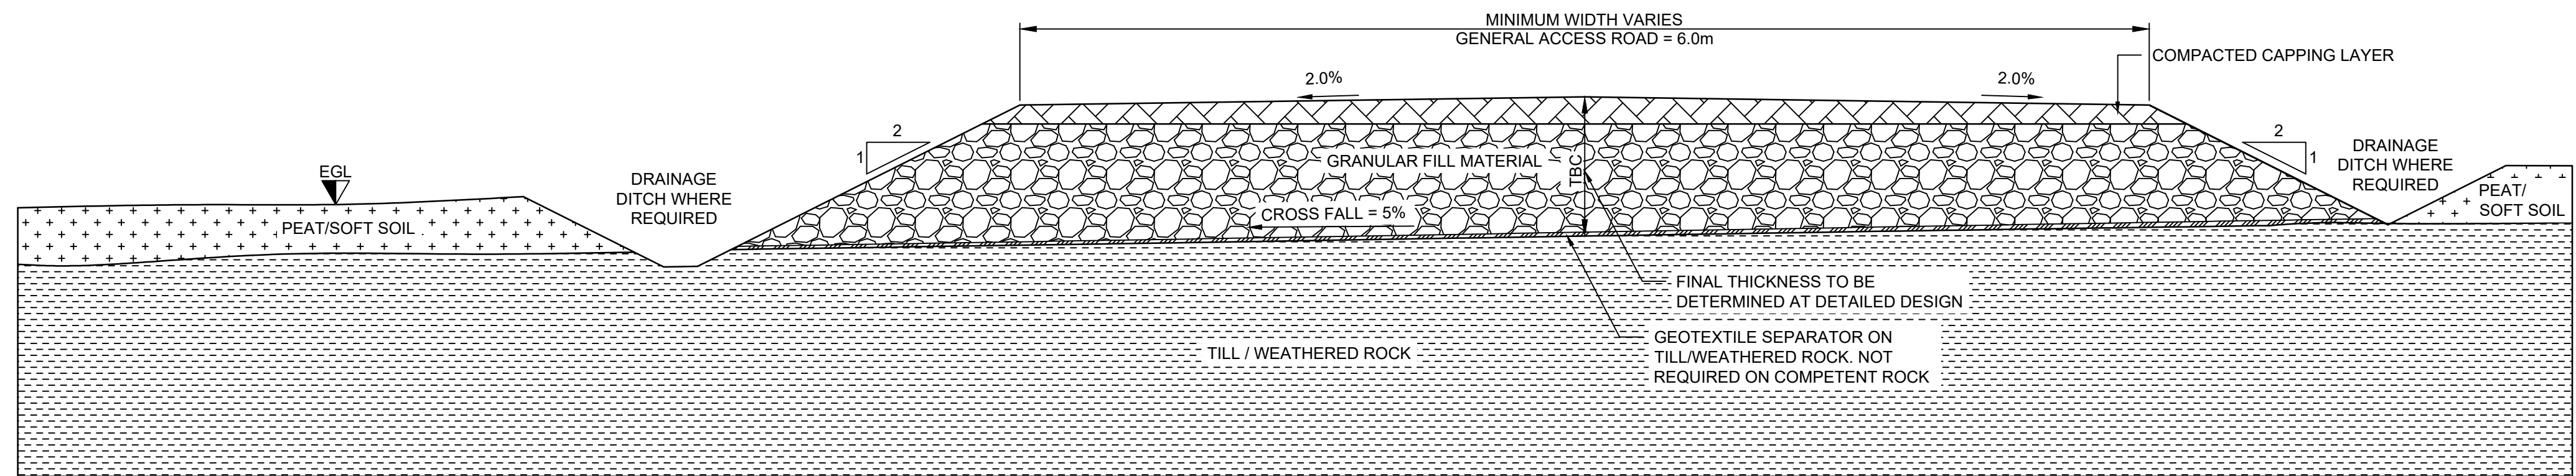

SECTION THROUGH ACCESS ROAD  
NEW CONSTRUCTION: FOUNDED - DETAIL 01


SCALE: N.T.S.

FLOATING ROADS TO BE CONSTRUCTED ONLY WHERE  
CROSSFALLS ARE <5% AND LONGITUDINAL GRADIENTS  
ARE <5% UNLESS A SITE SPECIFIC DESIGN IS CARRIED OUT.

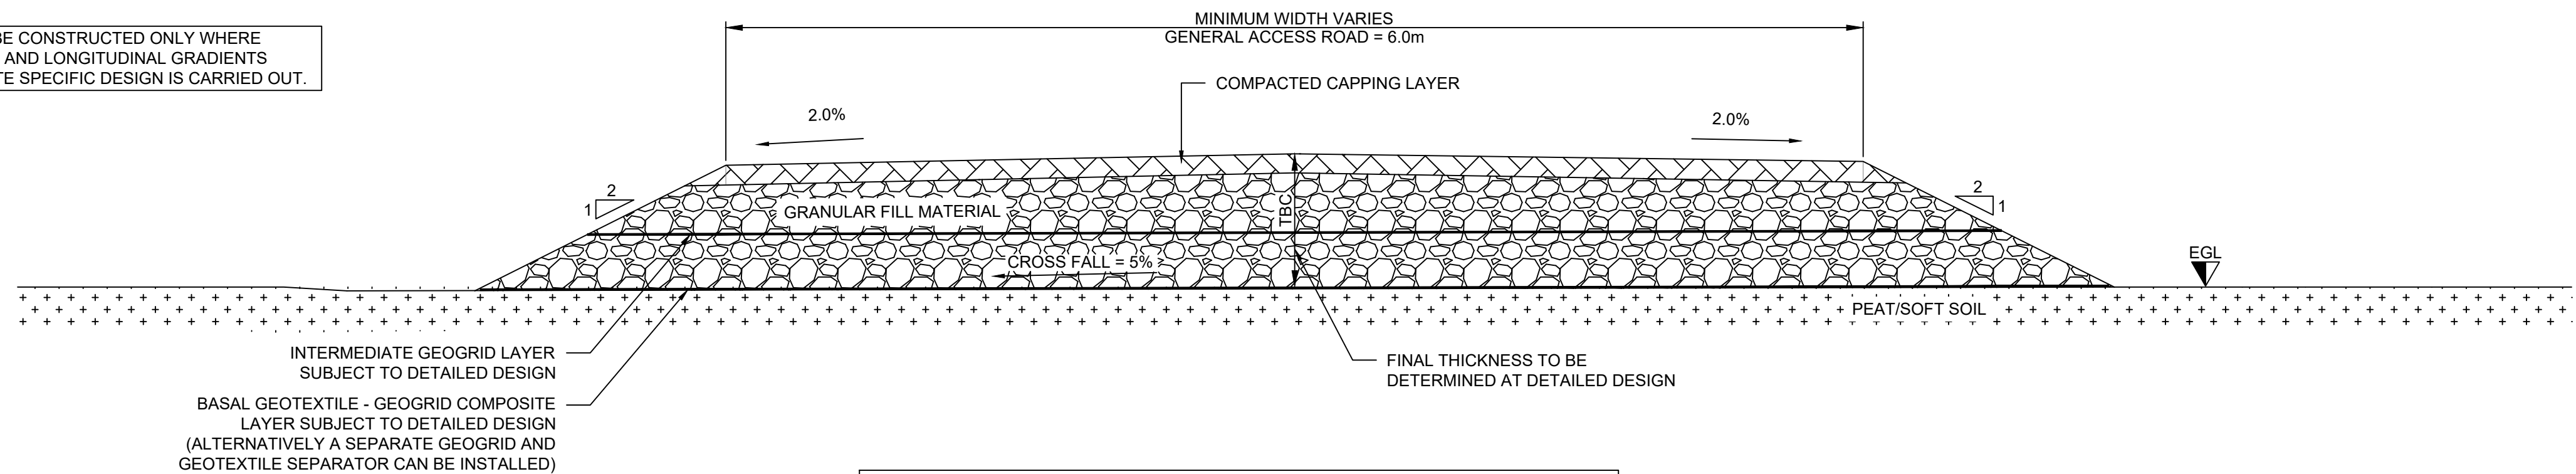


SECTION THROUGH ACCESS ROAD  
NEW CONSTRUCTION: FLOATED - DETAIL 02

SCALE: N.T.S.

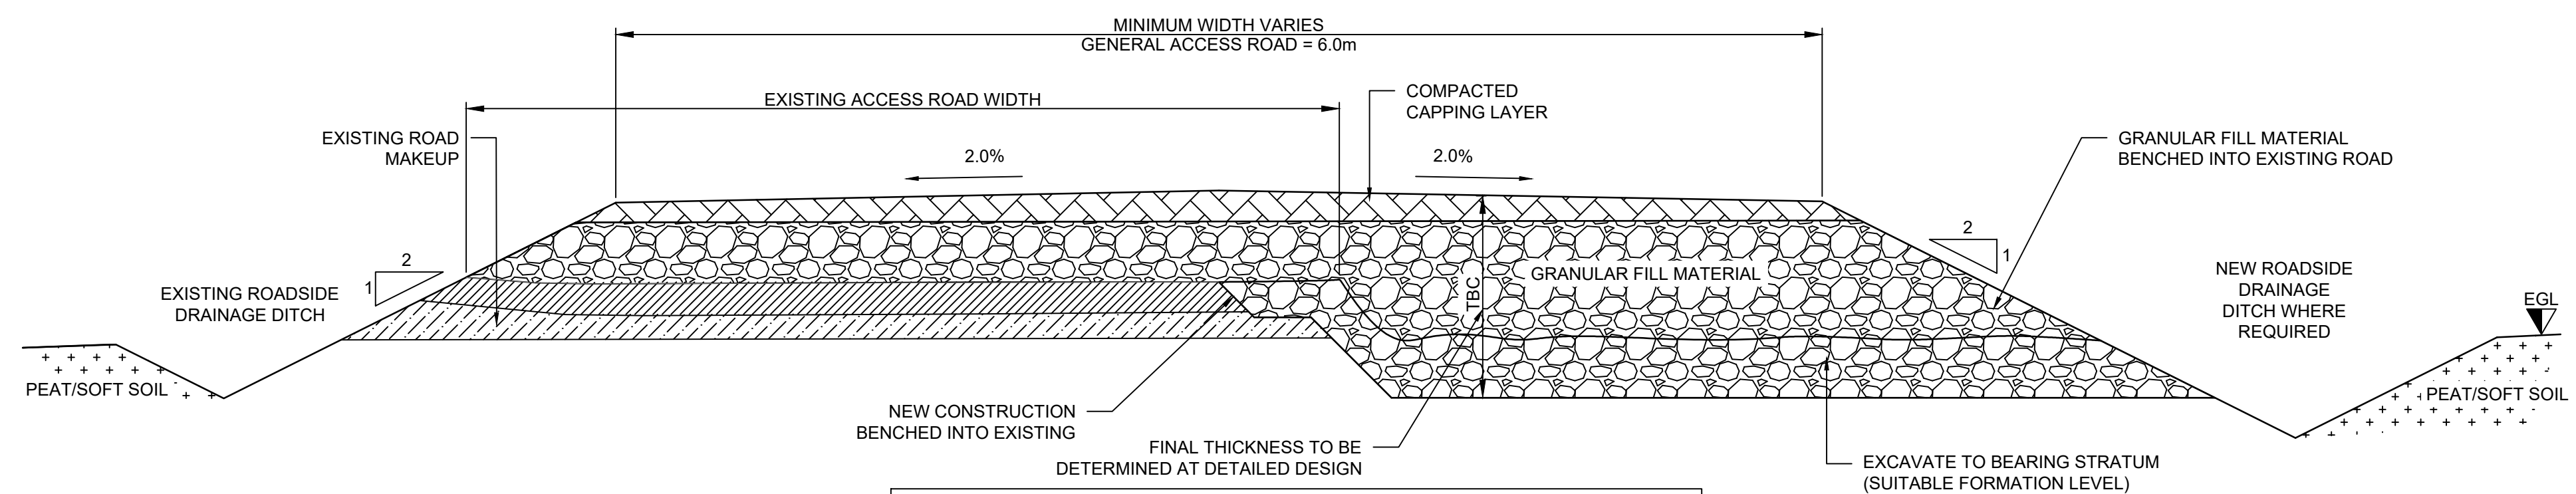

SECTION THROUGH WIDENING OF EXISTING  
ACCESS ROAD: FOUNDED - DETAIL 03

SCALE: N.T.S.

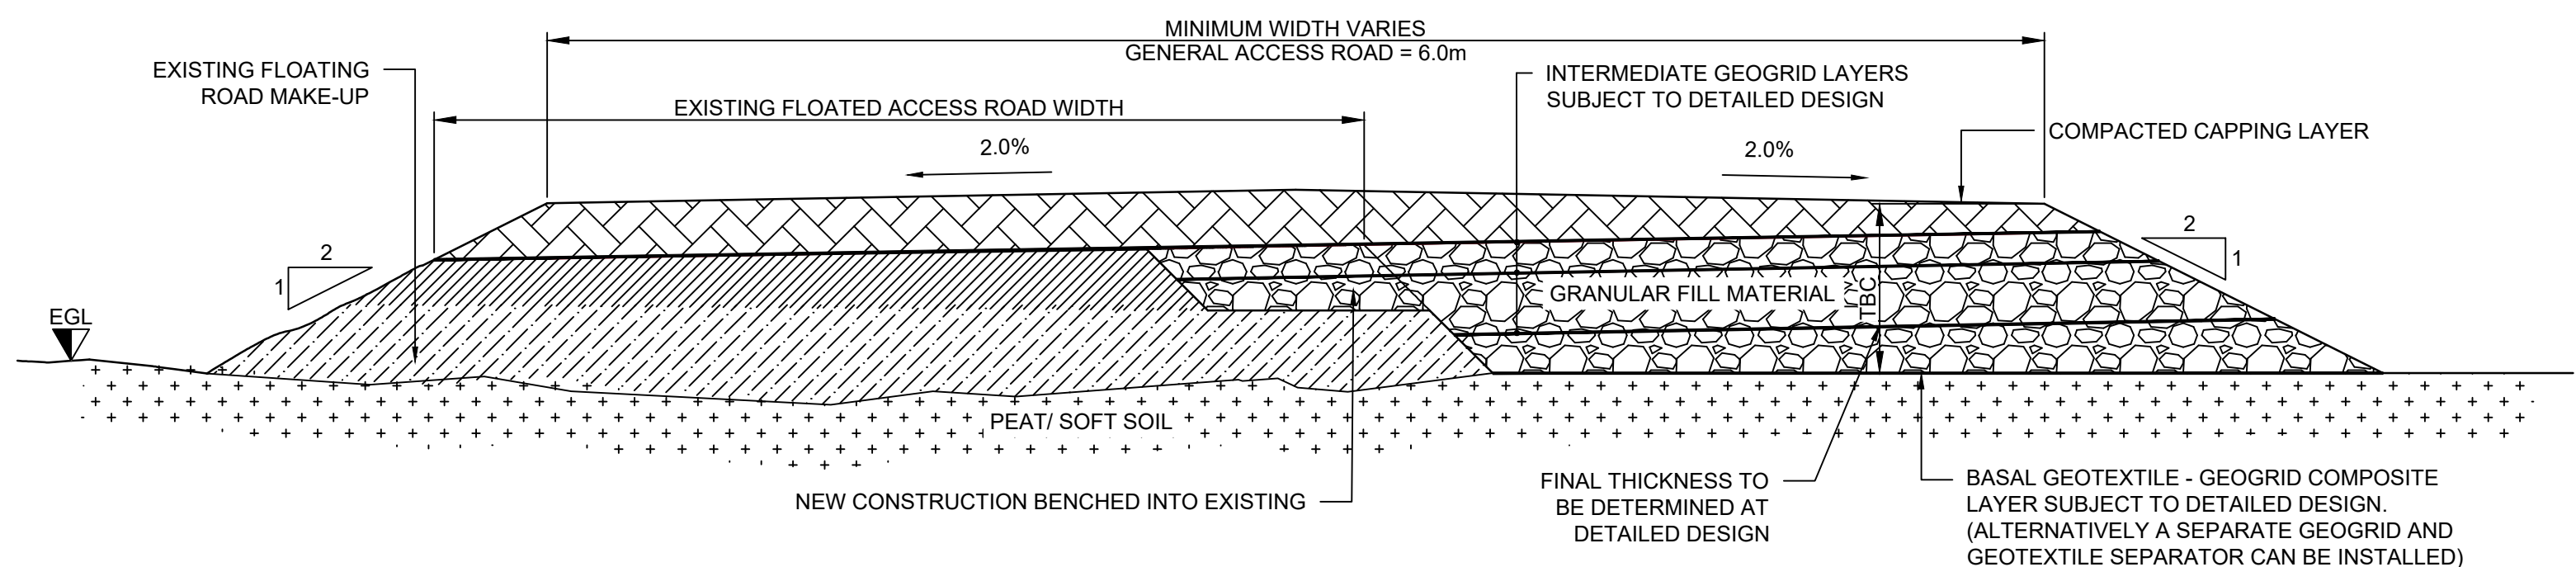

SECTION THROUGH WIDENING OF EXISTING  
ACCESS ROAD: FLOATED - DETAIL 04

SCALE: N.T.S.

#### NOTES:

1. THIS DRAWING IS FOR PLANNING AND ENVIRONMENTAL IMPACT ASSESSMENT PURPOSES AND SHOULD NOT BE USED AS DETAILED DESIGN OR FOR CONSTRUCTION.
2. DO NOT SCALE FROM DRAWINGS.
3. THE STRENGTH OF THE SUBFORMATION SOILS TO BE ASSESSED BY A SUITABLY QUALIFIED GEOTECHNICAL ENGINEER PRIOR TO CONSTRUCTION / PLACEMENT OF FILL.
4. DRAINAGE TO BE PROVIDED TO PREVENT WATER DEGRADATION OF THE SUBFORMATION SOILS IN-LINE WITH DRAINAGE STRATEGY.

#### HEALTH & SAFETY:

1. NO OPERATIVES TO ACCESS ANY UNSUPPORTED TRENCHES. TRENCHES TO BE ADEQUATELY BATTERED BACK OR SUPPORTED WHERE NECESSARY. SAFE TEMPORARY BATTER ANGLES TO BE ASSESSED IN ACCORDANCE WITH CIRIA REPORT 97 'TRENCHING PRACTICE'.

REV:	S2-P01	DATE:	18/12/23	DRAWN BY:	EFC	CHECKED BY:	C.E.
DESCRIPTION:	ISSUED FOR INFORMATION						

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ISSUED AS: FOR INFORMATION



PROJECT TITLE: CLONBERNE  
WIND FARM


DRAWING No: 2021-GDG-ZZ-XX-DR-C-0100

Revision: -S2-P01

DRAWING TITLE:  
ACCESS ROAD  
STANDARD DETAILS

SCALE:	N.T.S.	SHEET SIZE:	A1	DATE:	18/12/2023
DRAWN BY:	EFC	CHECKED BY:	C.E.	APPROVED BY:	J.O'D.




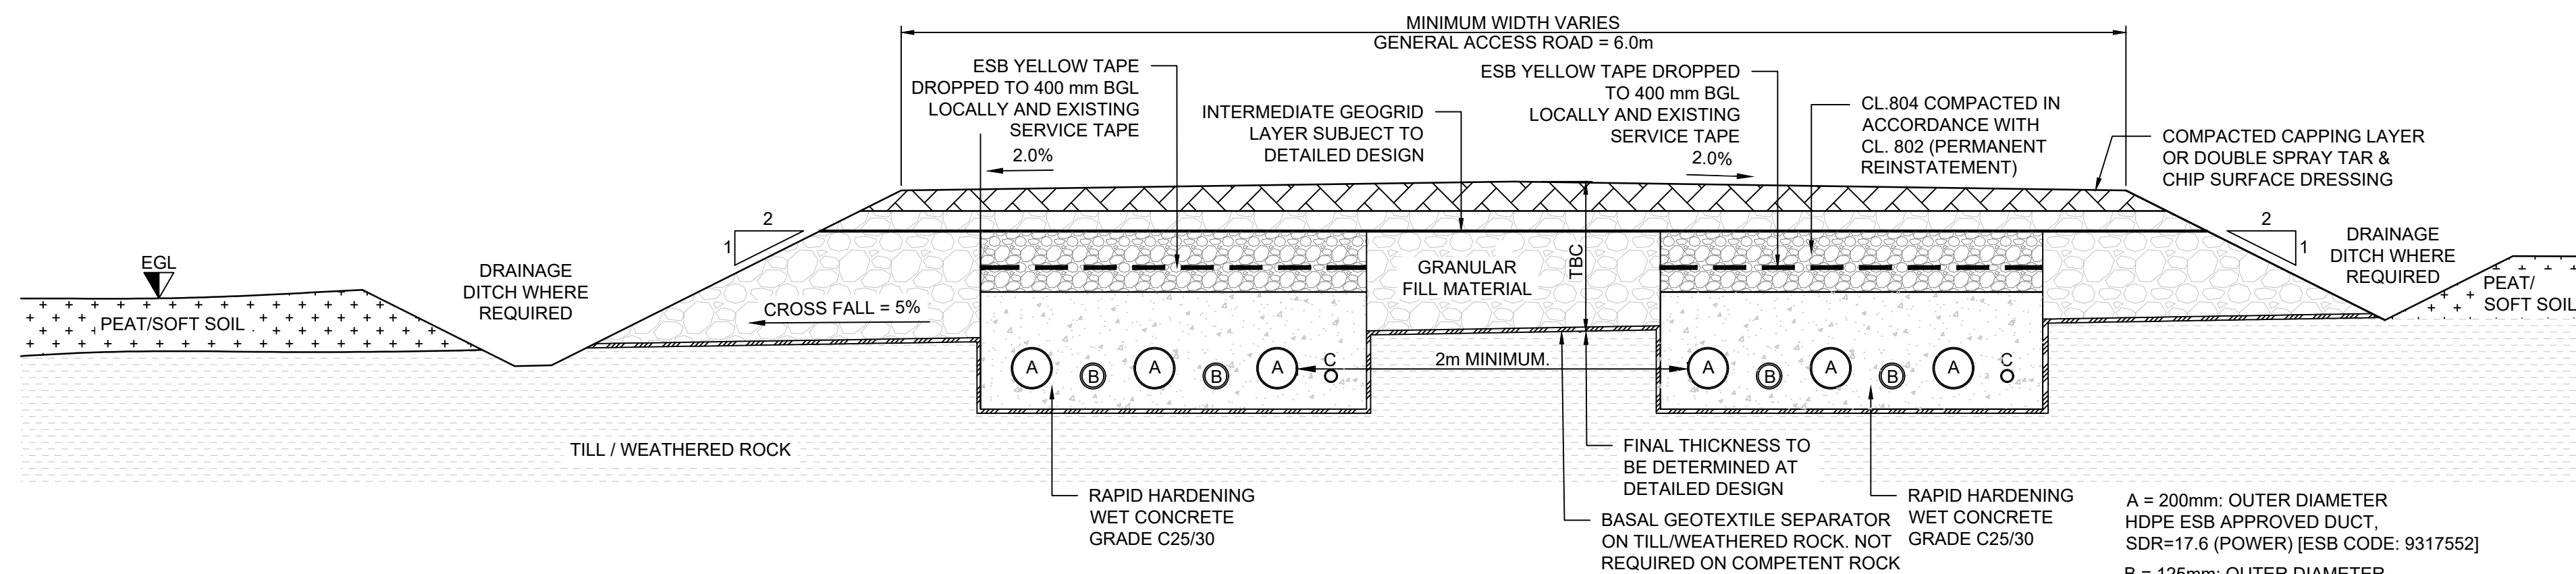

**SECTION THROUGH CABLE TRENCH  
NEW CONSTRUCTION: FOUNDED - DETAIL 01**

SCALE: N.T.S.

A = 200mm: OUTER DIAMETER  
HDPE ESB APPROVED DUCT,  
SDR=17.6 (POWER) [ESB CODE: 9317552]  
B = 125mm: OUTER DIAMETER  
HDPE ESB APPROVED DUCT,  
SDR=17.6 (COMMS) [ESB CODE: 9317552]  
C = 63mm: OUTER DIAMETER  
HDPE ESB APPROVED DUCT,  
SDR=17.6 (ECC) [ESB CODE: 9317552]

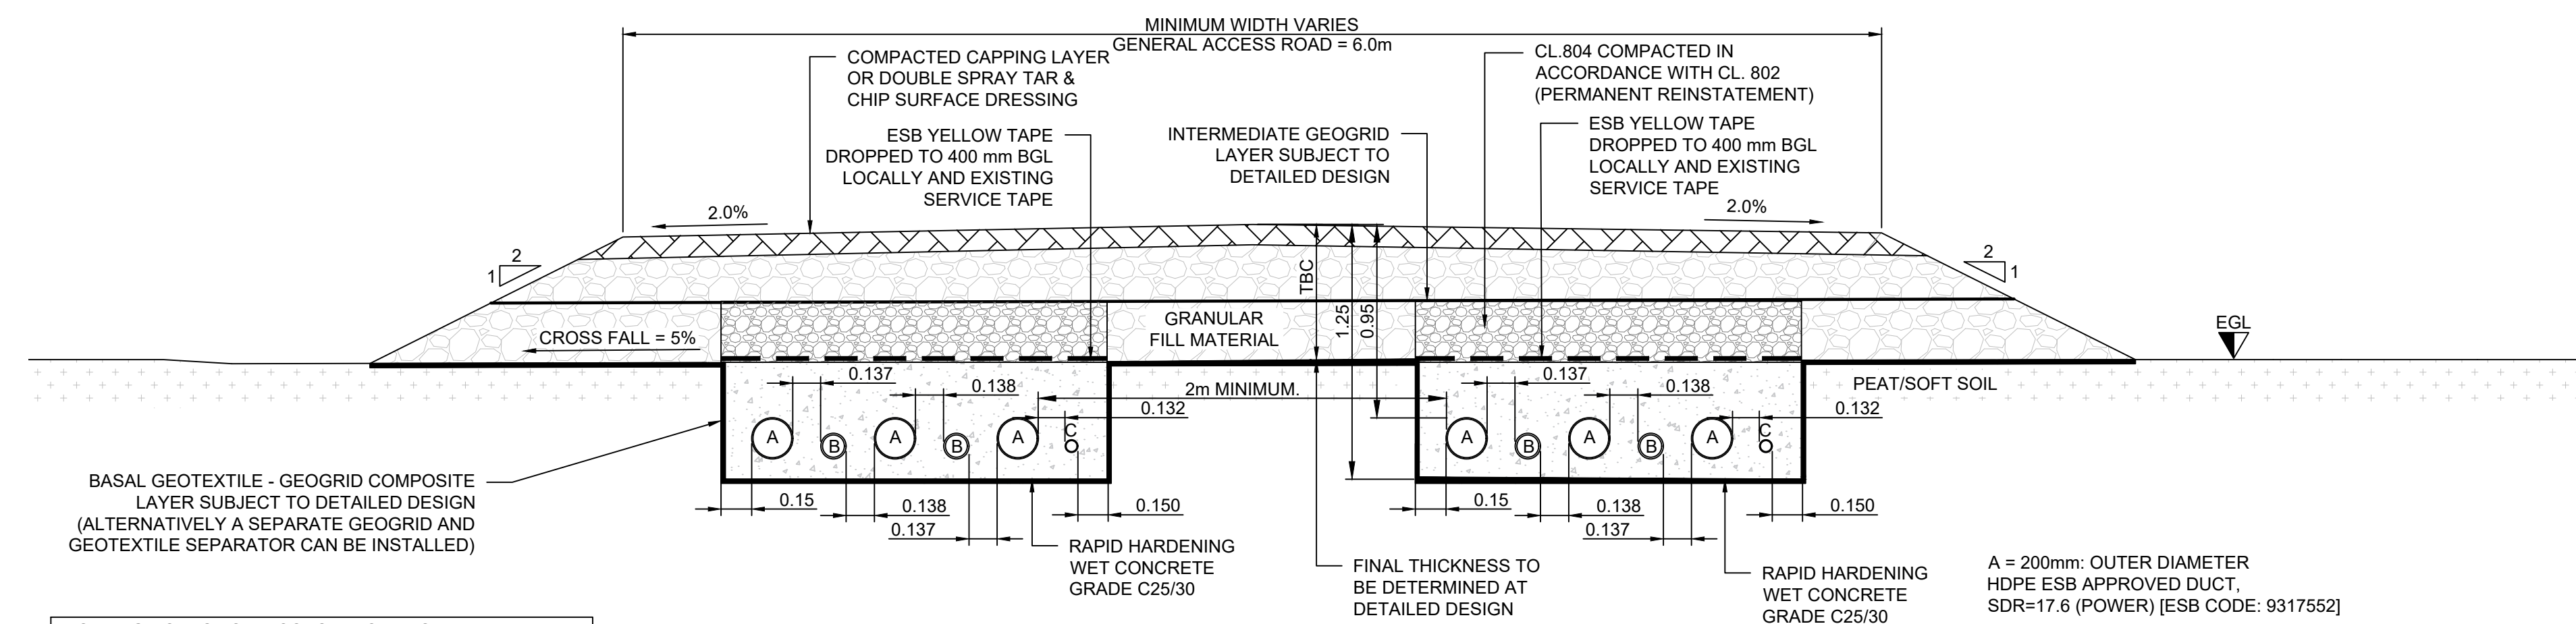

**SECTION THROUGH CABLE TRENCH  
NEW CONSTRUCTION: FLOATED - DETAIL 02**

SCALE: N.T.S.

A = 200mm: OUTER DIAMETER  
HDPE ESB APPROVED DUCT,  
SDR=17.6 (POWER) [ESB CODE: 9317552]  
B = 125mm: OUTER DIAMETER  
HDPE ESB APPROVED DUCT,  
SDR=17.6 (COMMS) [ESB CODE: 9317552]  
C = 63mm: OUTER DIAMETER  
HDPE ESB APPROVED DUCT,  
SDR=17.6 (ECC) [ESB CODE: 9317552]

FLOATING ROADS TO BE CONSTRUCTED ONLY WHERE  
CROSSFALLS ARE <5% AND LONGITUDINAL GRADIENTS  
ARE <5% UNLESS A SITE SPECIFIC DESIGN IS CARRIED OUT.

#### NOTES:

- THIS DRAWING IS FOR PLANNING AND ENVIRONMENTAL IMPACT ASSESSMENT PURPOSES AND SHOULD NOT BE USED AS DETAILED DESIGN OR FOR CONSTRUCTION.
- DO NOT SCALE FROM DRAWINGS.
- THE STRENGTH OF THE SUBFORMATION SOILS TO BE ASSESSED BY A SUITABLY QUALIFIED GEOTECHNICAL ENGINEER PRIOR TO CONSTRUCTION / PLACEMENT OF FILL.
- DRAINAGE TO BE PROVIDED TO PREVENT WATER DEGRADATION OF THE SUBFORMATION SOILS IN-LINE WITH DRAINAGE STRATEGY.
- BURIED CABLE SPACING TO BE DETERMINED DURING DETAILED DESIGN
- DIMENSIONS ARE IN METERS UNLESS OTHERWISE NOTED

#### HEALTH & SAFETY:

- NO OPERATIVES TO ACCESS ANY UNSUPPORTED TRENCHES. TRENCHES TO BE ADEQUATELY BATTERED BACK OR SUPPORTED WHERE NECESSARY. SAFE TEMPORARY BATTER ANGLES TO BE ASSESSED IN ACCORDANCE WITH CIRIA REPORT 97 "TRENCHING PRACTICE".

REV: S2-P02	DATE: 23/02/24	DRAWN BY: RR	CHECKED BY: C.E
DESCRIPTION: UPDATE TO ADDRESS MKO COMMENTS			
REV: S2-P01	DATE: 21/12/23	DRAWN BY: EFC	CHECKED BY: C.E
DESCRIPTION: ISSUED FOR INFORMATION			

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www.gdgeo.com

#### ISSUED AS: FOR INFORMATION



PROJECT TITLE: CLONBERNE  
WIND FARM

DRAWING No: 20021-GDG-ZZ-XX-DR-C-0101

Revision: -S2-P02


DRAWING TITLE: CABLE TRENCH  
STANDARD DETAILS

SCALE: N.T.S.	SHEET SIZE: A1	DATE: 21/12/2023
DRAWN BY: EFC	CHECKED BY: C.E.	APPROVED BY: J.O'D.






POLLUTION PREVENTION NOTES:

1. SITE MANAGEMENT PROPOSALS ARE INTENDED TO ENSURE PROTECTION AGAINST SURFACE WATER AND GROUNDWATER POLLUTION, SILTATION AND EROSION.
2. SUITABLE DRAINAGE CONTROL MEASURES SHOULD BE IN PLACE AT ALL TIMES TO PREVENT CONVEYANCE OF SIGNIFICANT VOLUMES OF SILT TO OFF SITE RECEIVING WATERCOURSES.
3. SILTY WATER CAN ARISE FROM DEWATERING EXCAVATIONS, EROSION OF EXPOSED/DISTURBED GROUND, TEMPORARY STOCKPILES, PLANT AND WHEEL WASH, SITE ROADS/TRACKS, AND DISTURBANCE OF EXISTING FIELD DRAINS AND DITCHES.
- DISCHARGES
4. WATER CONTAINING SILT WILL NOT BE PUMPED DIRECTLY TO ANY NATURAL WATERCOURSE. ALL DISCHARGES TO BE MADE OVER OPEN GROUND OR INTO EXISTING FIELD DRAIN WITH SILT TRAP AT A MINIMUM OF 20M FROM NEAREST WATERCOURSE UNLESS OTHERWISE STATED.
5. NO EXCAVATED MATERIAL IS TO BE STORED WITHIN ANY SURFACE WATER BUFFER ZONE.
6. PUMPED WATER WILL BE DIRECTED INTO TRACK SIDE DITCHES AND TREATED IN SETTLEMENT PONDS AND VEGETATION SWALES PRIOR TO OVERLAND DISCHARGE.
7. PUMPING OF CLEAN WATER FROM EXCAVATIONS / OR OVER-PUMPING IN DRAINS/DITCHES/STREAMS WILL BE COMPLETED IN A MANNER THAT DOES NOT CAUSE SCOUR OR EROSION AT THE POINT OF RELEASE/DISCHARGE. THIS WILL BE DONE BY REDUCING THE FLOW VELOCITIES OR BY USE OF SPLASH PLATES, AND OTHER SIMILAR DISCHARGE CONTROLS.
8. VEGETATION WILL NOT BE STRIPPED FROM EXISTING DRAINS/DITCHES UNLESS ABSOLUTELY NECESSARY.
- EXCAVATIONS
9. WHERE DEEP EXCAVATIONS ARE PROPOSED CUT-OFF DRAINS WILL BE USE TO REDUCE THE AMOUNT OF SURFACE WATER ENTERING THE EXCAVATION. THIS WILL BE THE CASE AROUND TURBINE BASE EXCAVATIONS.
- EXPOSED GROUND & STOCKPILES
10. THE AMOUNT OF EXPOSED GROUND AND TEMPORARY STOCKPILES OPEN AT ANY ONE TIME WILL BE MINIMISED, AS FAR AS PRACTICABLE.
- SITE TRACKS
11. USE OF TRACK SIDE SWALES WITH CHECK DAMS, AND/OR FILTRATION CHECK DAMS WILL REDUCE SILT IN RUNOFF WATER AS REQUIRED.
12. CHECK DAMS TO BE INSPECTED AND CLEANED REGULARLY.
- REFUELLING
13. REFUELLING OF MOBILE PLANT WILL BE COMPLETED IN DESIGNATED REFUELLING AREAS ONLY, PREFERABLY ON AN IMPERMEABLE SURFACE AND AWAY FROM FIELD DRAINS / DITCHES AND WATERCOURSES / WATERBODIES.
14. SPILL KITS AND DRIP TRAYS WILL BE AVAILABLE ON SITE FOR USE AS REQUIRED.
- CONCRETE
15. CARE WILL BE TAKEN WHEN COMPLETING CONCRETE WORKS ON SITE TO ENSURE NO DISCHARGES OCCUR.
16. CONCRETE WASH WATER, AND WASTE CONCRETE WILL BE MANAGED APPROPRIATELY ON SITE.
- IF WATER POLLUTION IS IDENTIFIED THE FOLLOWING STEPS WOULD BE ADHERED TO:
- STOP - WORK IN THE IMMEDIATE AREA SHOULD BE STOPPED AND THE SOURCE OF THE POLLUTION IDENTIFIED.
- CONTAIN - THE SOURCE OF THE POLLUTION SHOULD BE BUNDED USING A SUITABLE METHOD. NATURAL WATERCOURSES SHOULD BE TEMPORARILY DIVERTED AROUND THE SOURCE OF POLLUTION.
- NOTIFY - THE RELEVANT AUTHORITIES (SITE MANAGER / FISHERIES / NPWS / LOCAL AUTHORITY ETC.) SHOULD BE NOTIFIED IMMEDIATELY TO ENSURE THAT MEASURES CAN BE IMPLEMENTED DOWNSTREAM TO PROTECT FISHERIES AND OTHER SENSITIVE AREAS.
- DRAINAGE NOTES:
1. ROADWAY SURFACING DESIGN AND CONSTRUCTION TO ENGINEER'S SPECIFICATION (I.E. BY OTHERS).
2. SPARE STRAW BALES/SILT FENCING/ OR SIMILAR, TO BE STORED ON SITE. THE LEVEL OF SILT IN RUNOFF DURING CONSTRUCTION IS TO BE MONITORED VISUALLY AND EXCESSIVE SILT LEVELS IN ANY AREA TO BE TEMPORARILY MANAGED BY PLACING SILT FENCES, STRAW BALES / OR SIMILAR OR ADDITIONAL CHECK DAMS AT THE PROBLEM AREAS. MOBILE SILTBUSTER SYSTEM TO BE AVAILABLE ON-SITE FOR USE AS REQUIRED ALSO.
3. SUDS SYSTEM TO BE CONSTRUCTED PRIOR TO, OR AT THE SAME TIME AS THE ACCESS TRACKS. INTERIM MEASURES SUCH AS THE PLACEMENT OF STRAW BALES/SILT FENCING/OR SIMILAR APPROVED METHOD OR ADDITIONAL CHECK DAMS AND SILT FENCES TO BE EMPLOYED IN ALL INSTANCES WHERE WORK CARRIED OUT TO CONSTRUCT THE ACCESS TRACKS IS LIKELY TO CAUSE ADVERSE ENVIRONMENTAL EFFECTS THROUGH INCREASED SILT LOADINGS BEING GENERATED DURING THE CONSTRUCTION PHASE.
4. SUITABLE PREVENTION MEASURES SHOULD BE IN PLACE AT ALL TIMES TO PREVENT THE CONVEYANCE OF SIGNIFICANT VOLUMES OF SILT TO RECEIVING WATERCOURSES. SEE NOTES ON POLLUTION PREVENTION.
5. INTERCEPTOR SWALES / DITCHES TO BE USED TO COLLECT UPSTREAM SURFACE WATER FLOWS. REGULAR CROSS DRAINS / DISCHARGE TO FIELD DITCHES/DRAINS WILL BE REQUIRED TO TRANSFER / DISCHARGE SURFACE WATER IN INTERCEPTOR DRAINS TO SUITABLE FIELD DRAIN OUTFALL POINTS.
6. DRAINAGE SWALES / DITCHES TO BE EXCAVATED ADJACENT TO THE ACCESS TRACKS. REGULAR CROSS DRAINS TO BE LOCATED ALONG ACCESS TRACKS TO PREVENT EXCESSIVE VOLUMES OF WATER COLLECTING IN THE SWALES / DITCHES. LOCATIONS OF CROSS DRAINS TO BE AGREED WITH THE ENGINEER ON SITE. SURFACE WATER WILL NOT BE ALLOWED TO DISCHARGE DIRECTLY INTO EXISTING WATERCOURSES.
7. WHERE POSSIBLE, A BUFFER ZONE OF >20M TO ANY EXISTING WATERCOURSE WILL BE REQUIRED WHERE OVER LAND DISCHARGES ARE PROPOSED FROM ACCESS TRACK SWALES / DITCHES.
8. BATTERS OF ALL PROPOSED SWALES / DITCHES TO HAVE A SLOPE OF BETWEEN 1 : 1.5 TO 1 : 2 DEPENDING UPON DEPTH OF SWALE/DITCH AND WILL BE LEFT AS CUT TO RE-VEGETATE WITH LOCAL SPECIES.
9. TRACK SIDE SWALES / DITCHES TO BE SHALLOW WITH MODERATE GRADIENTS TO PREVENT SCOURING. IN STEEP AREAS CHECK DAMS SHOULD BE INSTALLED TO REDUCE FLOW VELOCITIES AND PROVIDE SOURCE CONTROL OF SILT CONTAINMENT. WHERE NECESSARY THESE HAVE BEEN DESIGNATED IN CONJUNCTION WITH SETTLEMENT PONDS AND SILT TRAPS, PRIOR TO DISCHARGE.
10. SETTLEMENT PONDS TO BE CONSTRUCTED FOR SILT REMOVAL AT TURBINE BASES AND HARD STAND AREAS. POND SIZES DEPENDS ON CATCHMENT AREA SERVED. SAMPLE POND SIZES SHOWN ON DRAWING D501.
11. STRAW BALES / OR SIMILAR AND SILT FENCES TO BE USED ALSO AROUND SPOIL HEAPS TO MITIGATE SILT RUNOFF. SILT FENCES MAY BE REMOVED WHEN SUITABLE VEGETATION COVER IS ESTABLISHED.
12. SILT FENCES TO BE PROVIDE ALONG EDGE OF EXISTING WATERCOURSE WHERE WORKS COMES WITHIN <15M OF EDGE OF ANY DITCH / EPHEMERAL CHANNELS.
13. SLOPES OF THE SWALES / DITCHES TO BE VEGETATED OR PROTECTED FROM EROSION UNTIL VEGETATION HAS BEEN ESTABLISHED. STRIPPED VEGETATIVE LAYER (PEAT 'SOD' OR 'SCRAW') FROM EXCAVATIONS TO BE STORED LOCALLY AND USED TO LINE SLOPES AND BASE OF SWALES / DITCHES OR LONGITUDINAL MOUNDS OF VEGETATION SWALES AT FIELD DRAIN DISCHARGE POINTS.
14. AREAS STRIPPED OF VEGETATION SHOULD BE KEPT TO A MINIMUM.
15. CLEAN STONE FLOW CONTROL CHECK DAMS TO BE MADE OF LOCALLY WON / GEOLOGICALLY SIMILAR WELL GRADED STONE. AGGREGATE SIZE FOR STONE CHECK DAMS TO BE TYPICALLY 20- 40MM CLEAN STONE. ON SLOPING SECTIONS OF THE ACCESS TRACKS, 40MM CHECK DAMS TO BE PROTECTED FROM WASHING AWAY THROUGH THE PLACEMENT OF 100M STONE ON THE DOWNHILL FACE OF THE CHECK DAM AND BY WRAPPING IN GEOTEXTILE.
16. BUILD UP OF SILT LEVELS AT CHECK DAMS TO BE REMOVED AND DISPOSED OF APPROPRIATELY. SILT LEVELS AT CHECK DAMS TO BE VISUALLY INSPECTED AS PART OF AN ONGOING DRAINAGE MAINTENANCE PROGRAMME DURING THE CONSTRUCTION PHASE. WHERE CHECK DAMS BECAME CLOGGED WITH SILT OR VEGETATION, STONE CHECK DAM TO BE REMOVED AND REPLACED SUBSEQUENT TO THE REMOVAL OF SILT.
17. SPACING AND FREQUENCY OF CHECK DAMS WILL BE DEPENDENT UPON LONGITUDINAL GRADIENT OF SWALE.
18. LOCATION OF FILTRATION CHECK DAMS (IF REQUIRED) TO BE AGREED ON SITE WITH ENGINEER. SETTLEMENT PONDS TO BE CONSTRUCTED IN A MANNER WHERE THEY MAY BE EASILY INFILLED AT A LATER DATE (POST COMPLETION OF THE TURBINE BASE AND HARDSTAND CONSTRUCTION). ONLY SUITABLE MATERIALS EXCAVATED FROM THE POND TO BE USED TO FORM PART OF THE EMBANKMENT AROUND THE POND.
19. OIL FUEL SHOULD BE STORED WITHIN BUNDED CONTAINMENT STRUCTURES.
20. SILT BAGS WILL BE USED ON SITE AT FIELD DRAIN DISCHARGE LOCATIONS, AS NECESSARY.

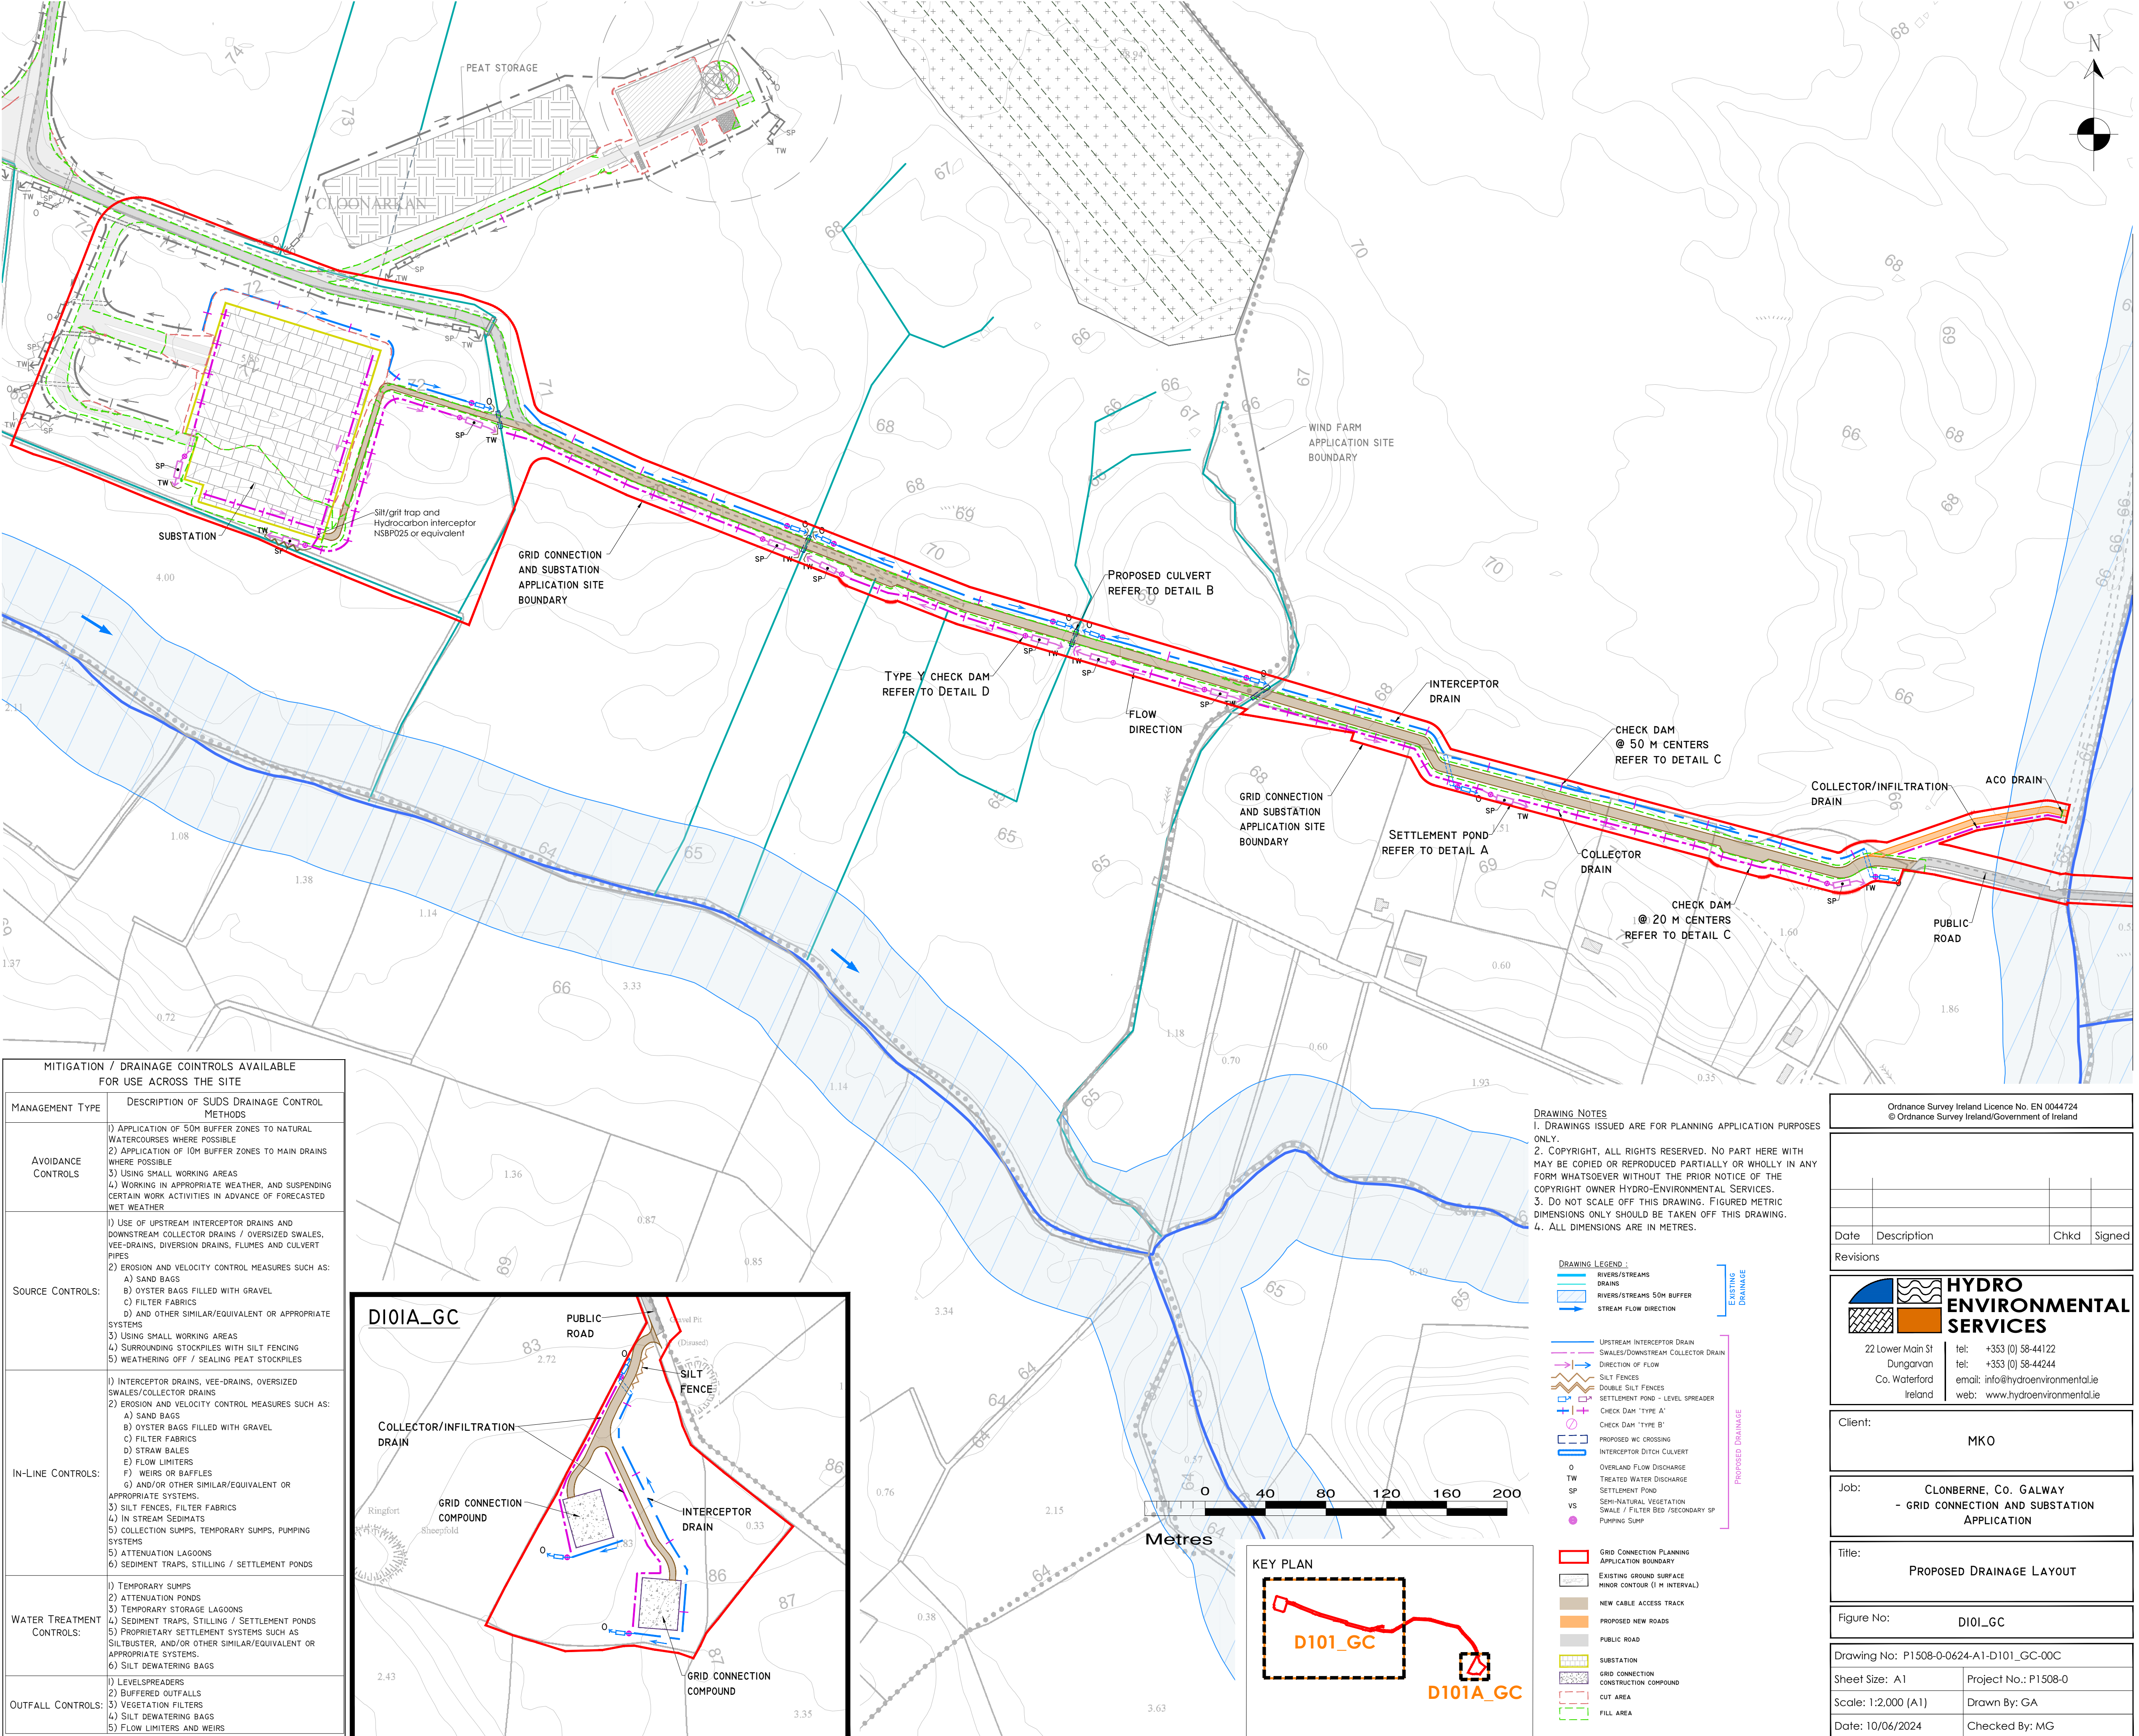

MITIGATION / DRAINAGE CONTROLS AVAILABLE FOR USE ACROSS THE SITE	
MANAGEMENT TYPE	DESCRIPTION OF SUDS DRAINAGE CONTROL METHODS
AVOIDANCE CONTROLS	1) APPLICATION OF 50M BUFFER ZONES TO NATURAL WATERCOURSES WHERE POSSIBLE
	2) APPLICATION OF 10M BUFFER ZONES TO MAIN DRAINS WHERE POSSIBLE
SOURCE CONTROLS:	1) USE OF UPSTREAM INTERCEPTOR DRAINS AND DOWNSTREAM COLLECTOR DRAINS / OVERSIZED SWALES, VEE-DRAINS, DIVERSION DRAINS, FLUMES AND CULVERT PIPES
	2) EROSION AND VELOCITY CONTROL MEASURES SUCH AS: A) SAND BAGS B) OYSTER BAGS FILLED WITH GRAVEL C) FILTER FABRICS D) AND OTHER SIMILAR/EQUIVALENT OR APPROPRIATE SYSTEMS
IN-LINE CONTROLS:	1) INTERCEPTOR DRAINS, VEE-DRAINS, OVERSIZED SWALES/COLLECTOR DRAINS
	2) EROSION AND VELOCITY CONTROL MEASURES SUCH AS: A) SAND BAGS B) OYSTER BAGS FILLED WITH GRAVEL C) FILTER FABRICS D) STRAW BALES E) FLOW LIMITERS F) WEIRS OR BAFFLES G) AND/OR OTHER SIMILAR/EQUIVALENT OR APPROPRIATE SYSTEMS
WATER TREATMENT CONTROLS:	1) TEMPORARY SUMPS
	2) ATTENUATION PONDS
OUTFALL CONTROLS:	1) TEMPORARY STORAGE LAGOONS
	2) SEDIMENT TRAPS, STILLING / SETTLEMENT PONDS

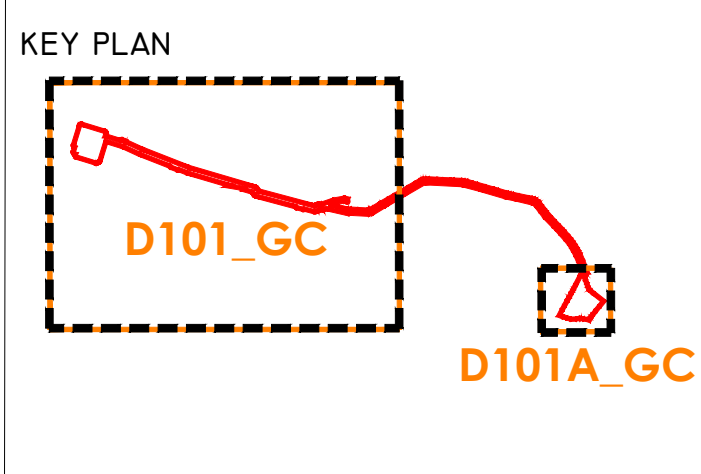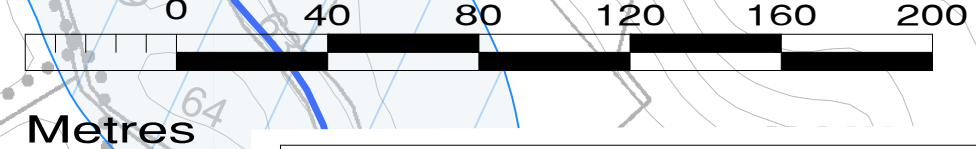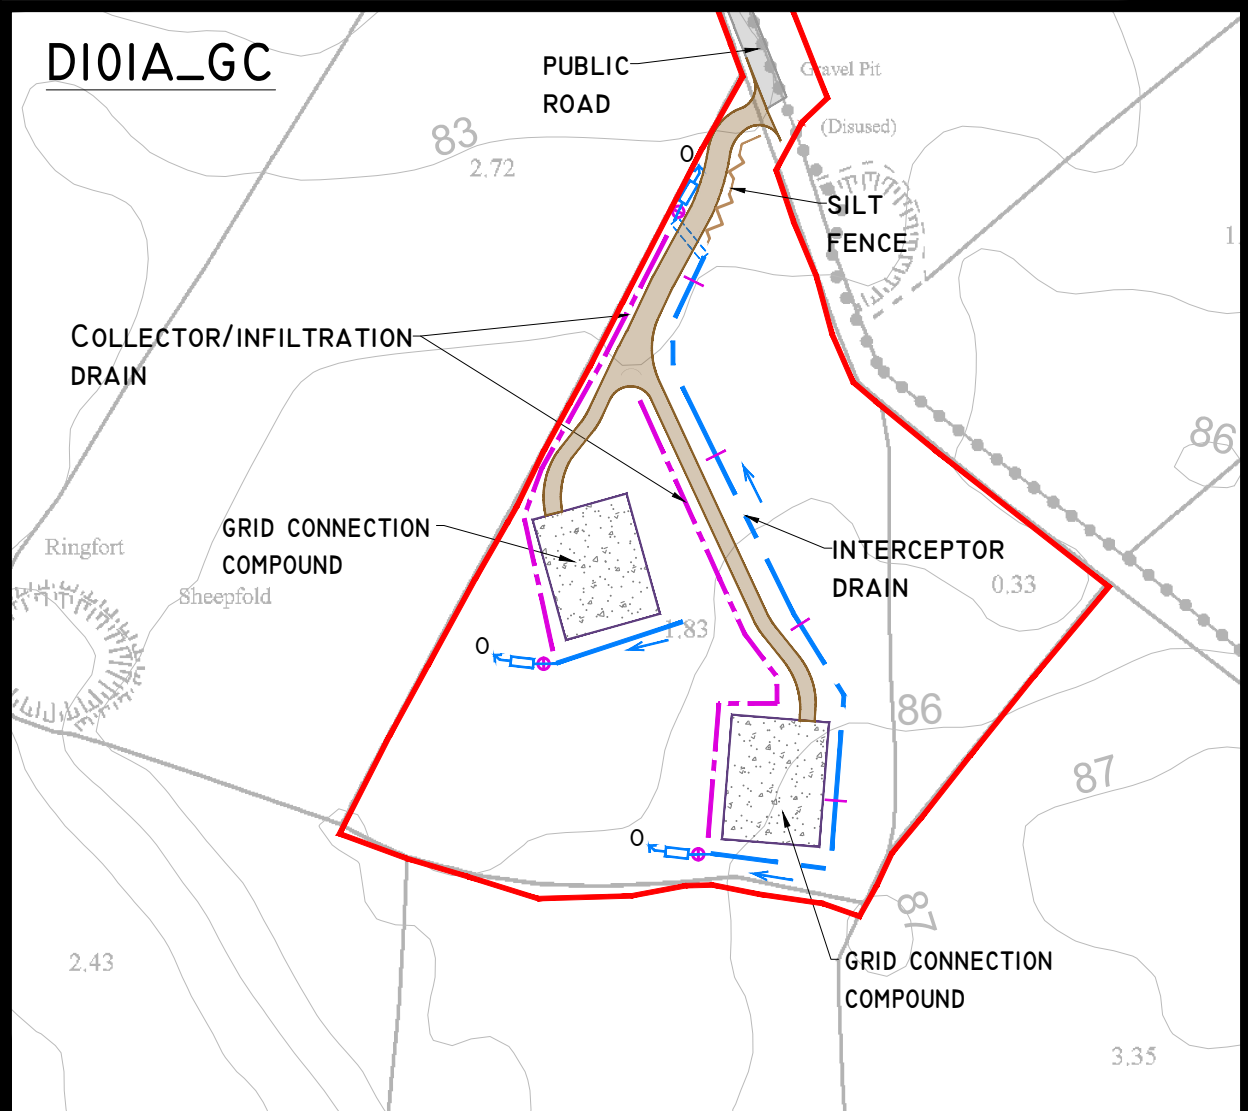

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4. ALL DIMENSIONS ARE IN METRES.

- DRAWING LEGEND:
- RIVERS/STREAMS  
DRAINS  
RIVERS/STREAMS 50M BUFFER  
STREAM FLOW DIRECTION
- UPSTREAM INTERCEPTOR DRAIN  
SWALES/DOWNSTREAM COLLECTOR DRAIN  
DIRECTION OF FLOW  
SILT FENCES  
DOUBLE SILT FENCES  
SETTLEMENT POND - LEVEL SPREADER  
CHECK DAM 'TYPE A'  
CHECK DAM 'TYPE B'  
PROPOSED WC CROSSING  
INTERCEPTOR DITCH CULVERT
- OVERLAND FLOW DISCHARGE  
TREATED WATER DISCHARGE  
SETTLEMENT POND  
SEMI-NATURAL VEGETATION  
SWALE / FILTER BED / SECONDARY SP  
PUMPING SURF
- GRID CONNECTION PLANNING  
APPLICATION BOUNDARY  
EXISTING GROUND SURFACE  
MINOR CONTOUR (1 M INTERVAL)  
NEW CABLE ACCESS TRACK  
PROPOSED NEW ROADS  
PUBLIC ROAD  
SUBSTATION  
GRID CONNECTION  
CONSTRUCTION COMPOUND  
CUT AREA  
FILL AREA

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Date Description Chkd Signed

Revisions

Client: MKO

Job: CLONBERNE, CO. GALWAY  
- GRID CONNECTION AND SUBSTATION  
APPLICATION

Title: PROPOSED DRAINAGE LAYOUT

Figure No: D101\_GC

Drawing No: P1508-0-0624-A1-D101\_GC-00C


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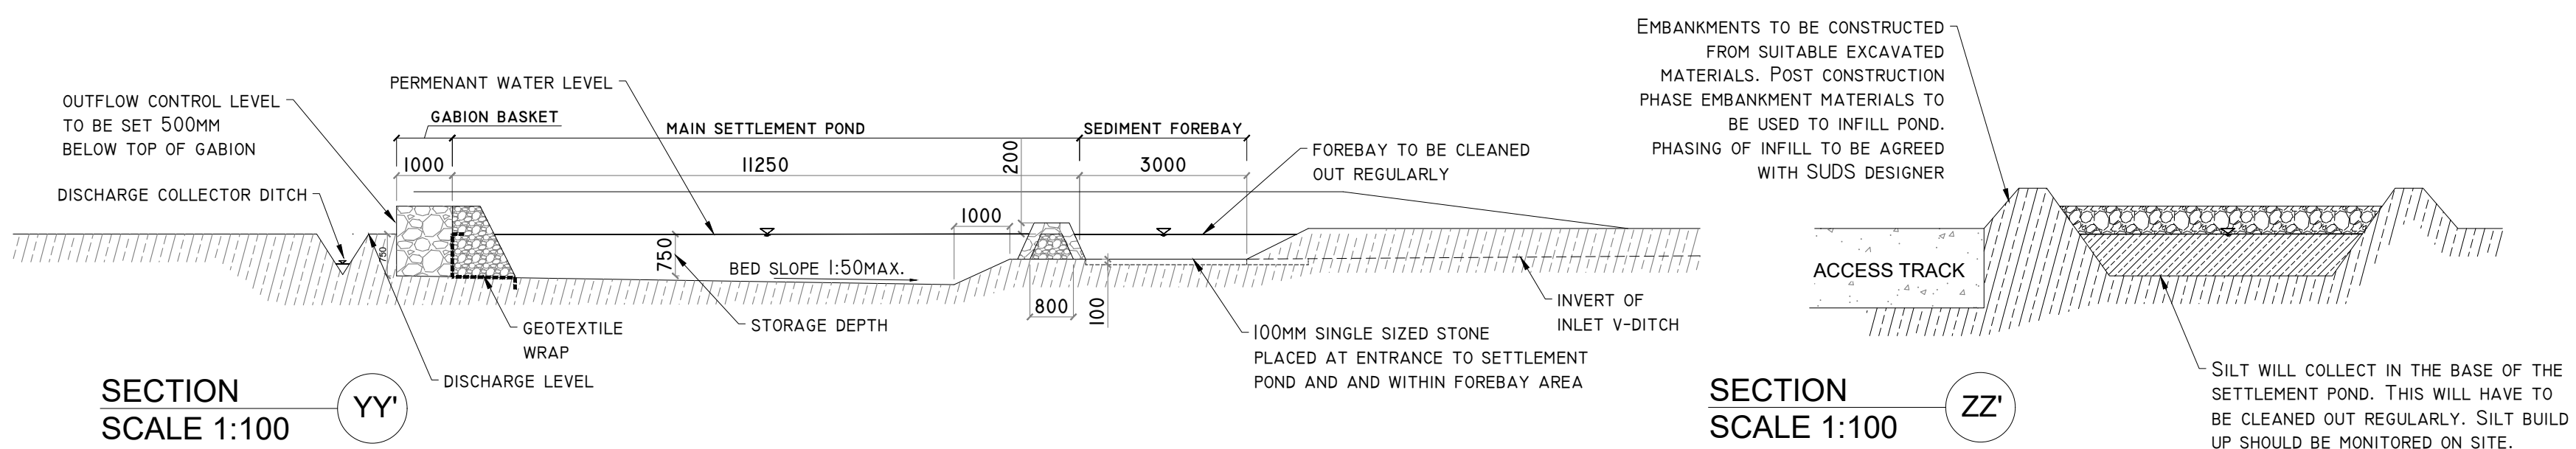
Date: 10/06/2024 Checked By: MG



DETAIL A1




TYPE A - TYPICAL ROAD SIDE SETTLEMENT POND DETAIL  
SCALE 1:200 (NOTE DIMENSIONS VARY DEPENDING ON CATCHMENT SIZE - SEE ATTACHED TABLE)

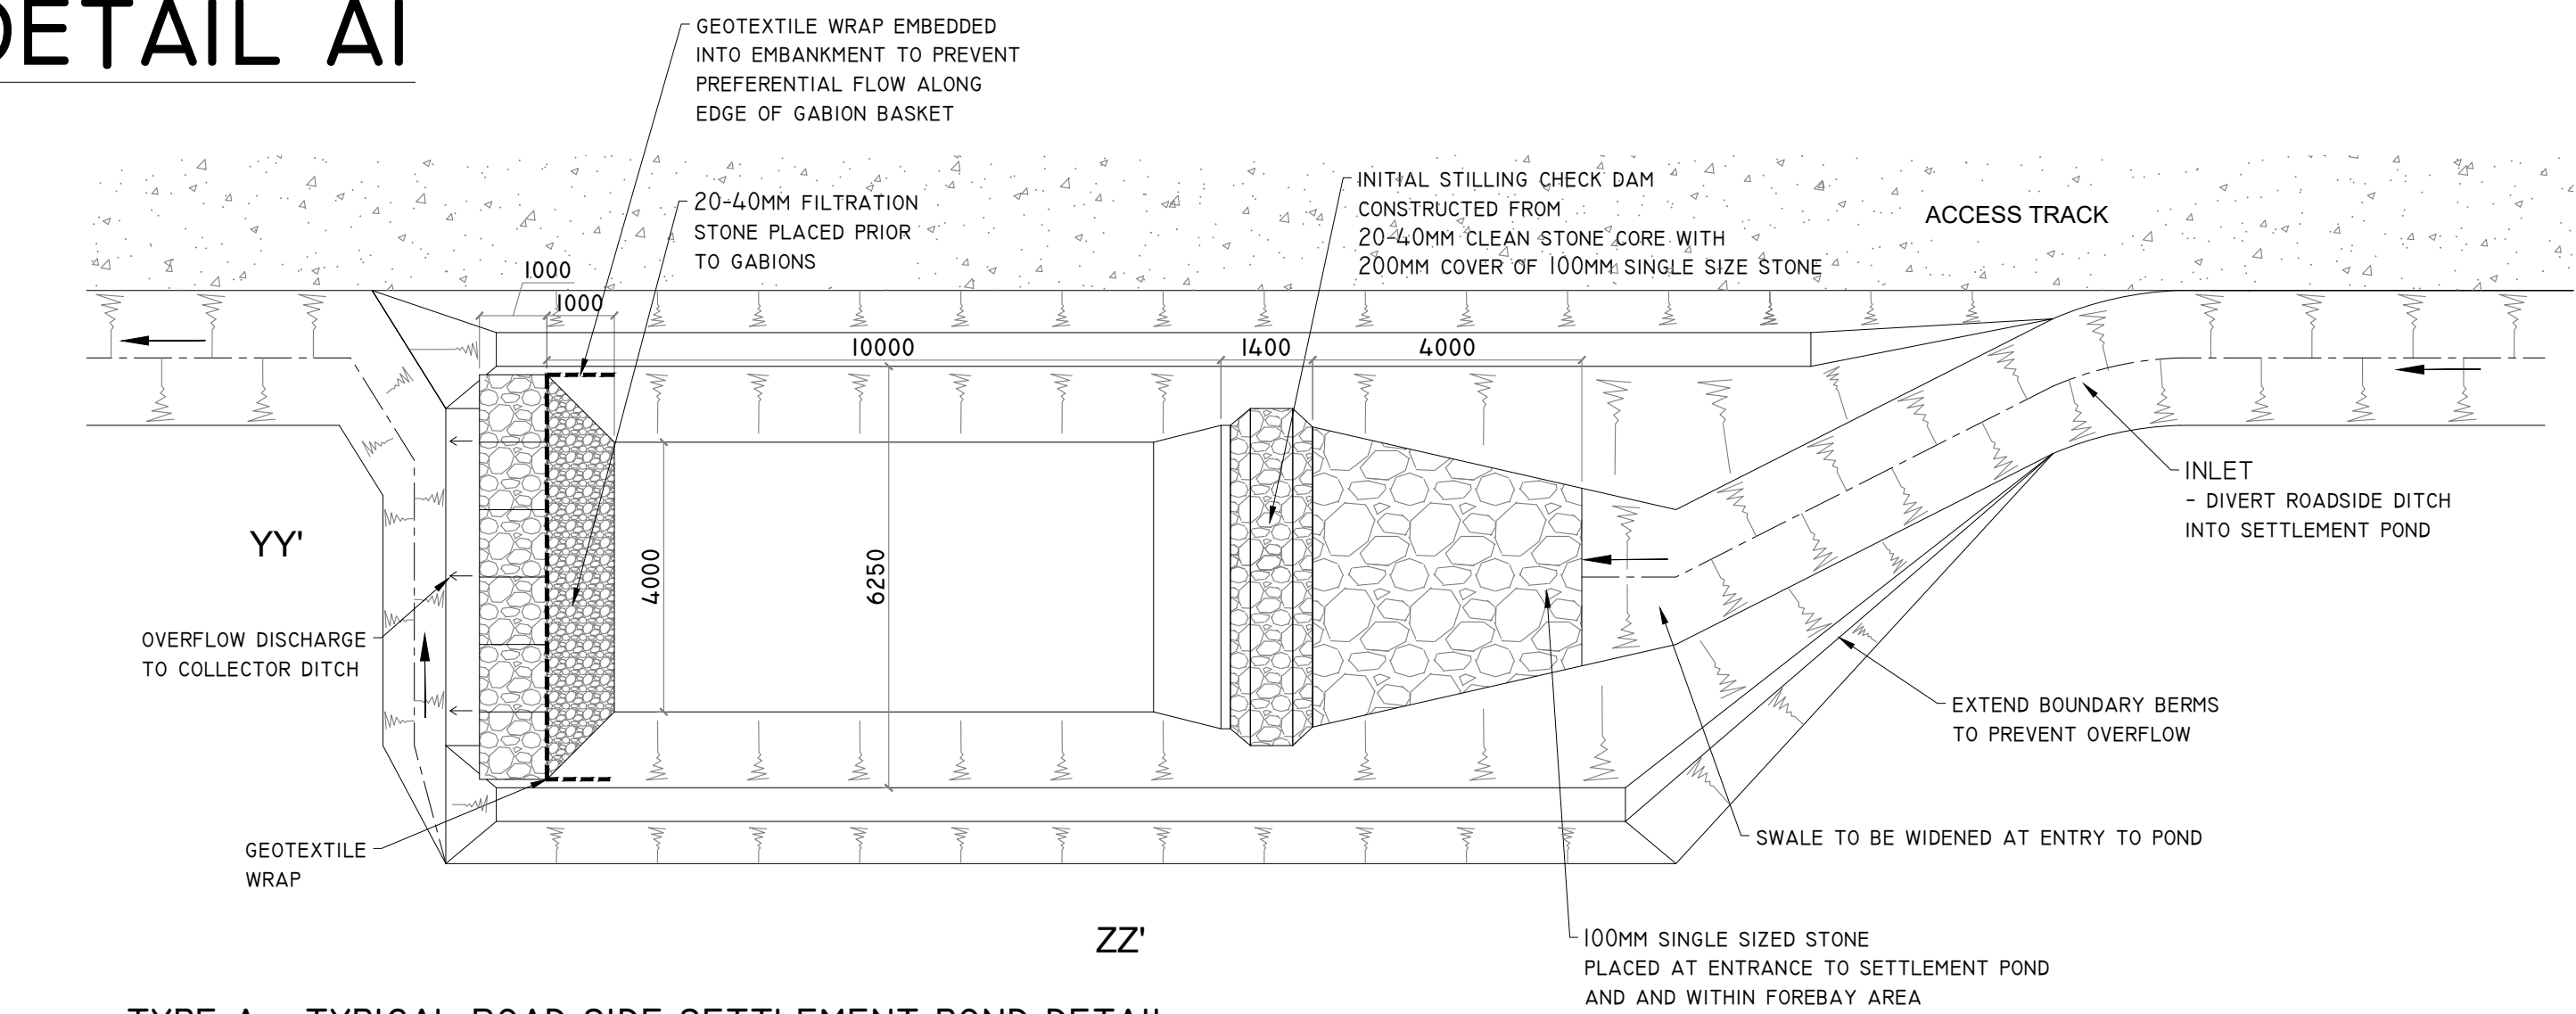


SECTION  
SCALE 1:100

SECTION  
SCALE 1:100


DETAIL A2

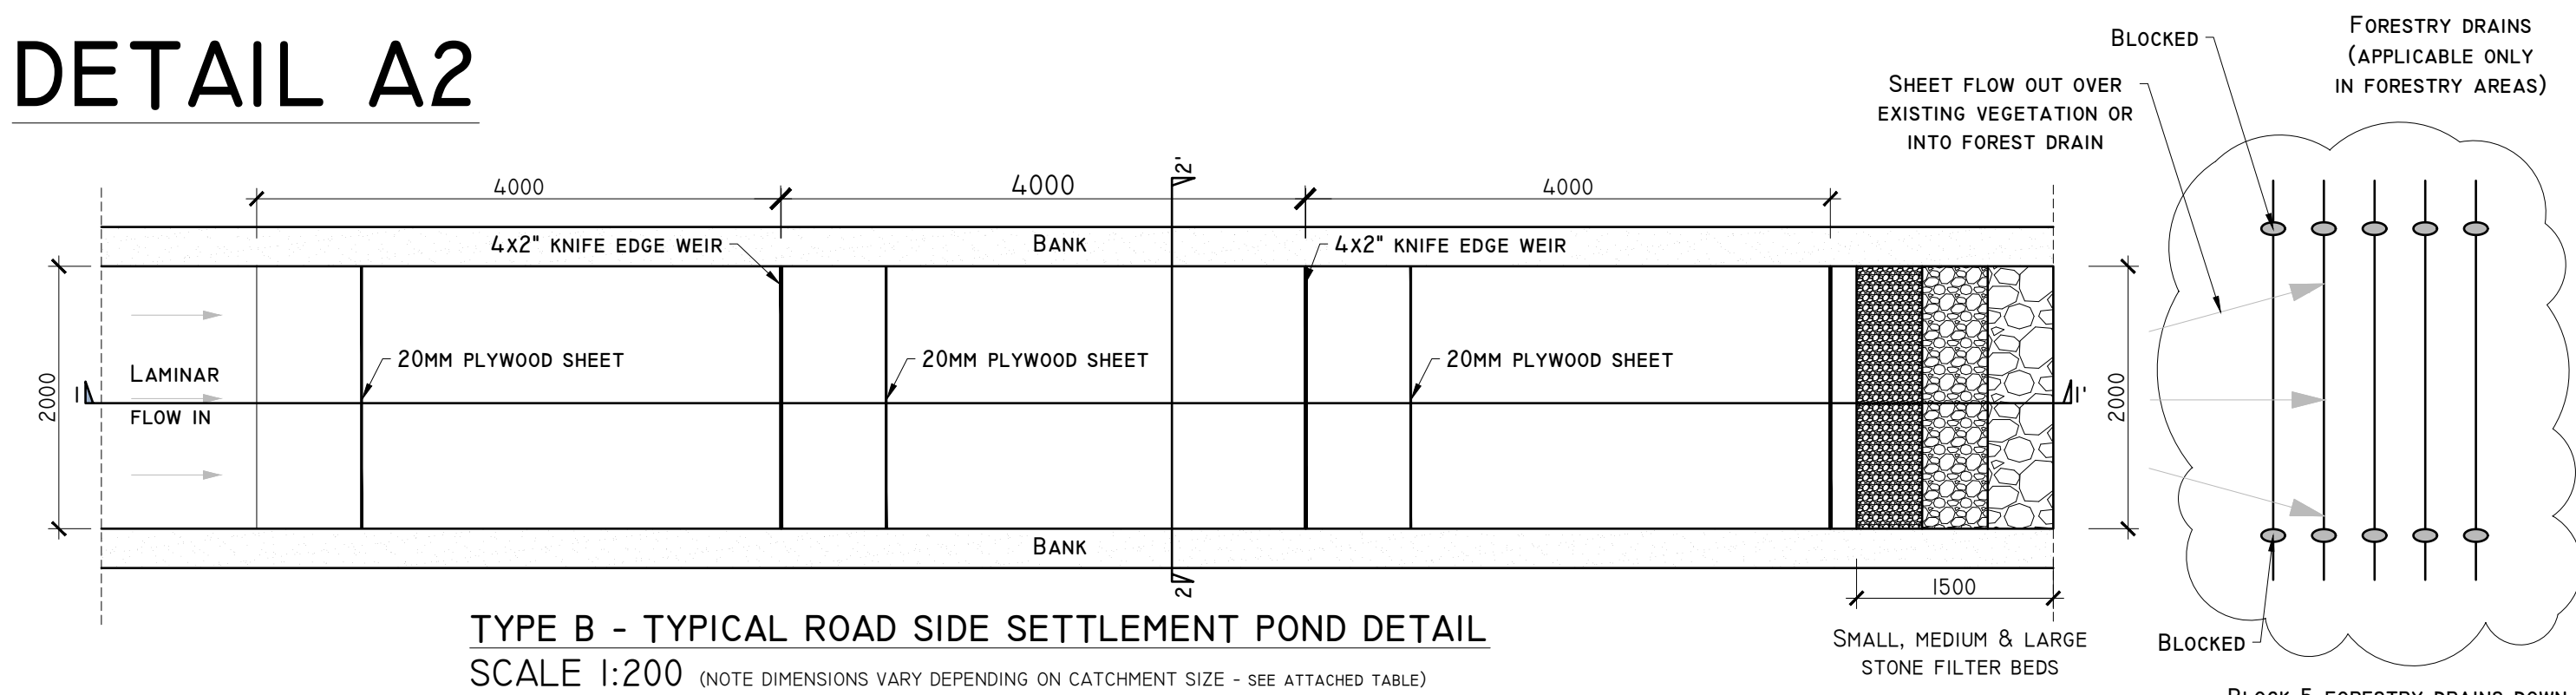


TYPE B - TYPICAL ROAD SIDE SETTLEMENT POND DETAIL  
SCALE 1:200 (NOTE DIMENSIONS VARY DEPENDING ON CATCHMENT SIZE - SEE ATTACHED TABLE)

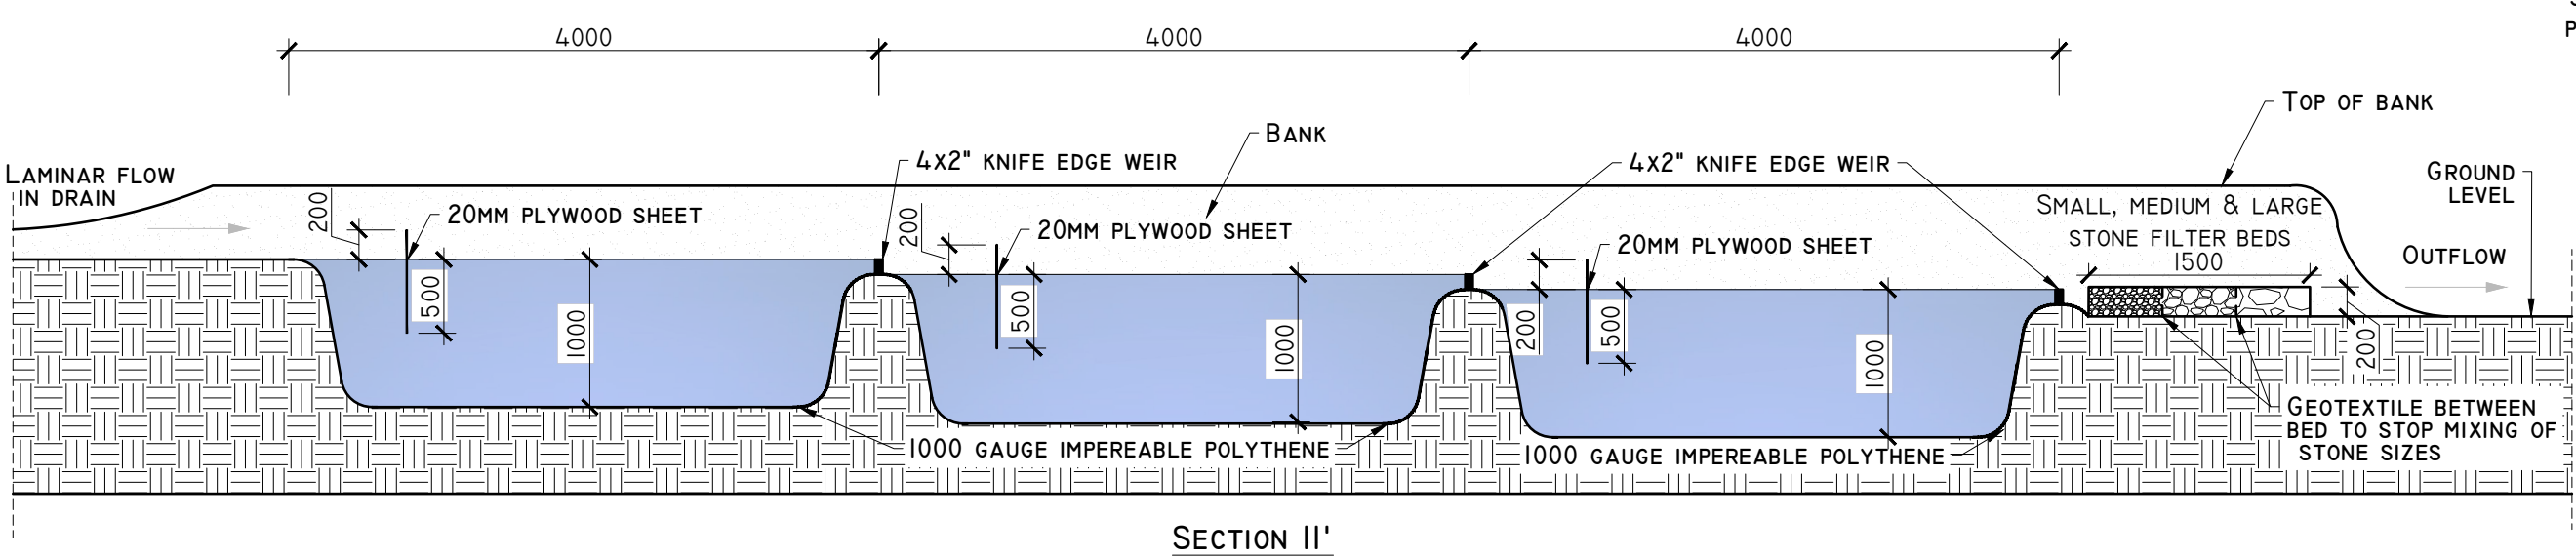

SECTION II'

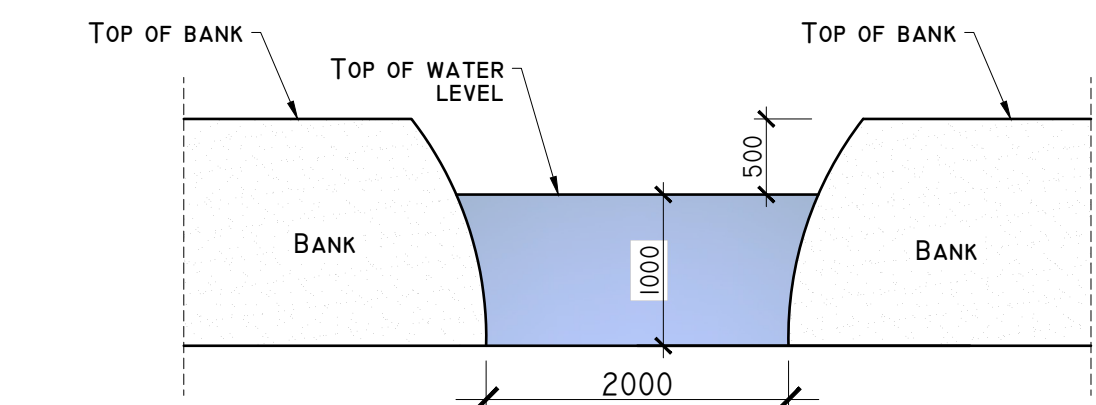


SECTION 22'

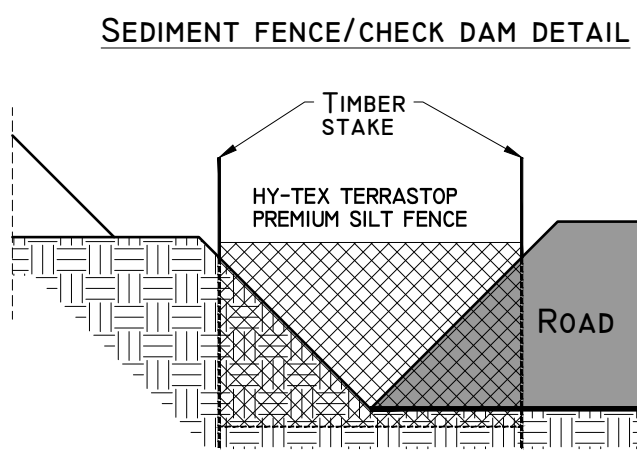


POND SIZE W [m] X L [m] X D [m]			TRACK/HARDSTAND CATCHMENT SIZE (M <sup>2</sup> )		
RETURN PERIOD	10 YRS	STORM DURATION	500	1000	2000
6HR RETENTION FOR COARSE SILT	6 HRS		3.4 x 10.6 x 1 M	4.8 x 15.0 x 1 M	6.9 x 21.0 x 1 M
11HR RETENTION FOR MEDIUM SILT	12 HRS		3.8 x 12.0 x 1 M	5.5 x 16.5 x 1 M	7.5 x 24.2 x 1 M
24HR RETENTION FOR FINE SILT	24 HRS		4.2 x 13.8 x 1 M	6.2 x 18.6 x 1 M	8.6 x 27.0 x 1 M

DETAIL B

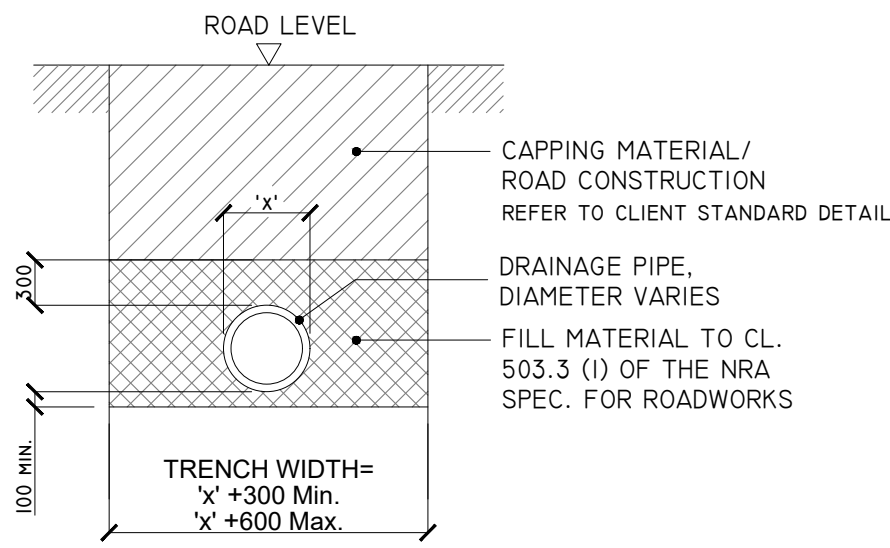


'TYPE B' CULVERT - DRAINAGE CROSSING BENEATH EXCAVATED ROAD  
SCALE 1:50

DETAIL C

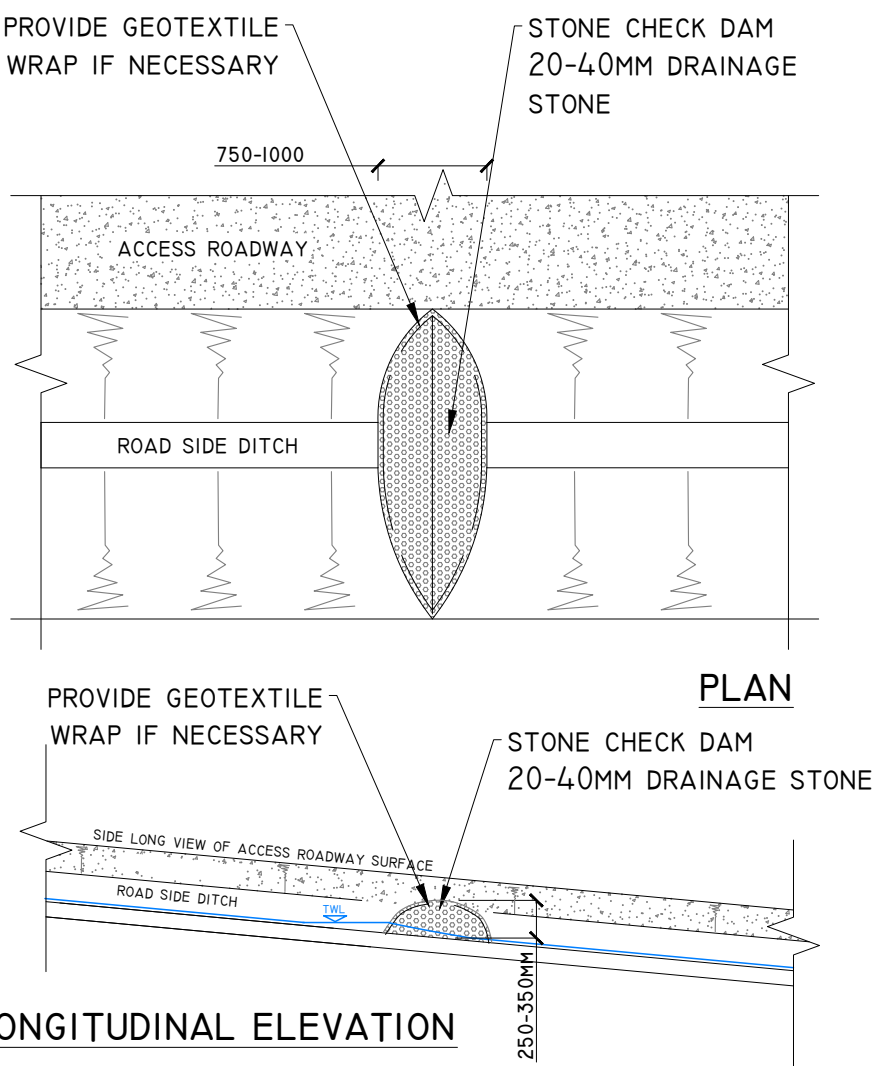


TYPE X - CHECK DAM DETAIL  
SCALE 1:50

DETAIL C1

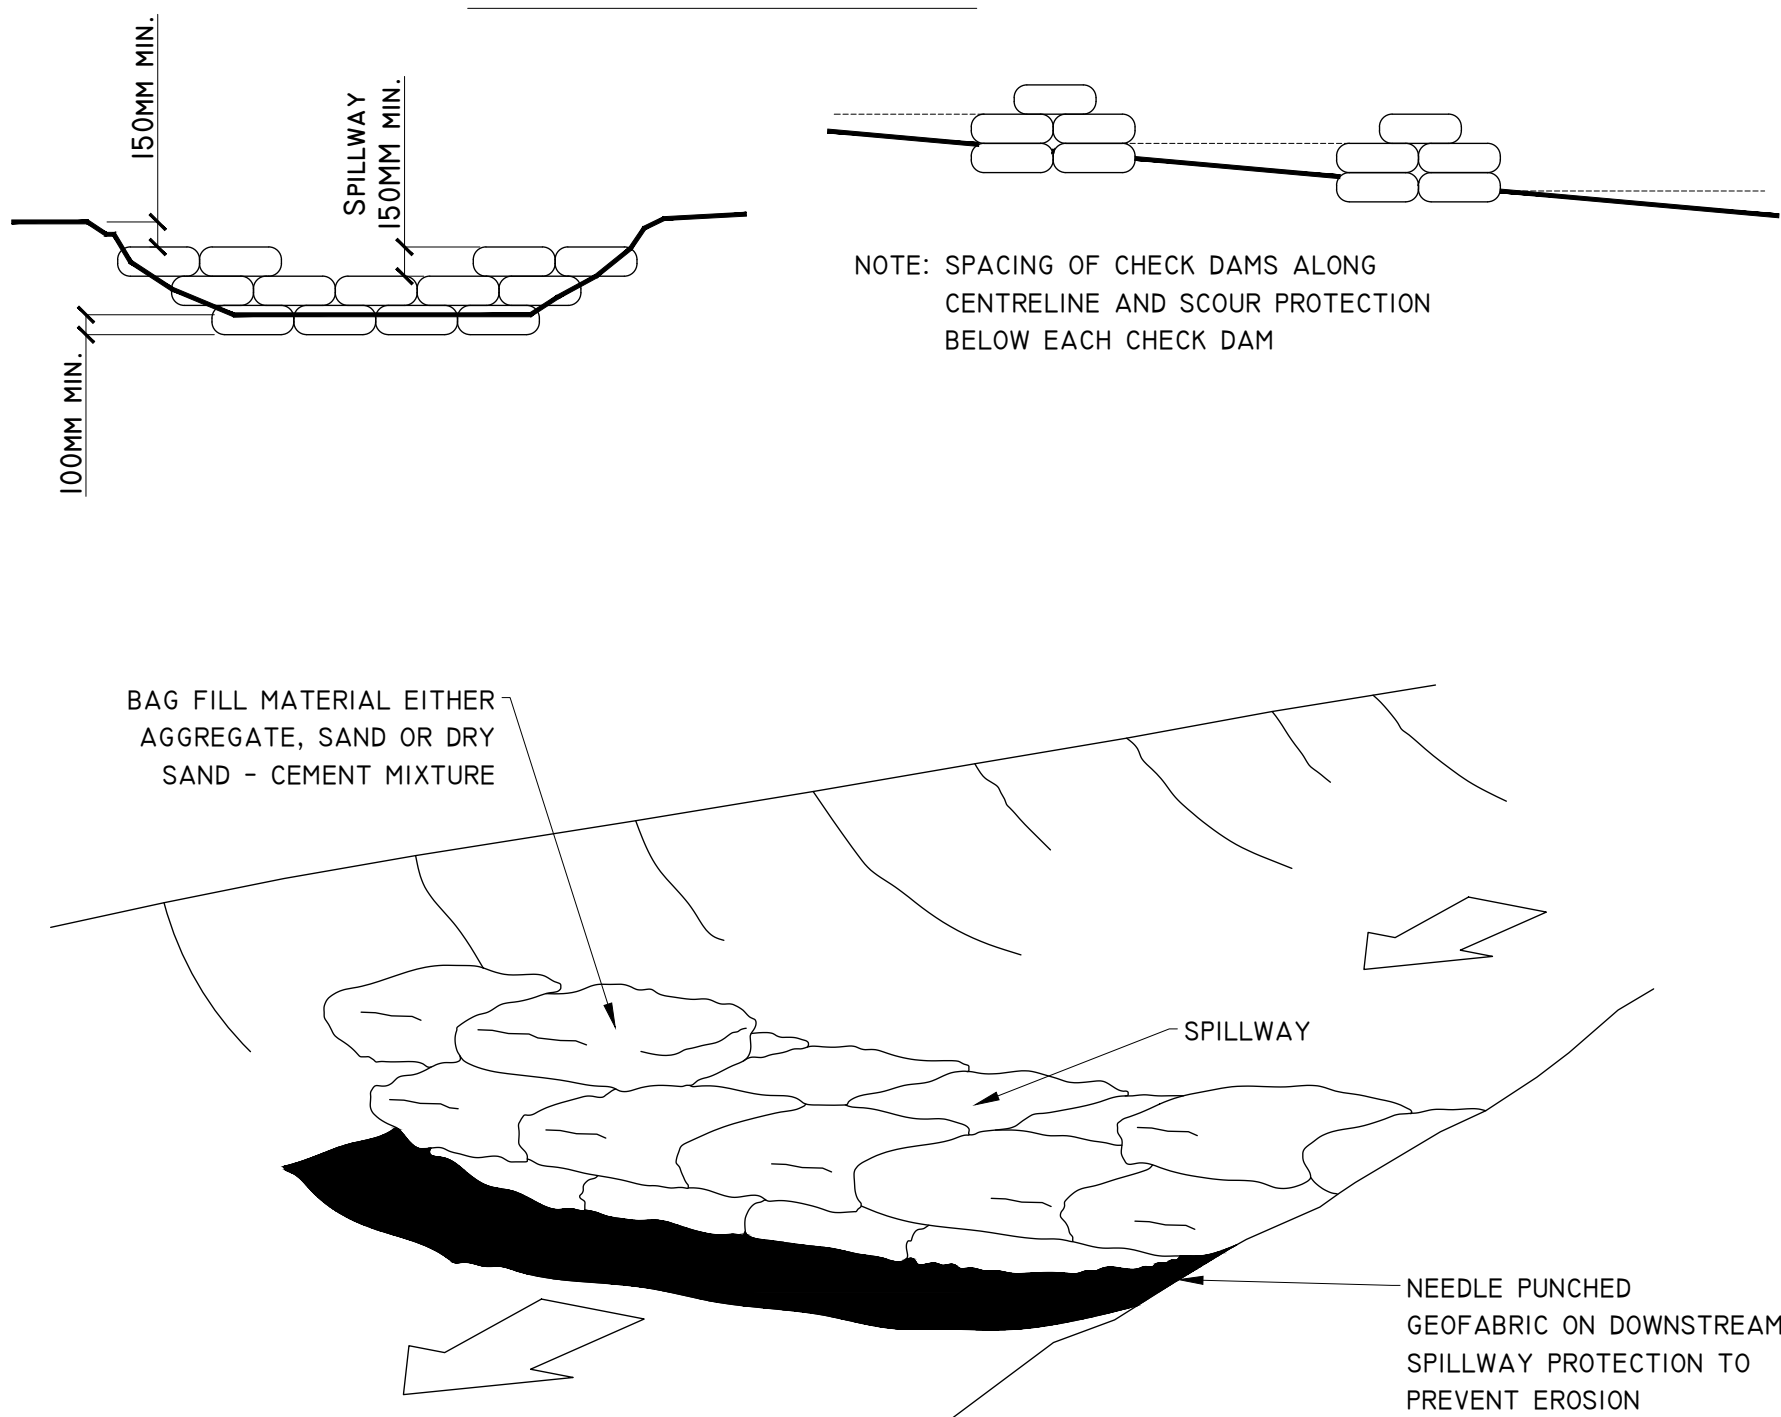


TEMPORARY CHECK DAM / SETTLEMENT POND OVERFLOW  
SAND FILLED BAG CONSTRUCTION  
SCHEMATIC - NOT TO SCALE

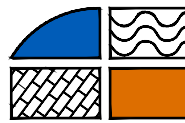10/06/24	Planning	MG	MG
Date	Description	Chkd	Signed
Revisions			
<div><div></div><div><div><b>HYDRO</b> <b>ENVIRONMENTAL</b> <b>SERVICES</b></div><div>22 Lower Main St Dungarvan Co. Waterford Ireland</div></div><div><div>tel: +353 (0) 58-44122 tel: +353 (0) 58-44244 email: info@hydroenvironmental.ie web: www.hydroenvironmental.ie</div></div></div>			
Client:		MKO	
Job:		CLONBERNE, Co. GALWAY	
Title:		DRAINAGE DETAILS I	
Figure No:		D501	
Drawing No: P1599-0-0624-A1-D501-00B			
Sheet Size: A1		Project No.: P1508-0	
Scale: as shown (A1)		Drawn By: MG/GA	
Date: 10/06/2024		Checked By: MG	




DETAIL C2

TEMPORARY CHECK DAM / SETTLEMENT POND OVERFLOW  
SCHEMATIC - NOT TO SCALE

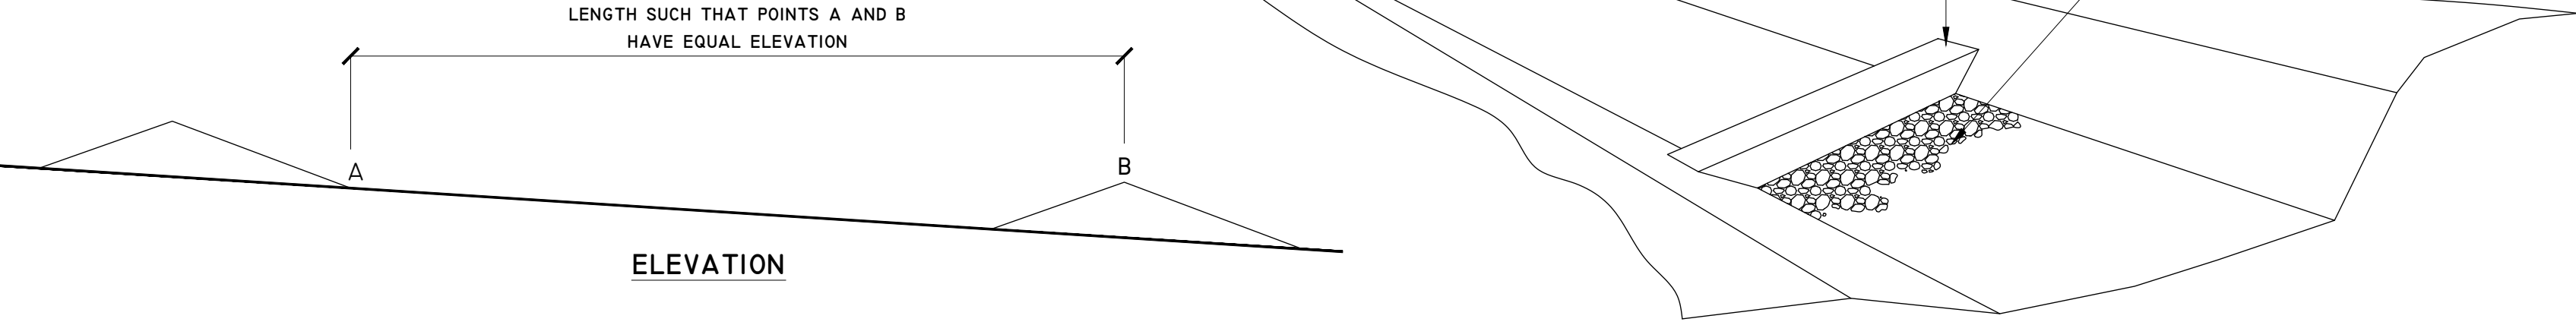


DETAIL F-I

REFER TO HABITAT MANAGEMENT PLAN  
AND PEAT MANAGEMENT PLAN  
FOR STOCKPILE MANAGEMENT NOTES

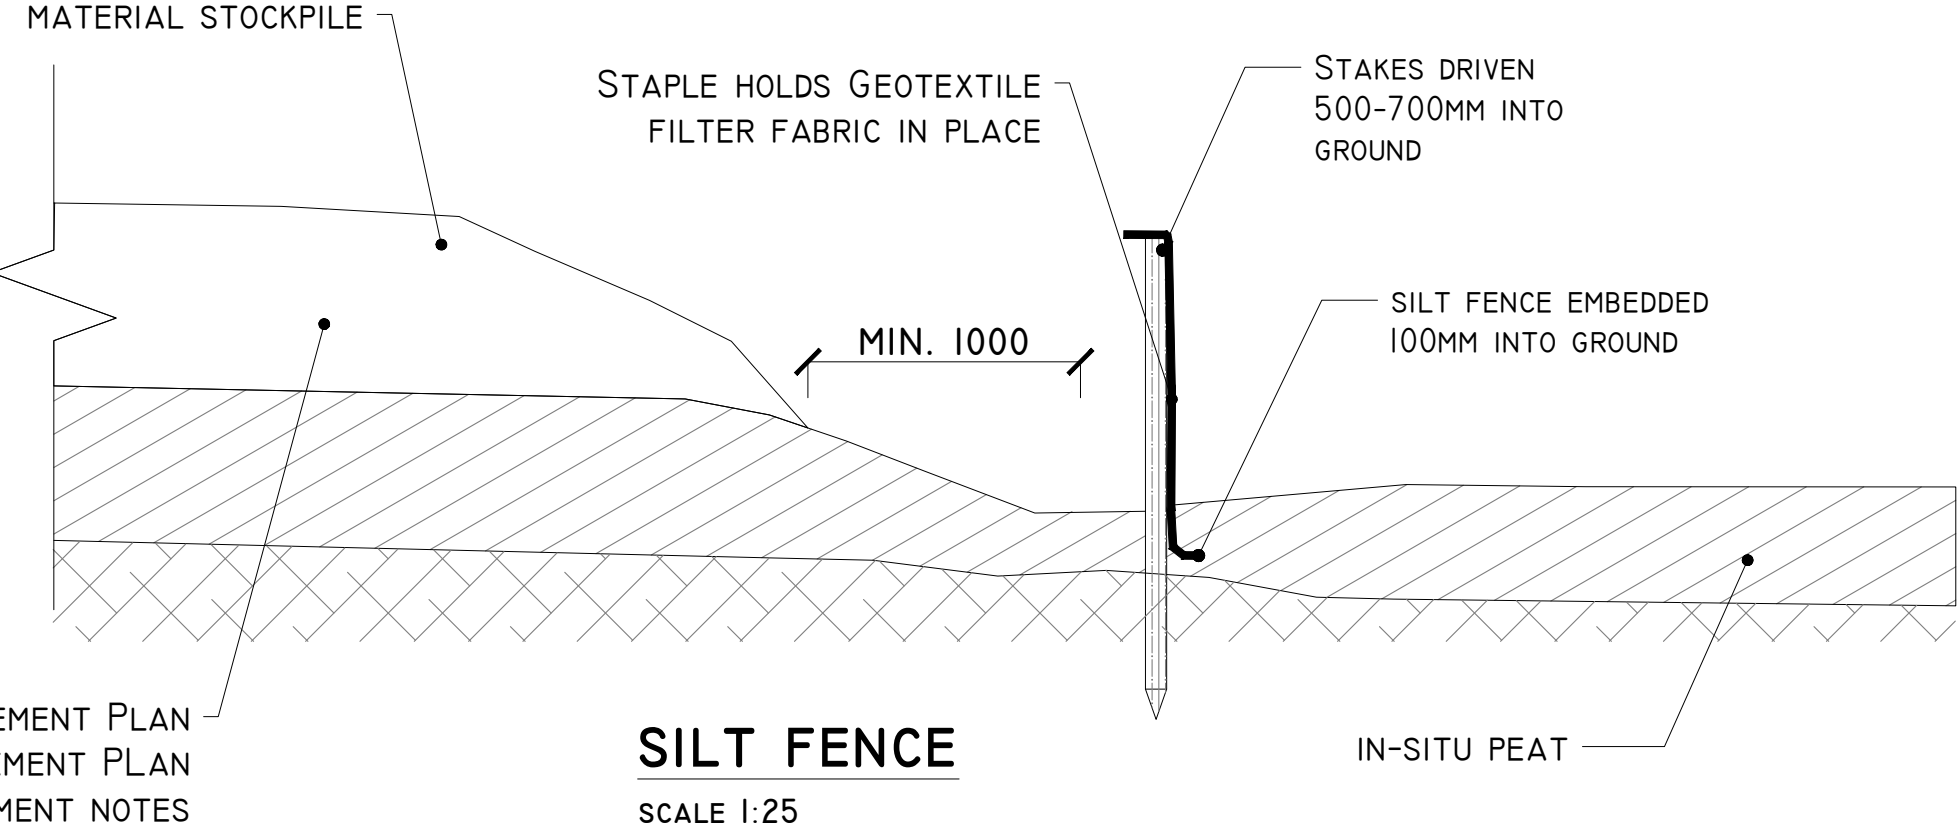


DETAIL D

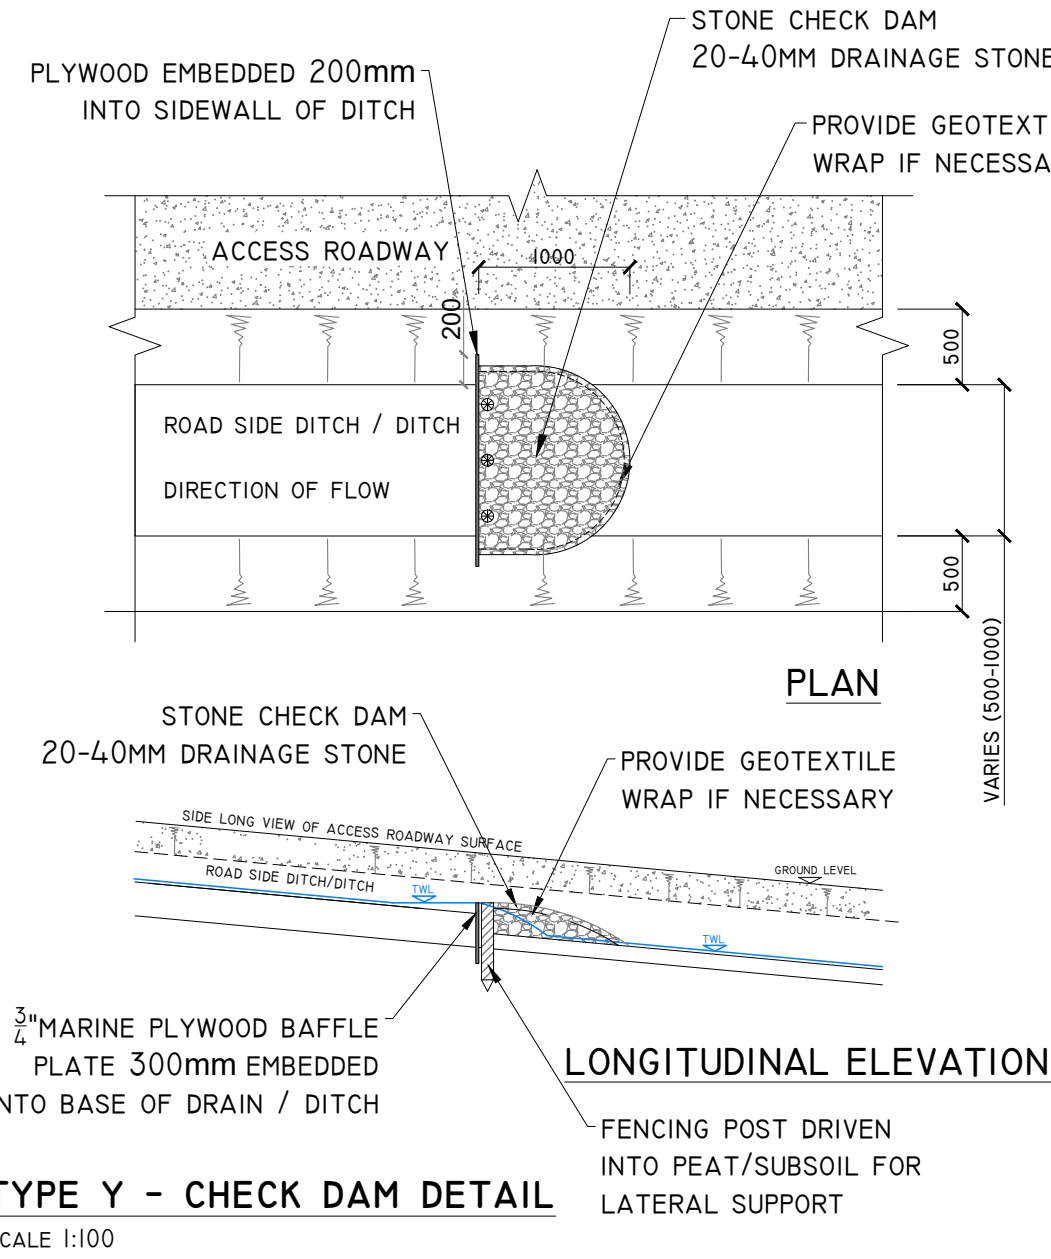


DETAIL G

TYPICAL PIPE SPILLWAY DETAIL  
SCHEMATIC - NOT TO SCALE

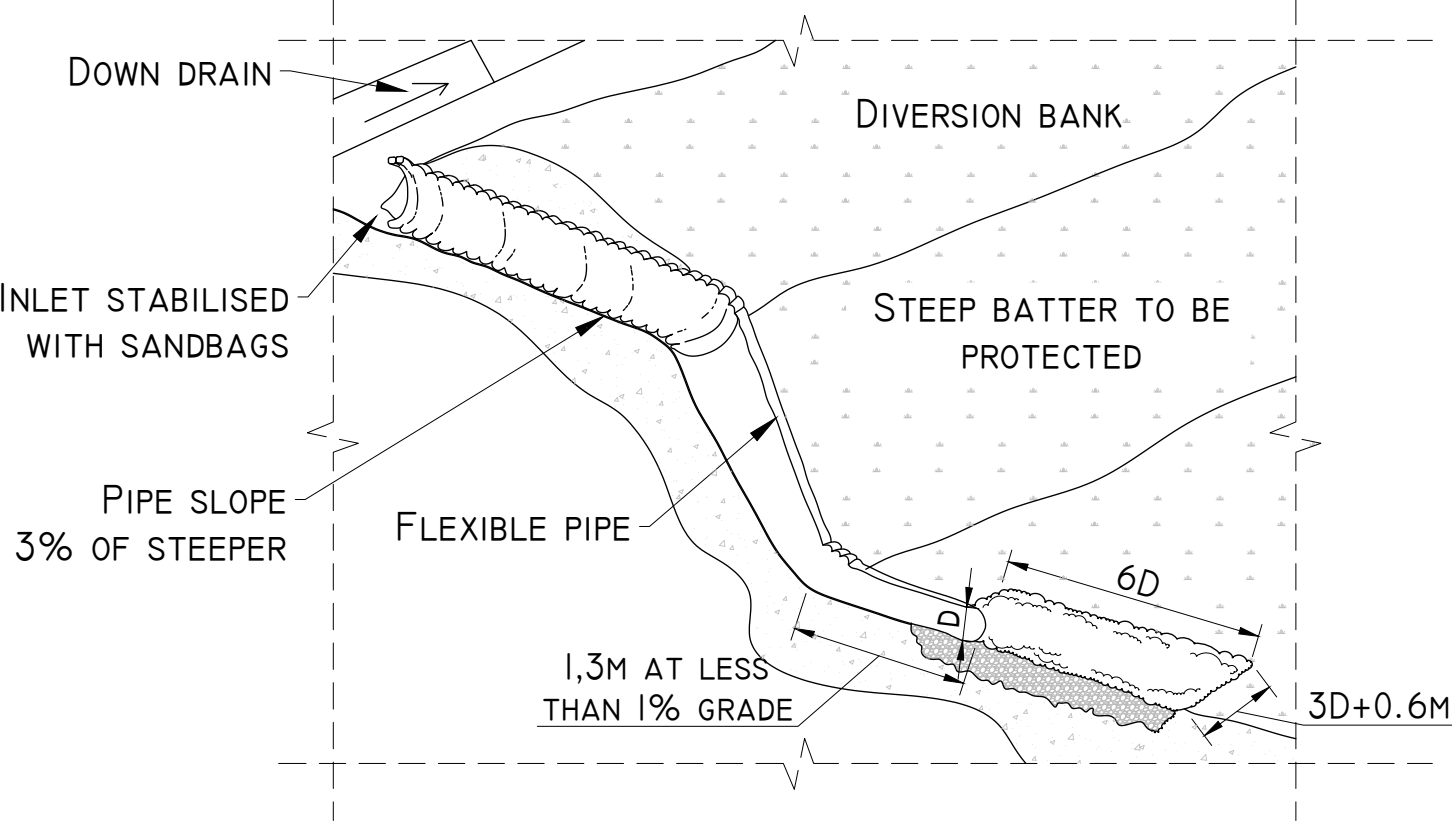


DETAIL F-II

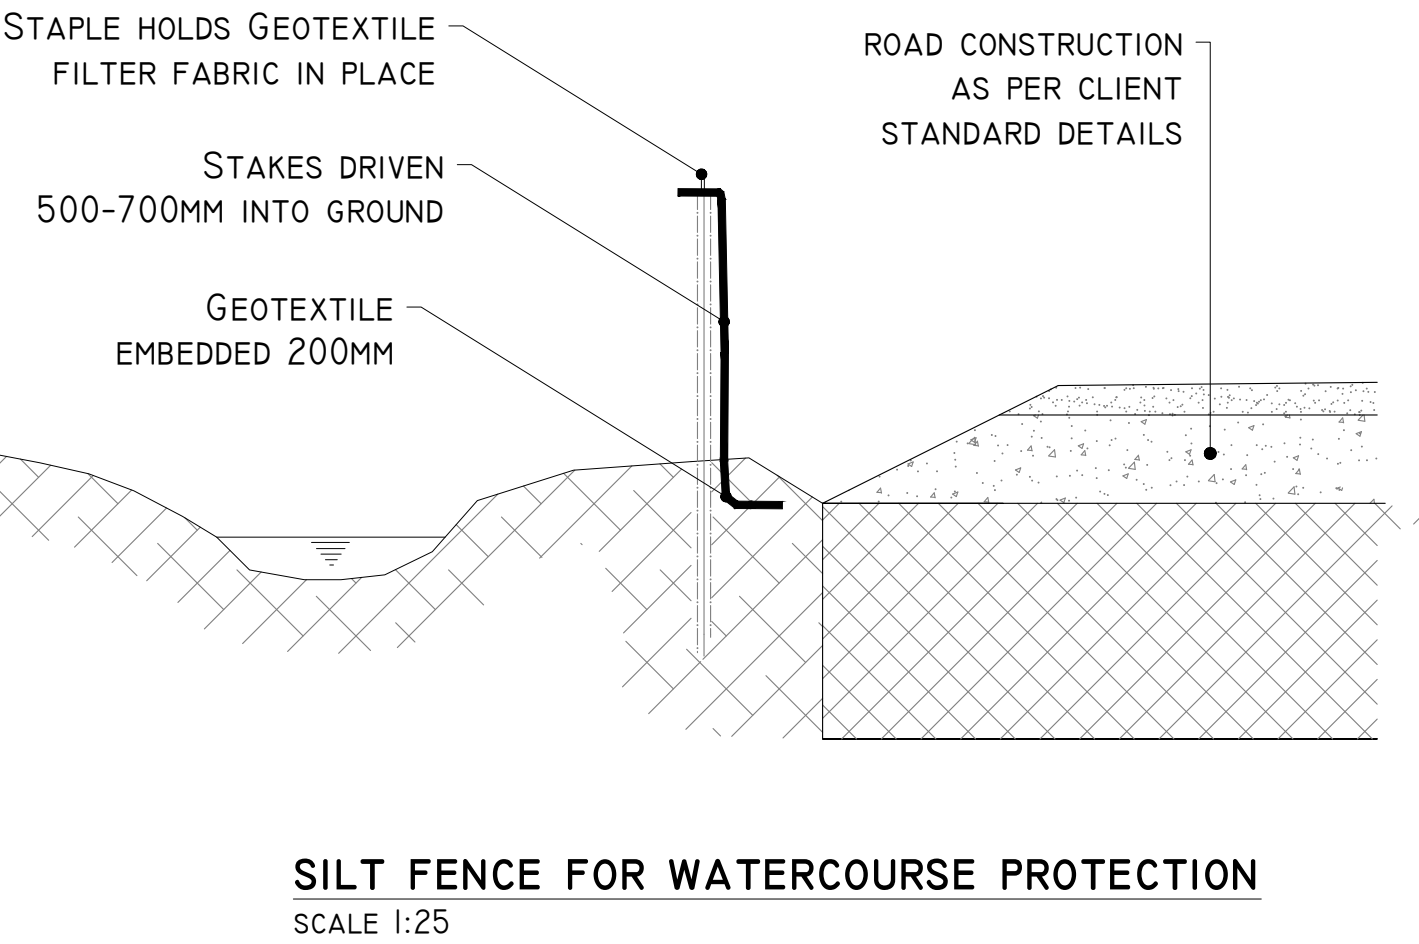

DETAIL J-I


LEVEL SPREADER DETAIL  
SCHEMATIC - NOT TO SCALE

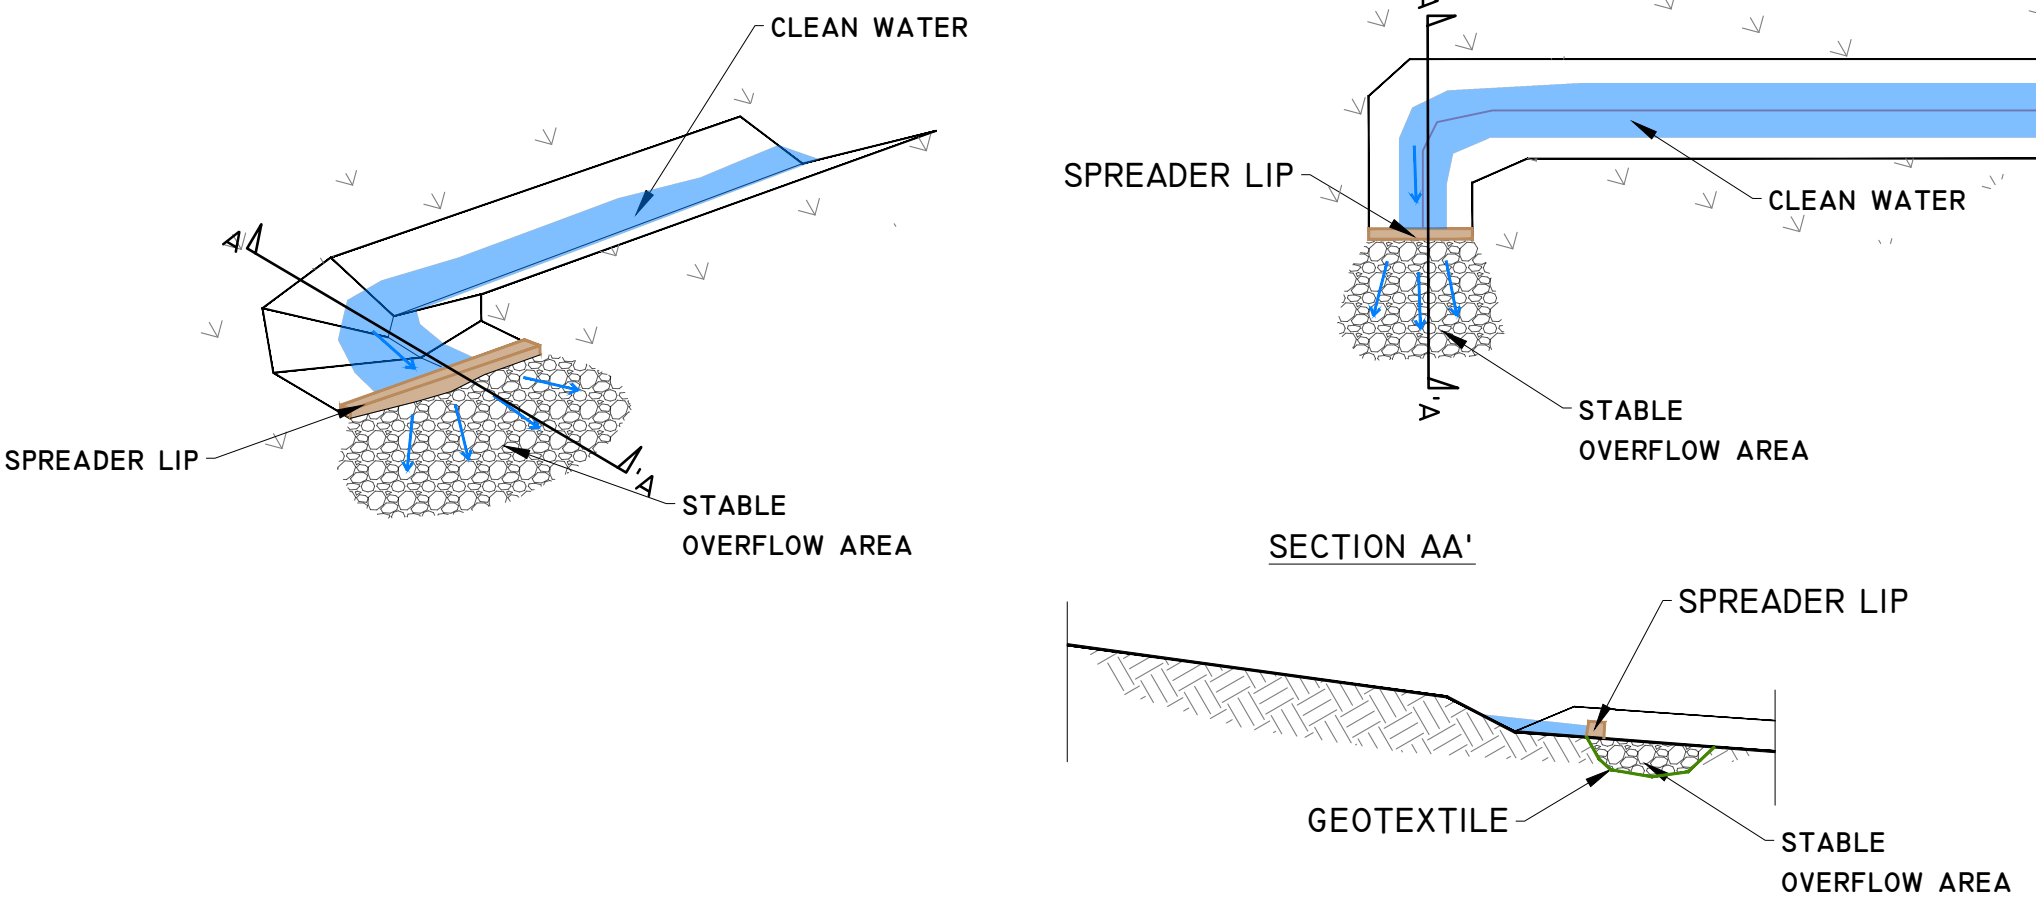


DETAIL I

TEMPORARY CONCRETE WASH OUT PIT  
SCALE 1:50

PLAN

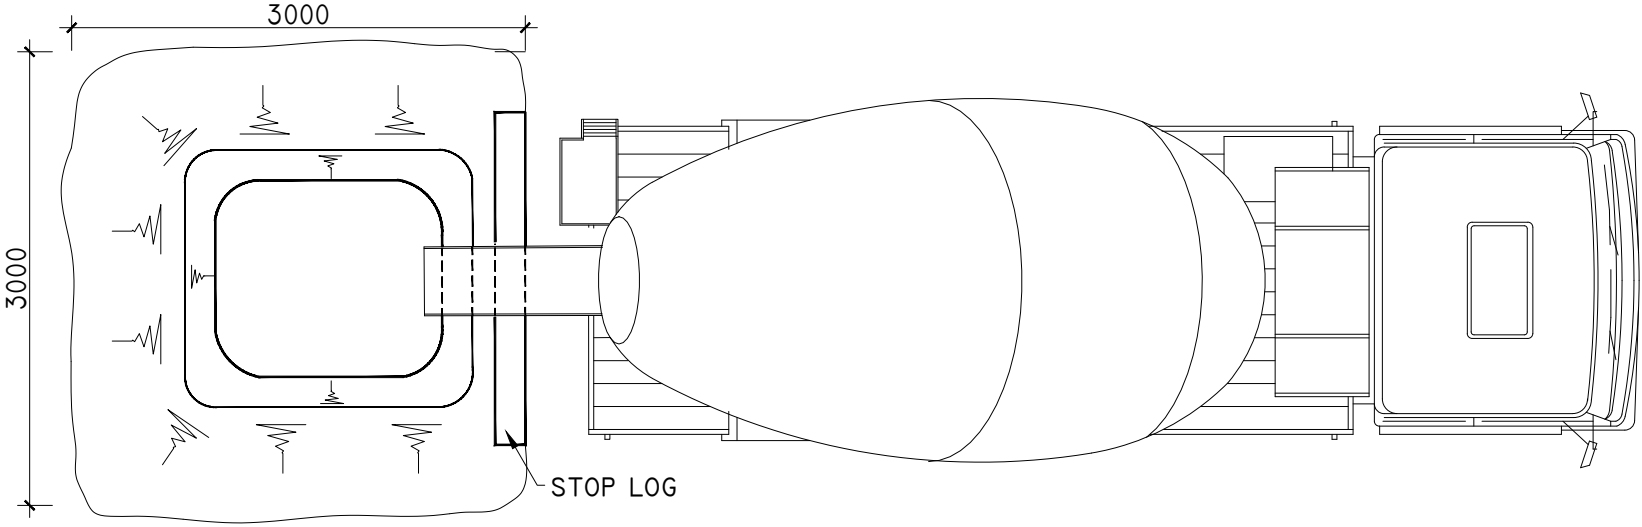


ELEVATION

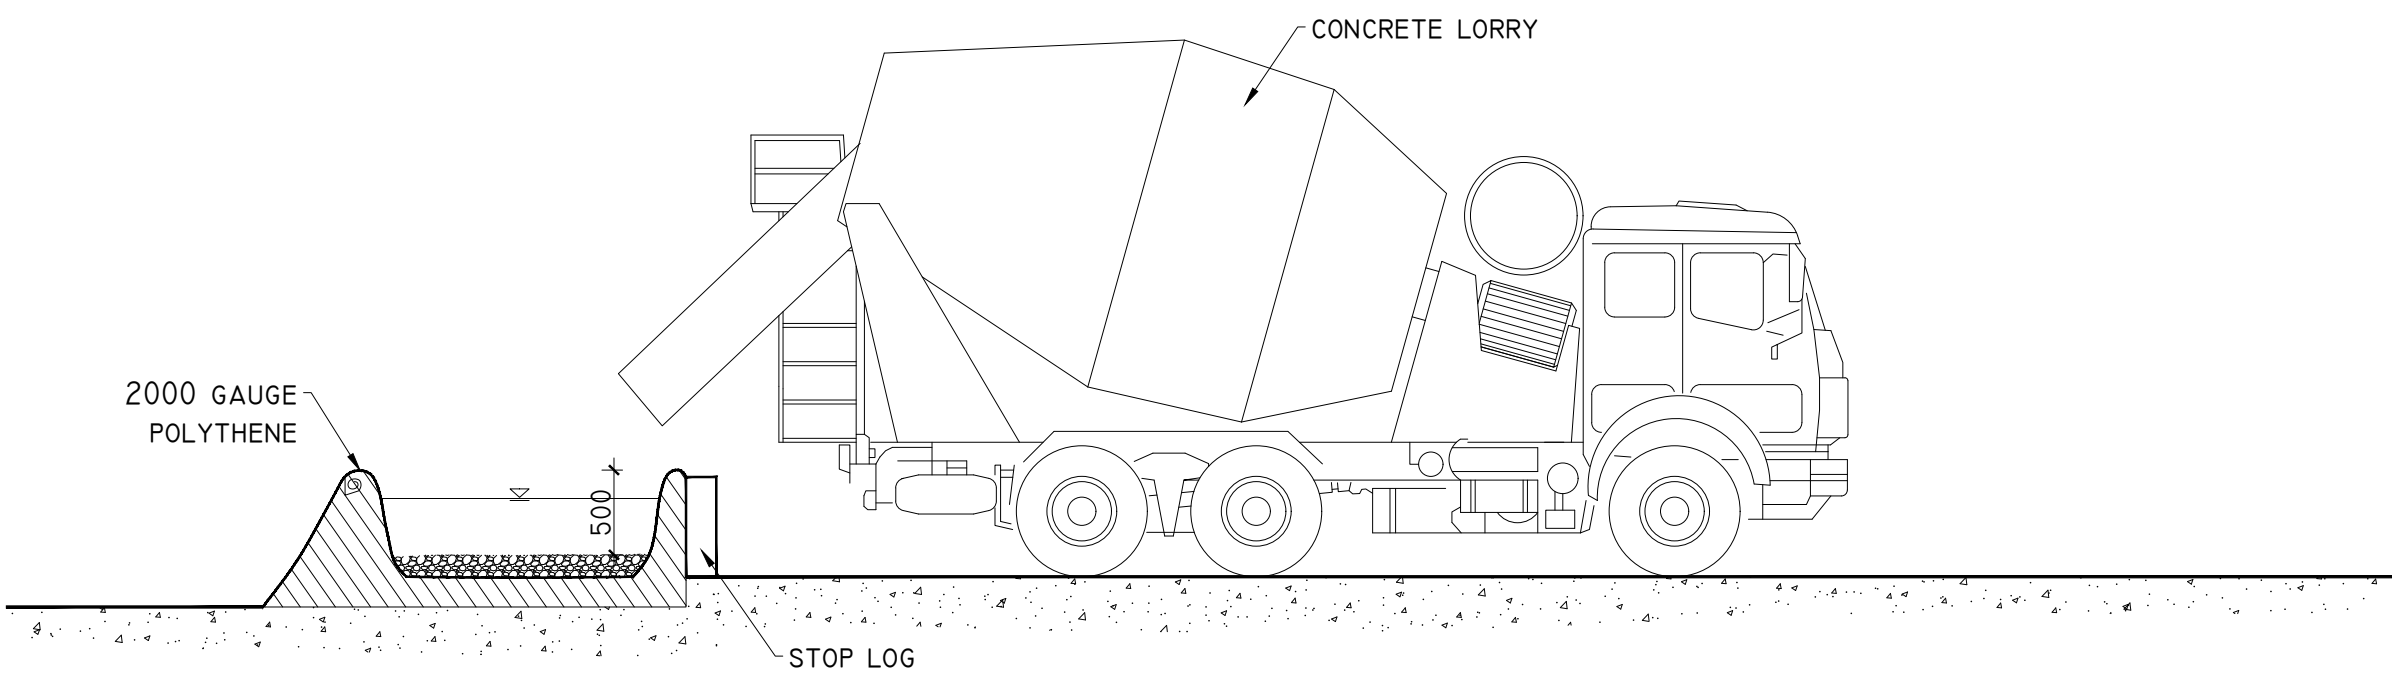

DETAIL J-2

LEVEL SPREADER DETAIL  
SCHEMATIC - NOT TO SCALE

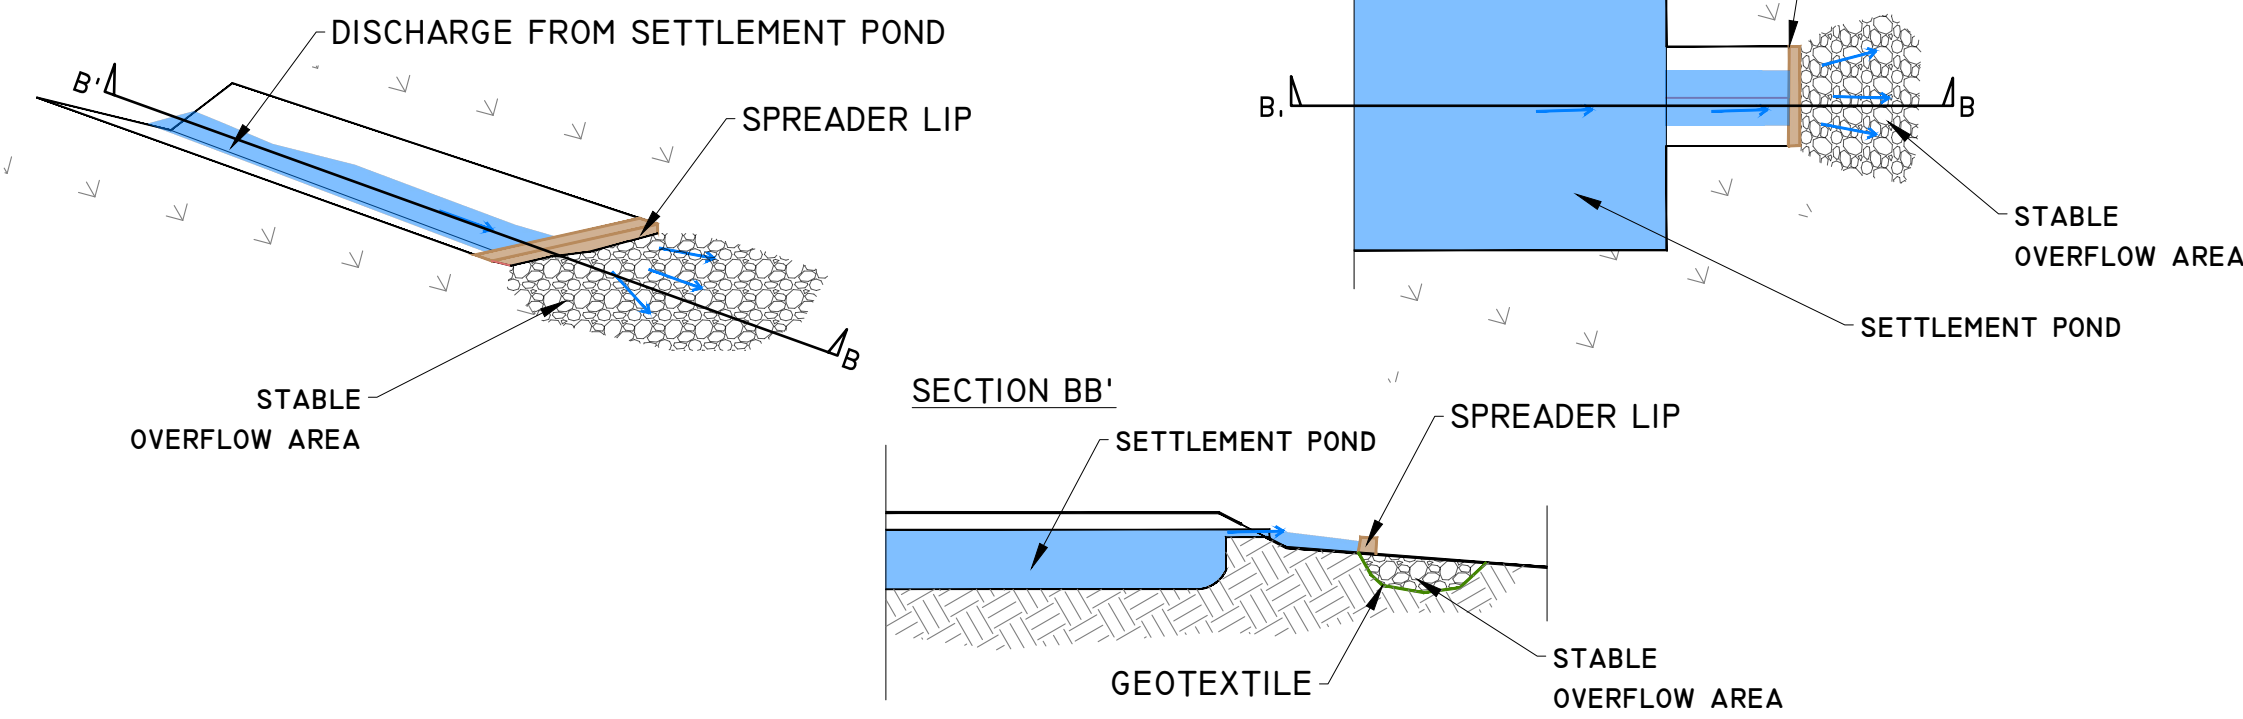

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Date	Description	Chkd	Signed
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Client:	MKO
Job:	CLONBERNE, CO. GALWAY
Title:	DRAINAGE DETAILS 2
Figure No:	D502
Drawing No:	P1508-0624-A1-D502-00B
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